

## IOWA DEPARTMENT OF NATURAL RESOURCES

CONSTRUCTION DRAWINGS  
FOR  
OFFICE & STORAGE BUILDING  
AT  
GREEN VALLEY STATE PARK  
UNION COUNTY, IOWA









PROJECT # 15-04-88-01

PLANS PREPARED BY  
LAND AND WATERS BUREAU  
CONSERVATION AND RECREATION DIVISION

[illegible]

PROJECT DATA – OFFICE BUILDING	PROJECT DATA – STORAGE BUILDING
<p>OCCUPANT LOAD:</p> <p>GROUP B – BUSINESS BUSINESS AREAS – 830 GROSS (IBC TABLE 1004.1.1)</p> <p>GROUP S – STORAGE / ACCESSORY STORAGE AREAS – 25 GROSS (IBC TABLE 1004.1.1) MECHANICAL AREAS – 95 GROSS (IBC TABLE 1004.1.1) GARAGE AREAS – 2,443 GROSS</p> <p>BUSINESS 830 SF / 100 = 8.3 = 9 OCCUPANTS STORAGE 25 SF / 300 = .83 = 1 OCCUPANT ACCESSORY / MECH. 95 SF / 300 = .32 = 1 OCCUPANT GARAGE / STORAGE 2,443 SF / 300 = 8.14 = 9 OCCUPANTS</p> <p>TOTAL OCCUPANT LOAD = 20 OCCUPANTS</p> <p>REQUIRED FIXTURES:</p> <p>1 TOTAL WATER CLOSET (1 UNISEX)</p> <p>WATER CLOSETS – 1 PER 25 FOR FIRST 50 = 1 REQUIRED / 1 PROVIDED LAVATORIES – 1 PER 40 FOR FIRST 80 = 1 REQUIRED / 2 PROVIDED</p>	<p>OCCUPANT LOAD:</p> <p>GROUP S – STORAGE / ACCESSORY STORAGE AREAS – 3,200 GROSS (IBC TABLE 1004.1.1)</p> <p>STORAGE 3,200 SF / 300 = 10.67 = 11 OCCUPANTS</p> <p>TOTAL OCCUPANT LOAD = 11 OCCUPANTS</p> <p>FIRE EXTINGUISHERS: THE NUMBER AND LOCATION OF FIRE EXTINGUISHERS TO BE DETERMINED BY THE FIRE MARSHALL PRIOR TO CERTIFICATE OF OCCUPANCY.</p> <p>BUILDING:</p> <p>ADDRESS: GREEN VALLEY STATE PARK 1480 130TH STREET CRESTON, IA 50801 UNION COUNTY</p> <p>USE – OFFICE / STORAGE BUILDING CONSTRUCTION – TYPE V-B (WITHOUT SPRINKLER SYSTEM) NUMBER OF STORIES – 1 STORY BUILDING HEIGHT – 22'-0" BUILDING AREA – 3,755 GSF BUILDING OCCUPANCY – GROUP B, BUSINESS &amp; GROUP S-1, STORAGE</p>

PROJECT DESCRIPTION	AUTHORIZATION TO BID
GREEN VALLEY STATE PARK IS LOCATED JUST NORTH OF CRESTON, IOWA. THE PARK WILL RECEIVE A NEW OFFICE/SHOP AND STORAGE BUILDING AS SHOWN IN THE DOCUMENTS. THE OFFICE/SHOP WILL HAVE A GARAGE/STORAGE AREA WHICH WILL HAVE THREE IDENTICAL HEATED BAYS. THE OFFICE WILL HAVE ONE LARGE OPEN OFFICE SPACE, ONE STORAGE AREA, ONE RESTROOM, MECHANICAL ROOM AND A TWELVE PERSON CONFERENCE/BREAKROOM. THERE WILL BE A PAVED DRIVE INTO THE GARAGE BAYS AND A STORAGE YARD TO THE REAR OF THE BUILDING. THE PUBLIC ENTRY WILL HAVE A LARGE OVERHANG WITH A DECORATIVE HEAVY TIMBER TRUSS. THIS SITE WILL ALSO RECEIVE A 40' X 80' POST-FRAME STORAGE BUILDING AND WILL HAVE SOME OF ITS EXISTING FACILITIES DEMOLISHED.	<div><div>8/5/15</div></div> <div>ENGINEERING BUREAU CHIEFDATE</div> <div><div>8/5/15</div></div> <div>AUTHORIZED - PARKS   WILDLIFE   FISHERIES   LAW ENFORCEMENTDATE</div>

	<p>I hereby certify that this architectural document was prepared by me or under my direct personal supervision and that I am a duly Registered Professional Architect under the laws of the State of Iowa.</p> <p><i>[Signature]</i> <u>7/29/15</u> RYAN E. RICHEY DATE</p> <p>My license renewal date is June 30, 2017.</p> <p>Pages or sheets covered by this seal: A-001 – A-600</p>
	<p>I hereby certify that this engineering document was prepared by me or under my direct personal supervision and that I am a duly LICENSED Professional ENGINEER under the laws of the State of Iowa.</p> <p><i>[Signature]</i> <u>7/29/15</u> BRETT JOHNSON DATE</p> <p>My license renewal date is DECEMBER 31, 2015.</p> <p>Pages or sheets covered by this seal: C1 – C8</p>
	<p>I hereby certify that this engineering document was prepared by me or under my direct personal supervision and that I am a duly LICENSED Professional ENGINEER under the laws of the State of Iowa.</p> <p><i>[Signature]</i> <u>7/29/15</u> CHAD D. BASS DATE</p> <p>My license renewal date is DECEMBER 31, 2015.</p> <p>Pages or sheets covered by this seal: M0.0 – P2.0</p>
	<p>I hereby certify that this engineering document was prepared by me or under my direct personal supervision and that I am a duly LICENSED Professional ENGINEER under the laws of the State of Iowa.</p> <p><i>[Signature]</i> <u>7/29/15</u> JAMES R. DEEDS IV DATE</p> <p>My license renewal date is DECEMBER 31, 2016.</p> <p>Pages or sheets covered by this seal: E0.0 – E5.0</p>

SHEET INDEX	
SHEET. NO.	SHEET TITLE
	ARCHITECTURAL
A-001	COVER SHEET
A-002	WALL TYPES, NOTES & SYMBOLS
A-003	PROJECT LOCATION
	CIVIL
C1	SURVEY CONTROL
C2	DEMOLITION PLAN
C3	DIMENSION PLAN
C4	GRADING PLAN
C5	GRADING BORROW LOCATION
C6	UTILITY PLAN
C7	JOINTING PLAN
C8	STANDARD DETAILS
	ARCHITECTURAL
A-010	ARCHITECTURAL SITE PLAN
A-020	LIFE SAFETY PLAN
A-100	REFERENCE FLOOR PLAN
A-101	DIMENSION FLOOR PLAN
A-110	REFLECTED CEILING
A-120	EXTERIOR ELEVATIONS
A-121	EXTERIOR ELEVATIONS
A-130	BUILDING SECTIONS AND ROOF DETAILS
A-131	BUILDING SECTIONS
A-140	ENLARGED FLOOR PLAN
A-141	INTERIOR ELEVATIONS & MILLWORK SECTIONS
A-202	LIFE SAFETY PLAN
A-210	REFERENCE FLOOR PLAN
A-220	BUILDING ELEVATIONS
A-230	BUILDING SECTIONS
A-600	FINISH, DOOR & WINDOW SCHEDULES
	MECHANICAL
M0.0	MECHANICAL SYMBOLS AND NOTES
M1.0	OFFICE FLOOR PLAN – MECHANICAL
M2.0	MECHANICAL DETAILS
M3.0	MECHANICAL SCHEDULES
	PLUMBING
P0.0	OFFICE UNDERFLOOR PLAN – PLUMBING
P1.0	OFFICE FLOOR PLAN – PLUMBING
P1.1	STORAGE FLOOR PLAN – PLUMBING
P2.0	PLUMBING SCHEDULES AND DETAILS
	ELECTRICAL
E0.0	ELECTRICAL SYMBOLS, NOTES & SITE PLAN
E1.0	OFFICE FLOOR PLAN – LIGHTING
E2.0	OFFICE FLOOR PLAN – POWER
E3.0	STORAGE FLOOR PLAN – ELECTRICAL
E4.0	ELECTRICAL DETAILS
E5.0	ELECTRICAL SCHEDULES

BID ITEMS		
ITEM NUMBER	ITEM DESCRIPTION	ESTIMATED QUANTITY
1	DEMOLITION	1 LS
2	TREE CLEARING AND GRUBBING	1 LS
3	FULL DEPTH SAW CUT	202 LF
4	GRADING	1 LS
5	SEEDING, FERTILIZING AND MULCHING	1 LS
6	8" FILTER SOCK	444 LF
7	4" SANITARY SEWER SERVICE (PVC SDR 23.5)	59 LF
8	SANITARY SEWER SERVICE CLEANOUTS	1 EA
9	3X3X2 TAPPING TEE WITH VALVE	1 EA
10	2" HDPE WATER MAIN	246 LF
11	1" HDPE WATER SERVICE	14 LF
12	2X2X1 HDPE TEE	1 EA
13	WOODFORD MODEL S-3 SANITARY YARD HYDRANTS	1 EA
14	4" PVC SDR 23.5	34 LF
15	1" LP SERVICE LINE	120 LF
16	CLASS "A" CRUSHED STONE	543 TON
17	GRANULAR BASE FOR PAVEMENT	31 TON
18	5" REINFORCED PCC SIDEWALK PAVEMENT	75 SY
19	6" REINFORCED PCC PAVEMENT	50 SY
20	PRECAST CONCRETE WHEEL STOPS	4 EA
21	ELECTRICAL SERVICE	1 LS
22	PAINT STRIPING & HANDICAP SIGNAGE	1 LS
23	BLACK PVC COATED CHAIN LINK FENCING	1 LS
24	OFFICE BUILDING	1 LS
25	STORAGE BUILDING	1 LS
26	SIDE AND ROOF EXISTING BUILDING	1 LS
27	NPDES GENERAL PERMIT #2	1 LS
28	WATER LEAK REPAIR AT WATER METER PIT	1 LS
29	CONSTRUCTION STAKING	1 LS
30	MOBILIZATION	1 LS

**IOWA DEPARTMENT OF  
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ENGINEERING SERVICES - WALLACE BULLING  
502 E. 9TH ST., DES MOINES, IA 50319-0034  
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F: 515.725.8202



COVER SHEET

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NEW OFFICE & STORAGE BUILDING FOR:  
**GREEN VALLEY STATE PARK**

UNION COUNTY, IOWA


1480 130TH STREET

**A-001**







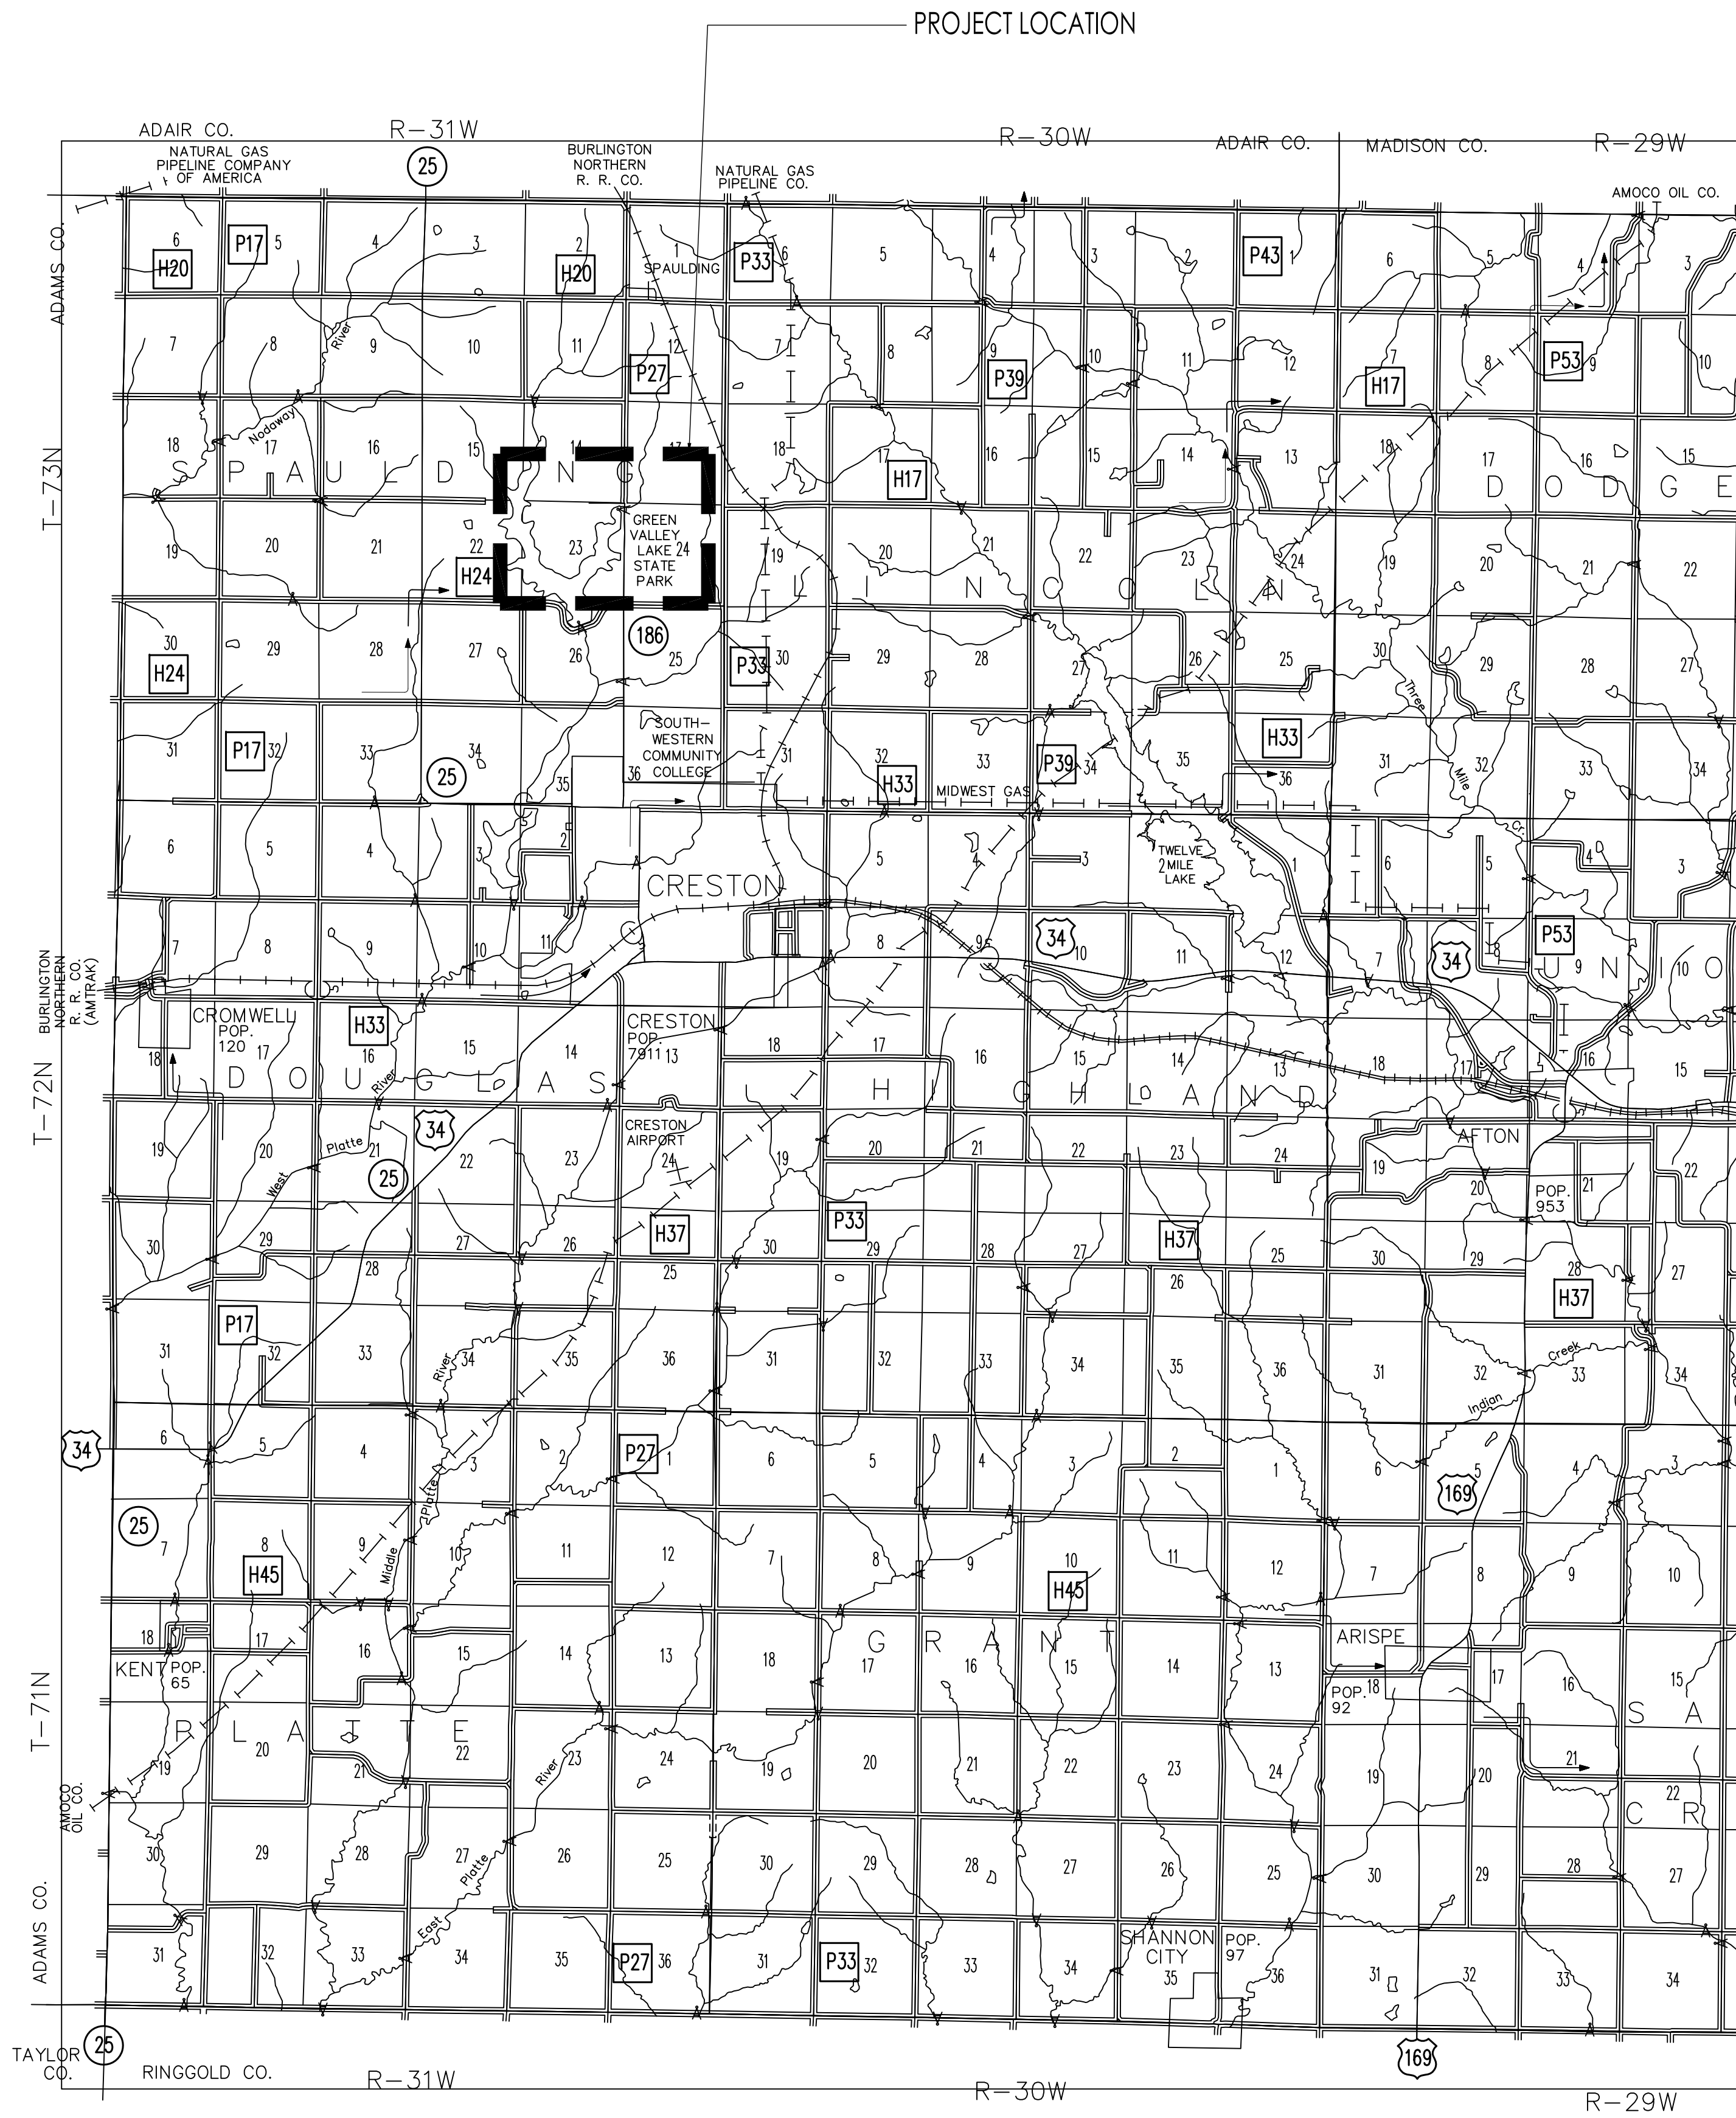

CONSULTANT:

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PROJECT LOCATION

NEW OFFICE & STORAGE BUILDING FOR:

GREEN VALLEY STATE PARK

UNION COUNTY, IOWA  
1480 130TH STREET

NO. BY DATE REVISION

DRAWN BY: PROJECT NUMBER:  
15-04-88-01

CHK'D BY: DATE:  
07.29.2015

SHEET No:

A-003












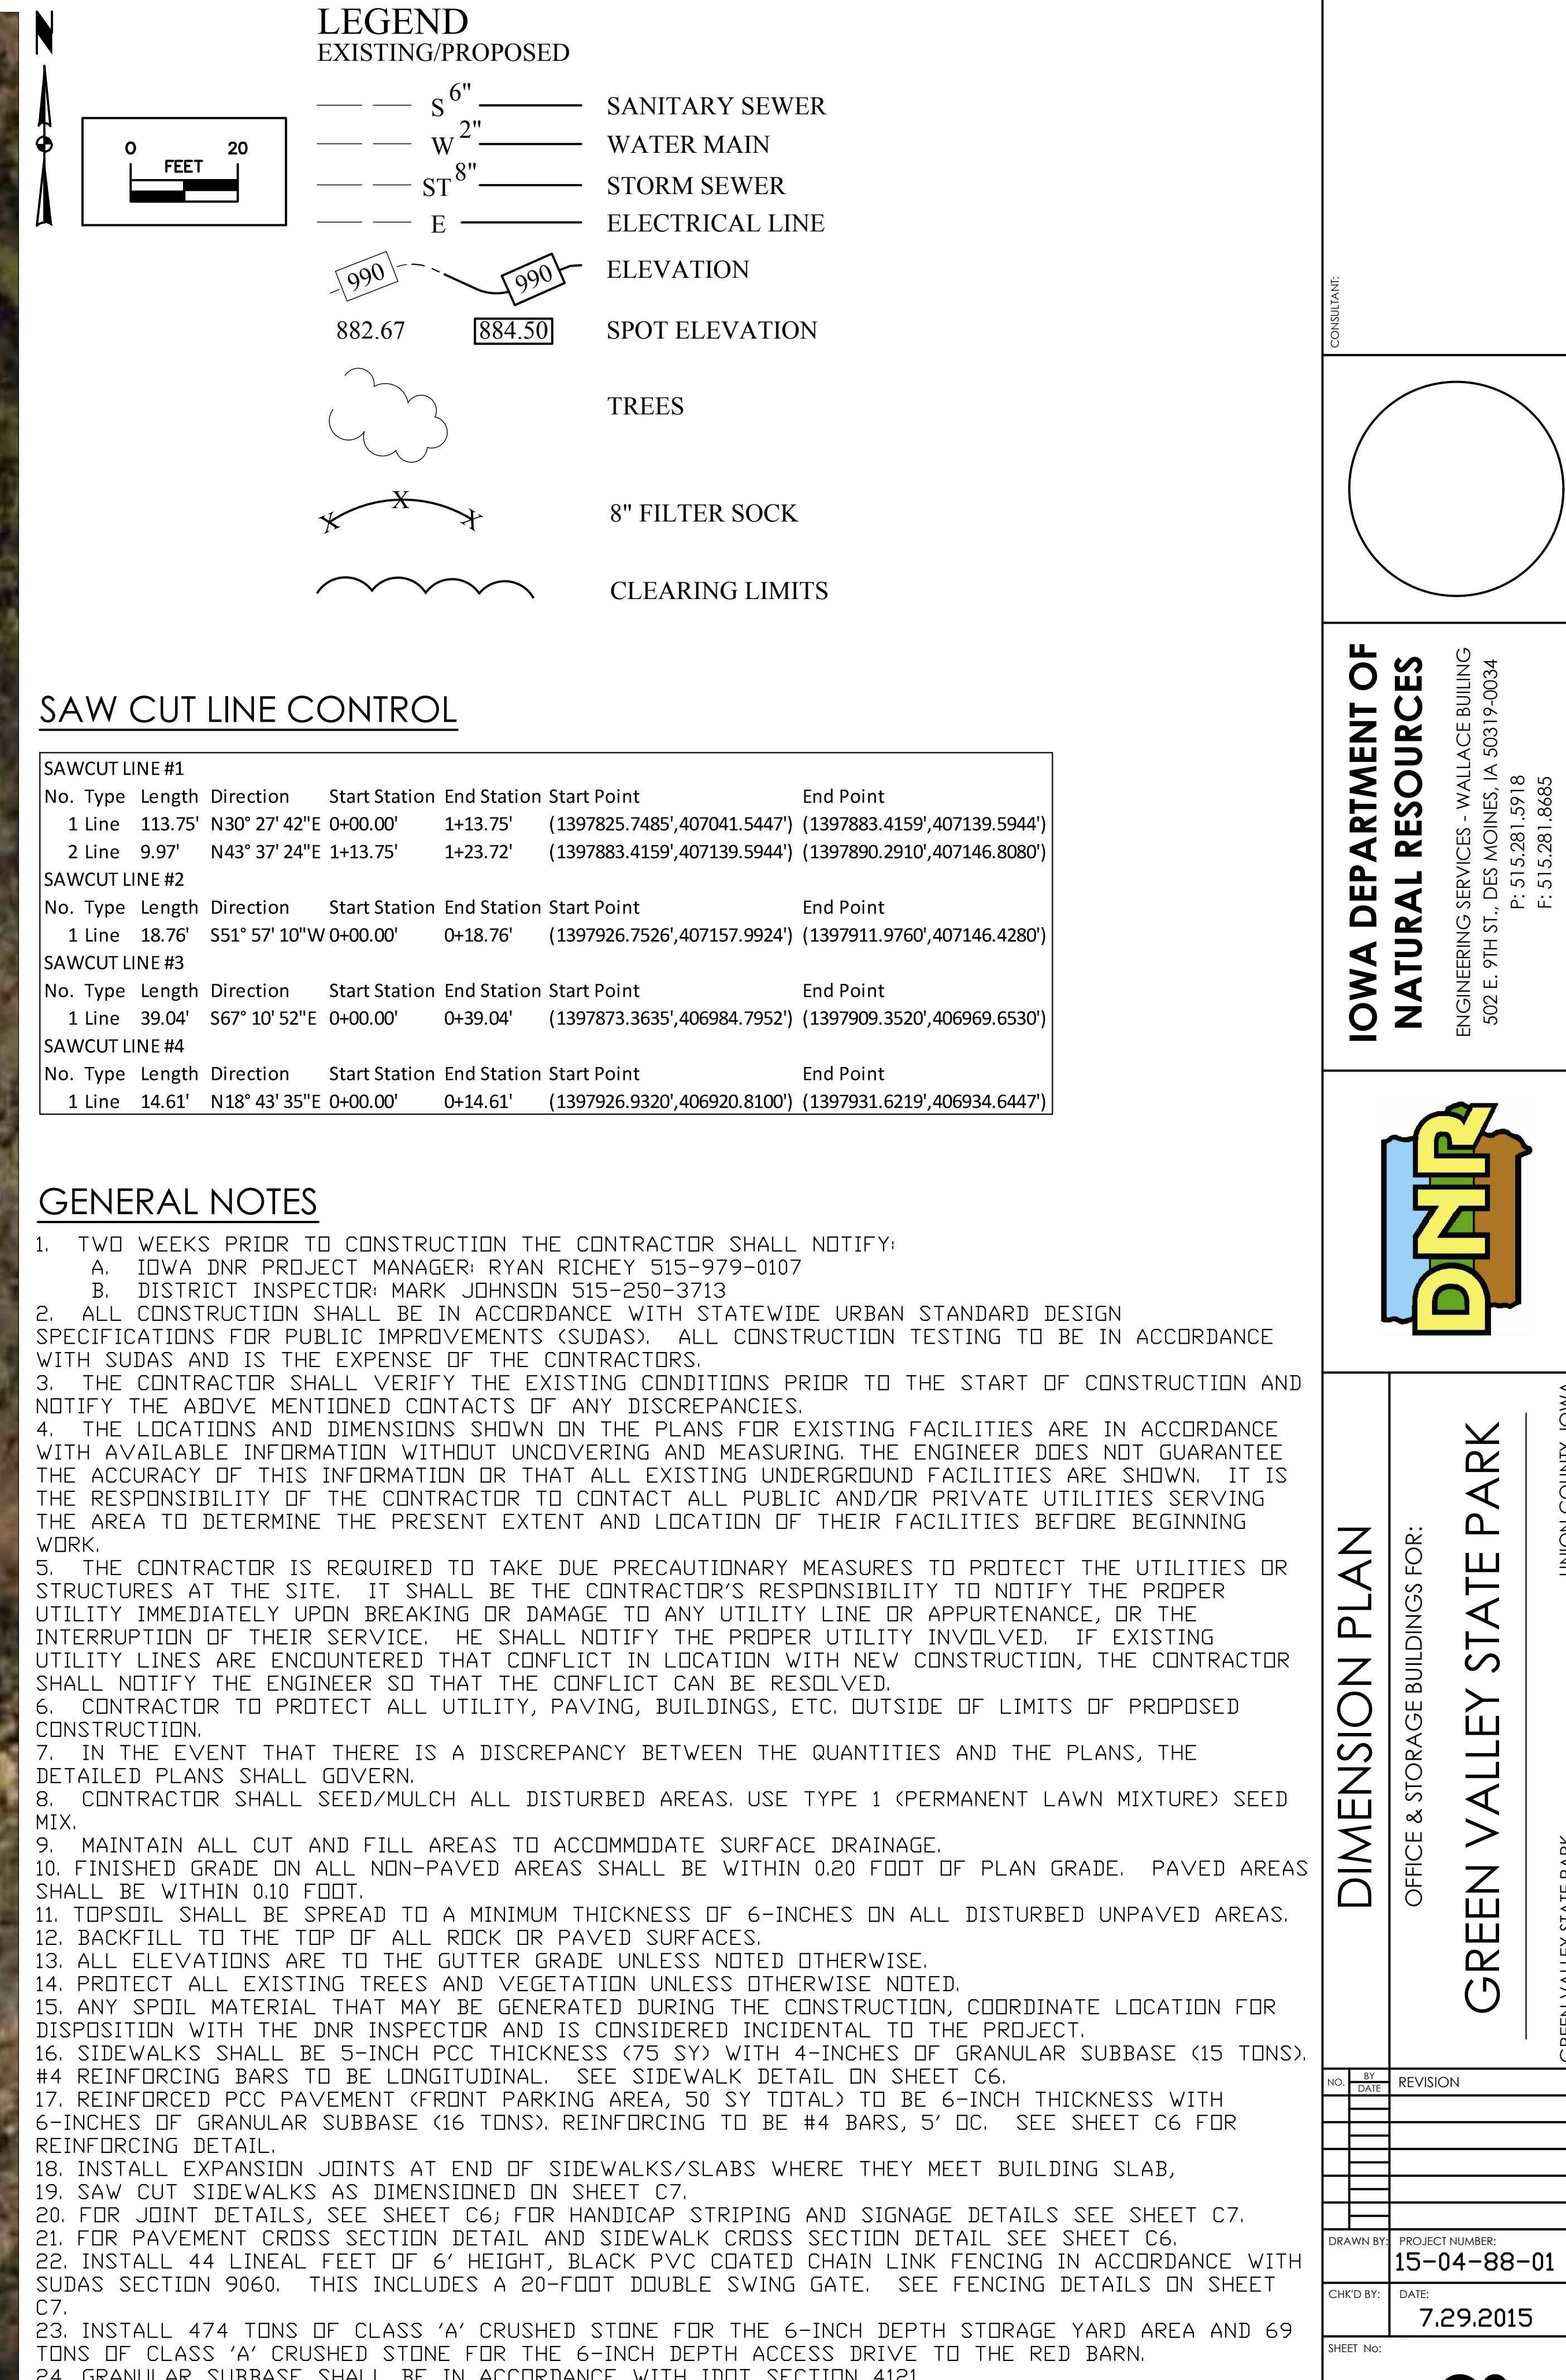

GREEN VALLEY STATE PARK

NO.	BY DATE	REVISION
DRAWN BY:	PROJECT NUMBER: <b>15-04-88-01</b>	
CHK'D BY:	DATE: <b>7.29.2015</b>	
SHEET No:		

## C3

















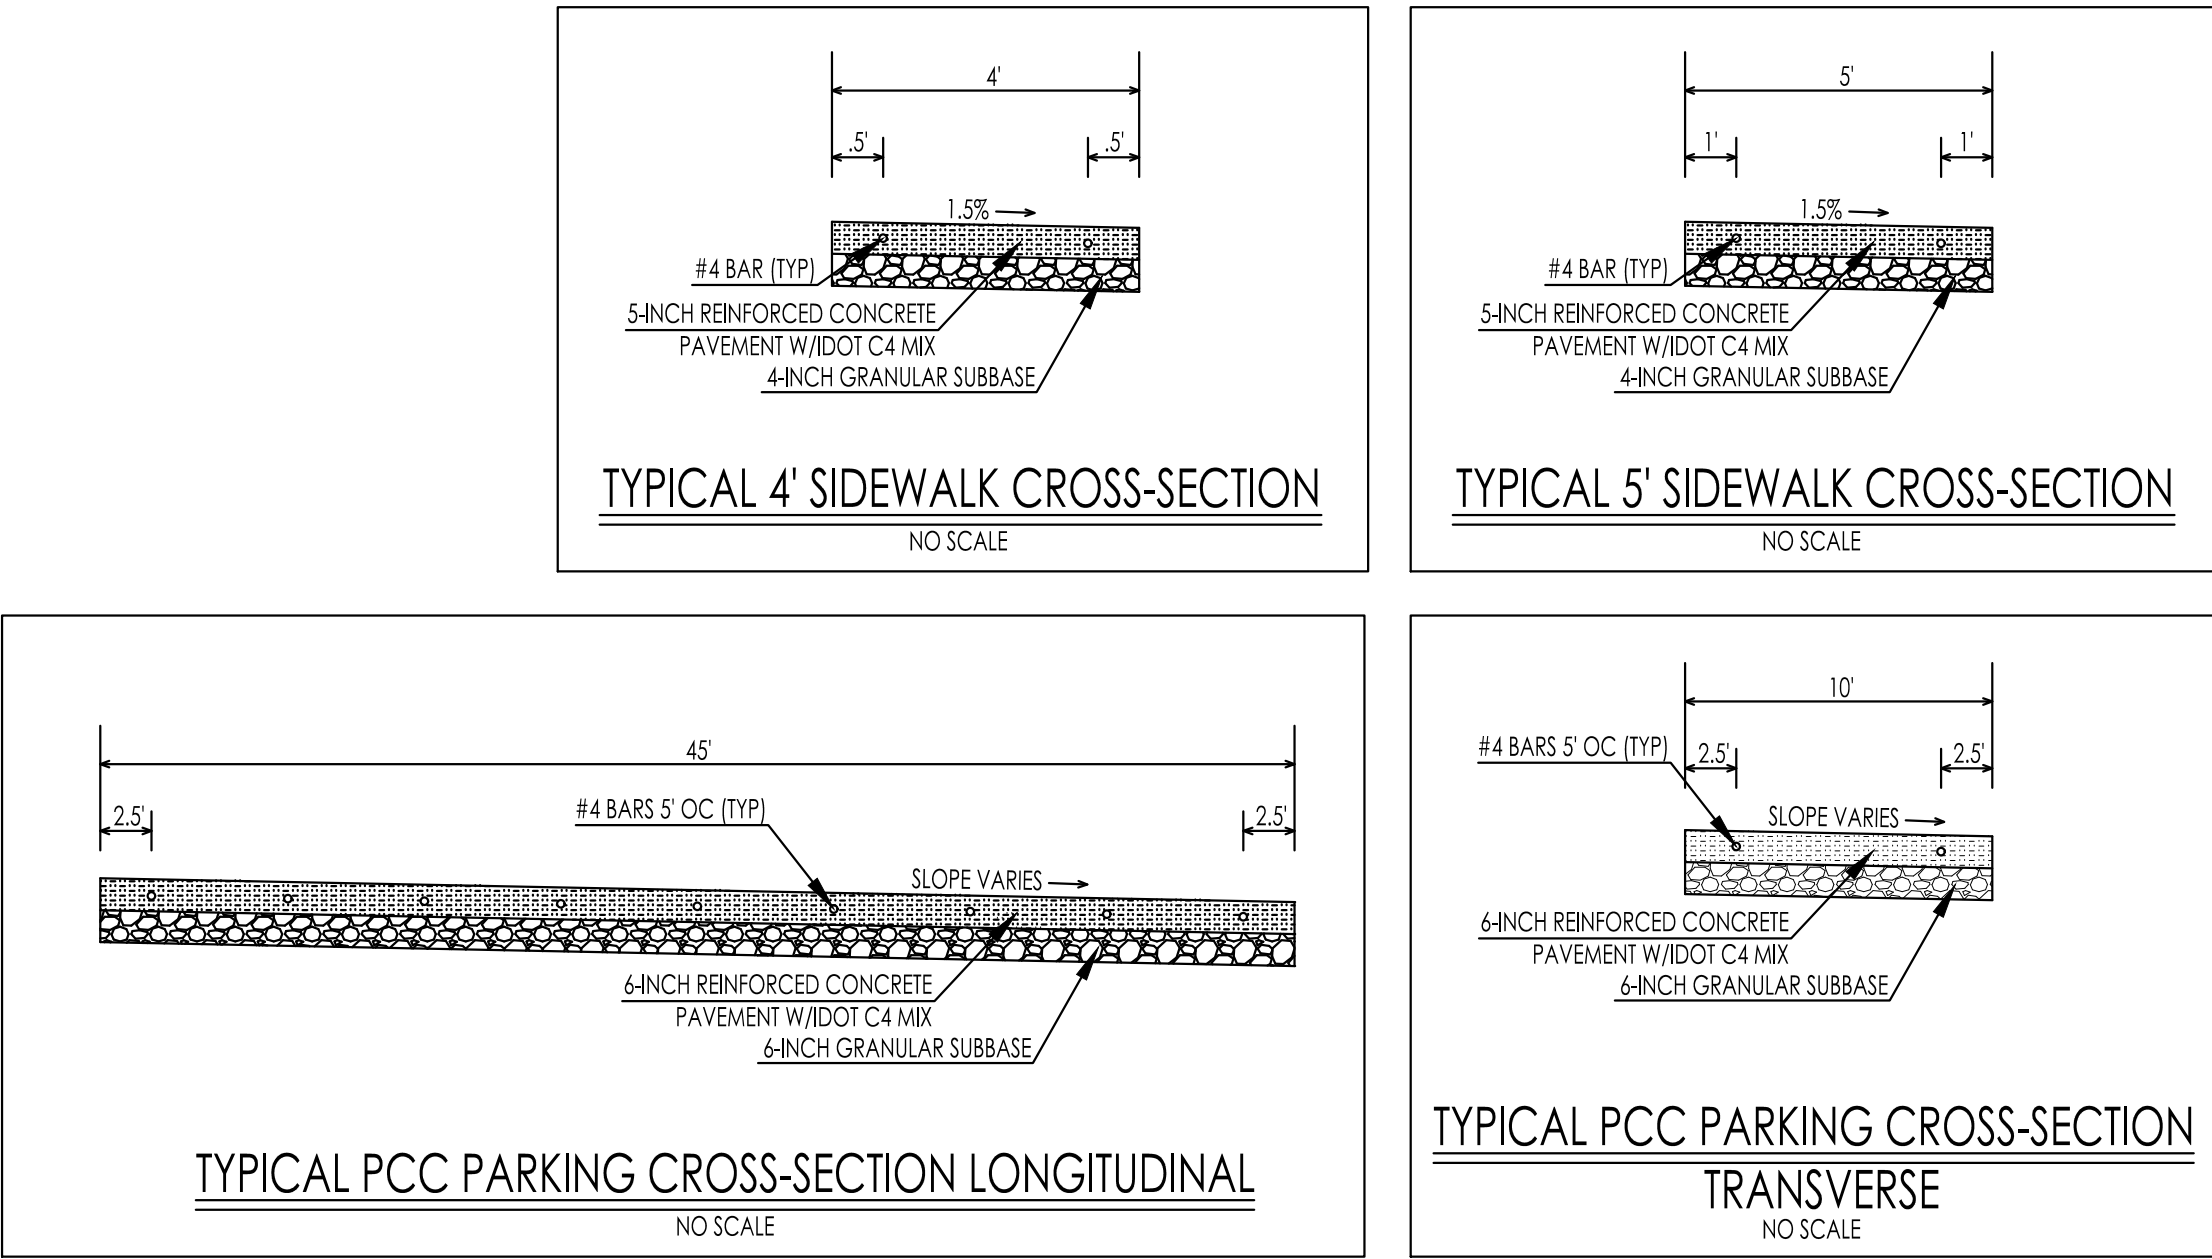


## CONCRETE REINFORCING PLAN

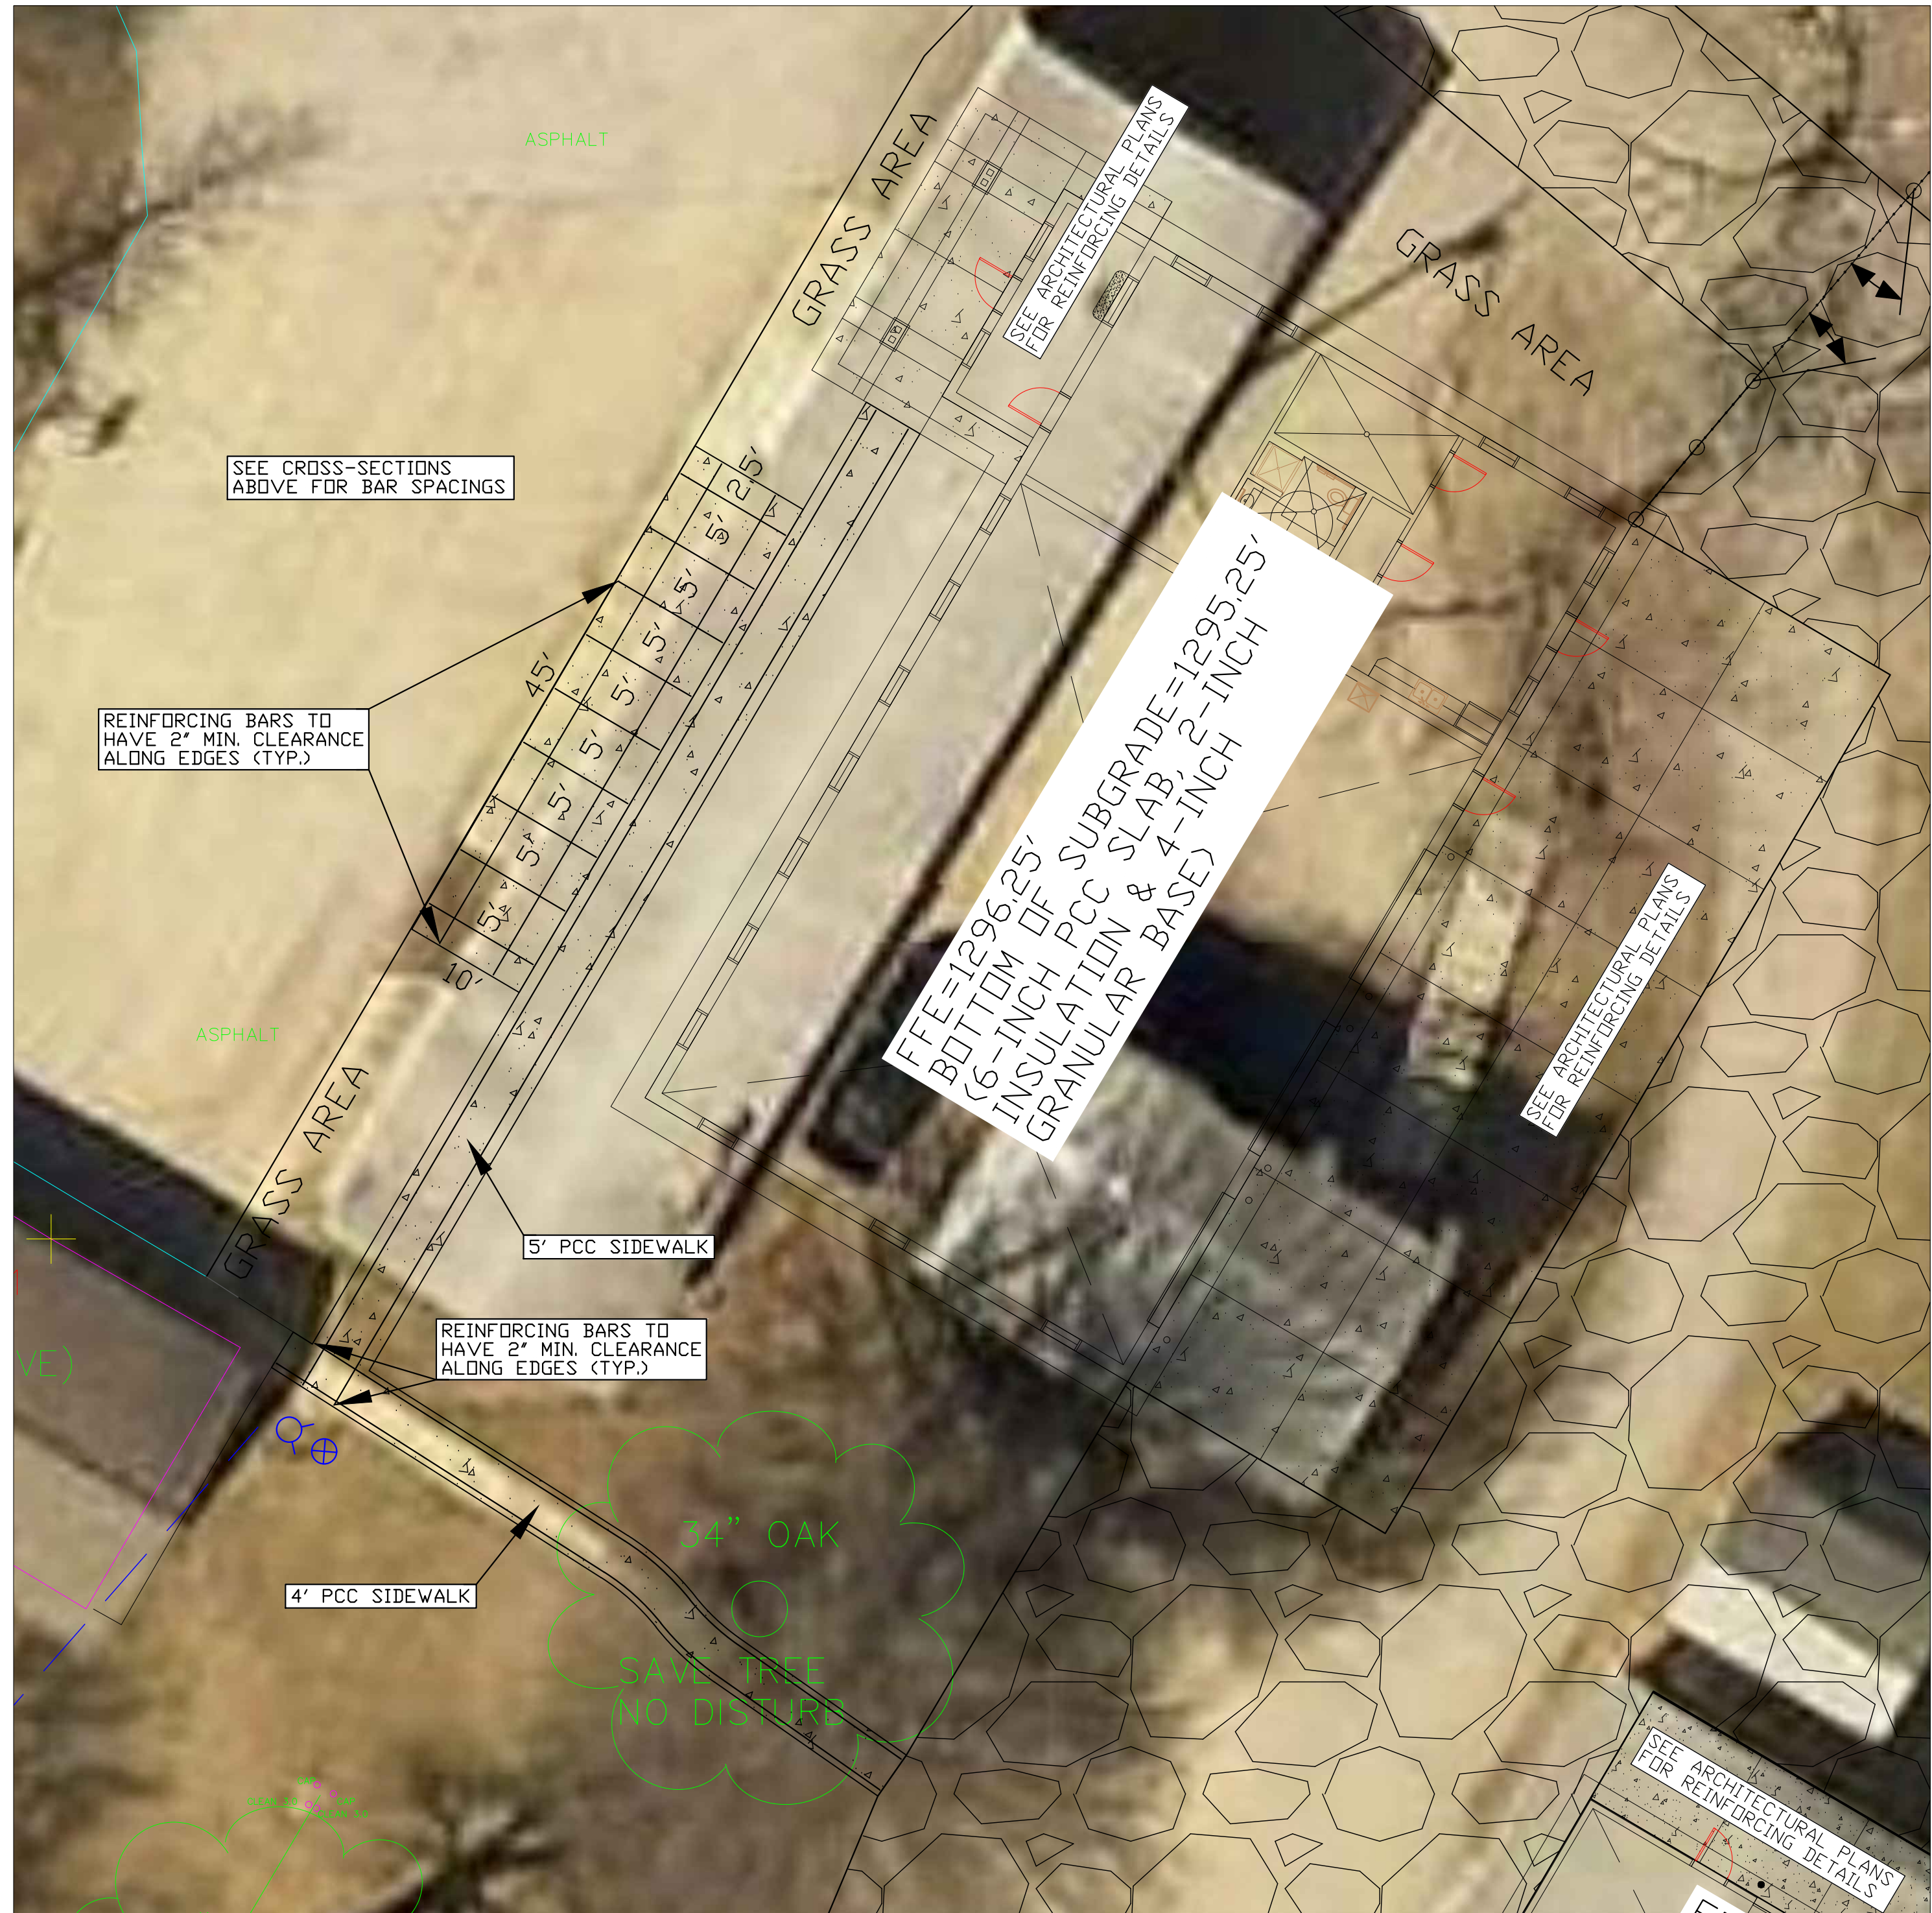








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<b>CHECKD BY:</b>		<b>DATE:</b> <b>7.29.2015</b>
<b>SHEET NO:</b>		



## FLAT PARKING BUMPER

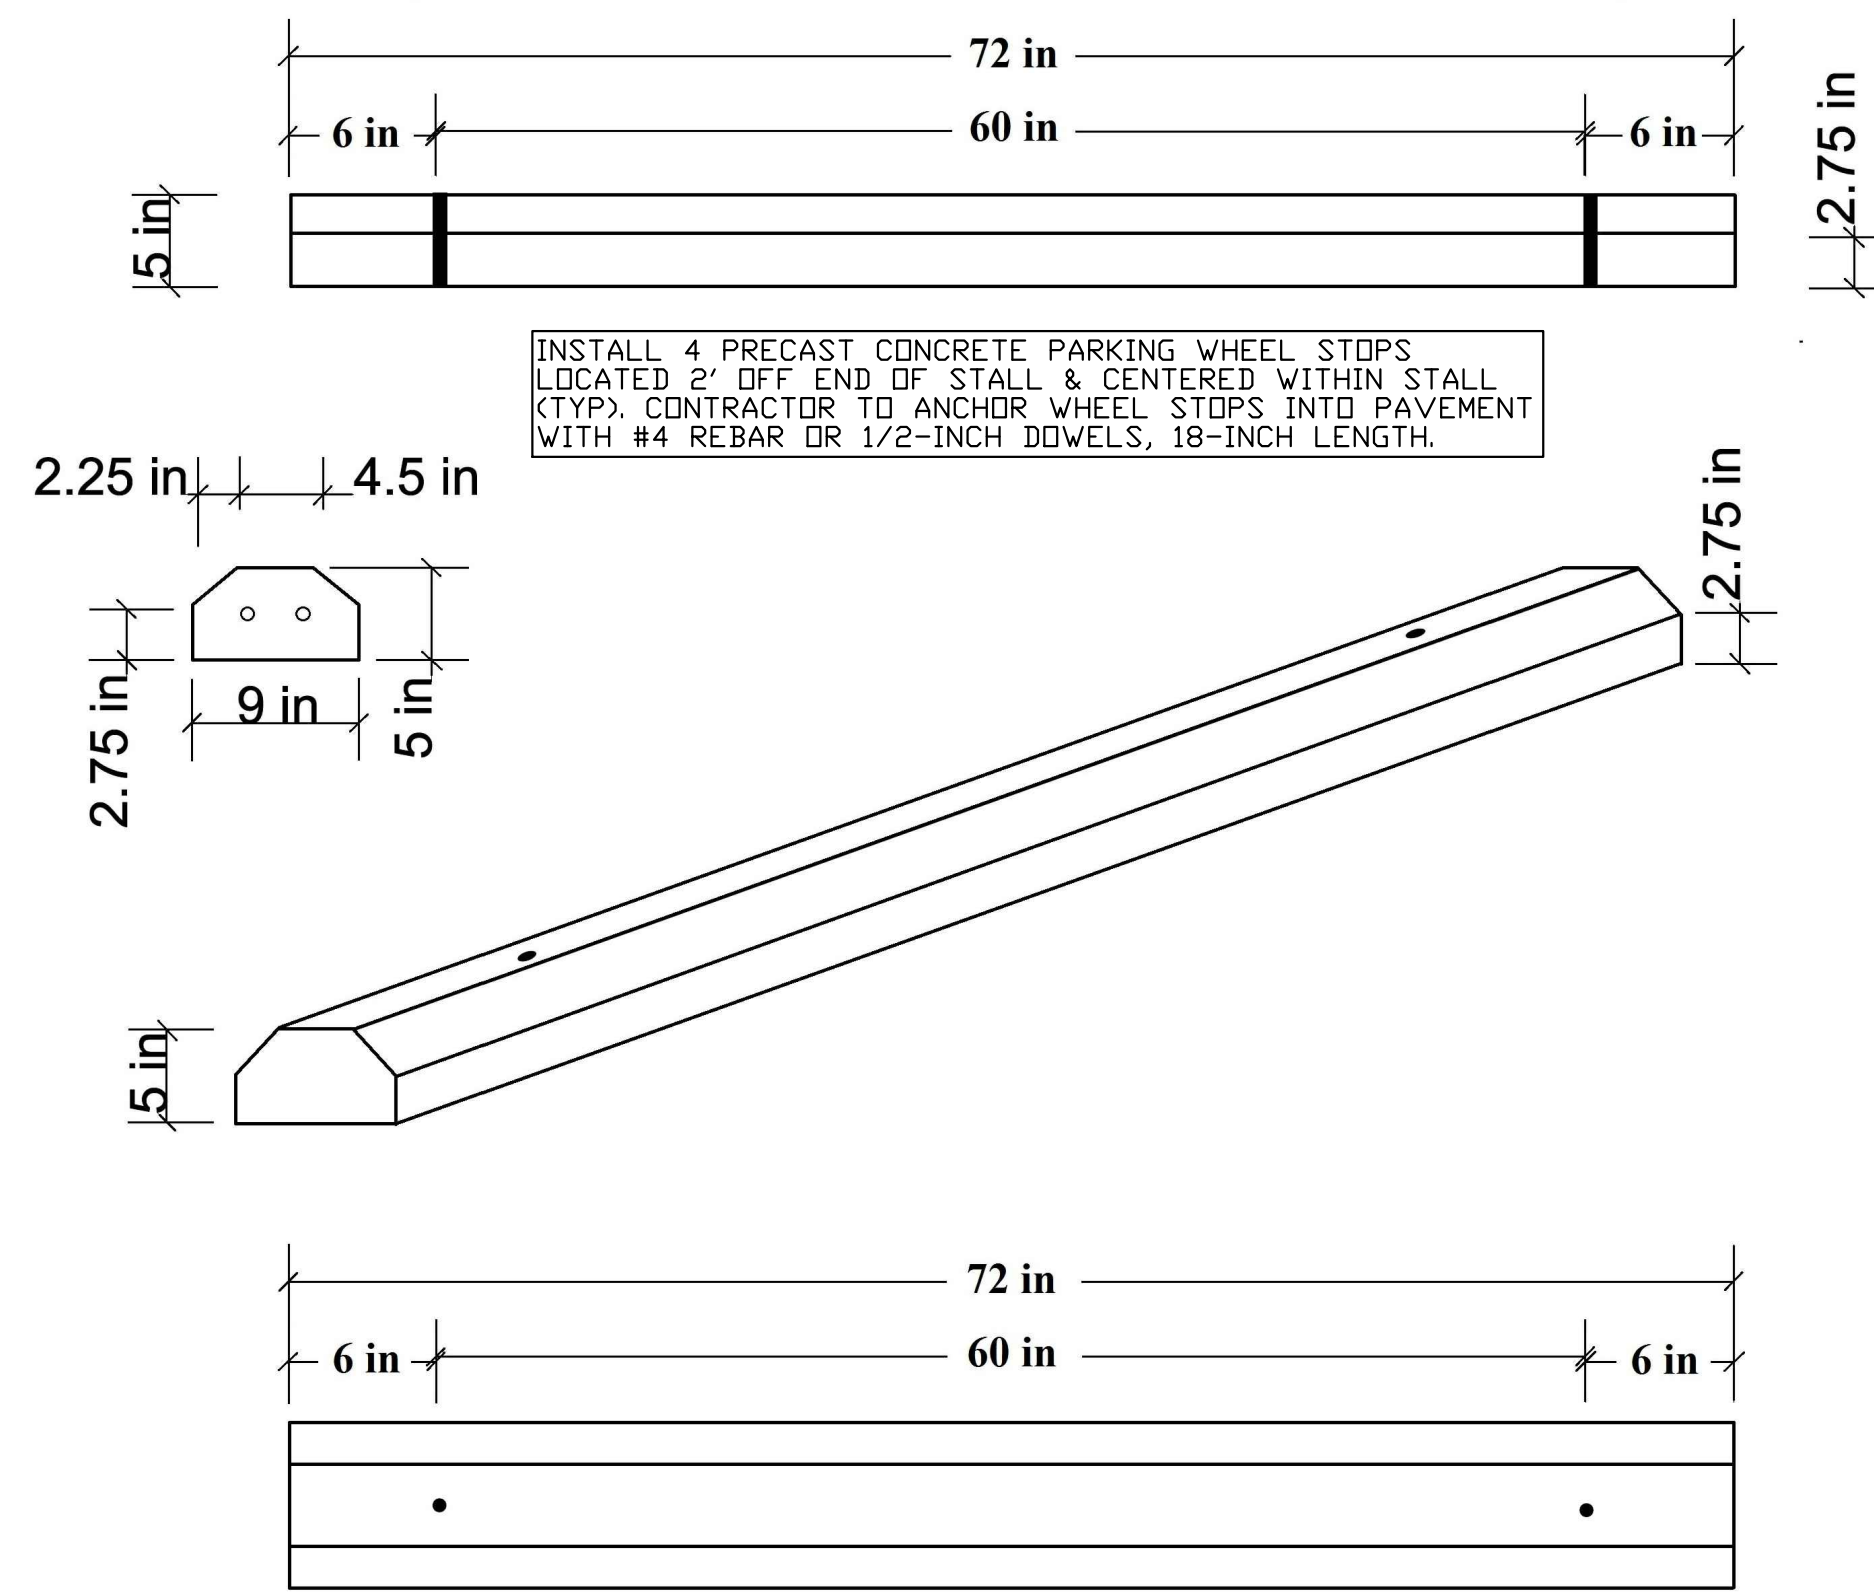


Air Entrained Concrete  
4000 p.s.i. @ 28 days  
Length: 6'0"  
Height: 5"  
Width: 9"

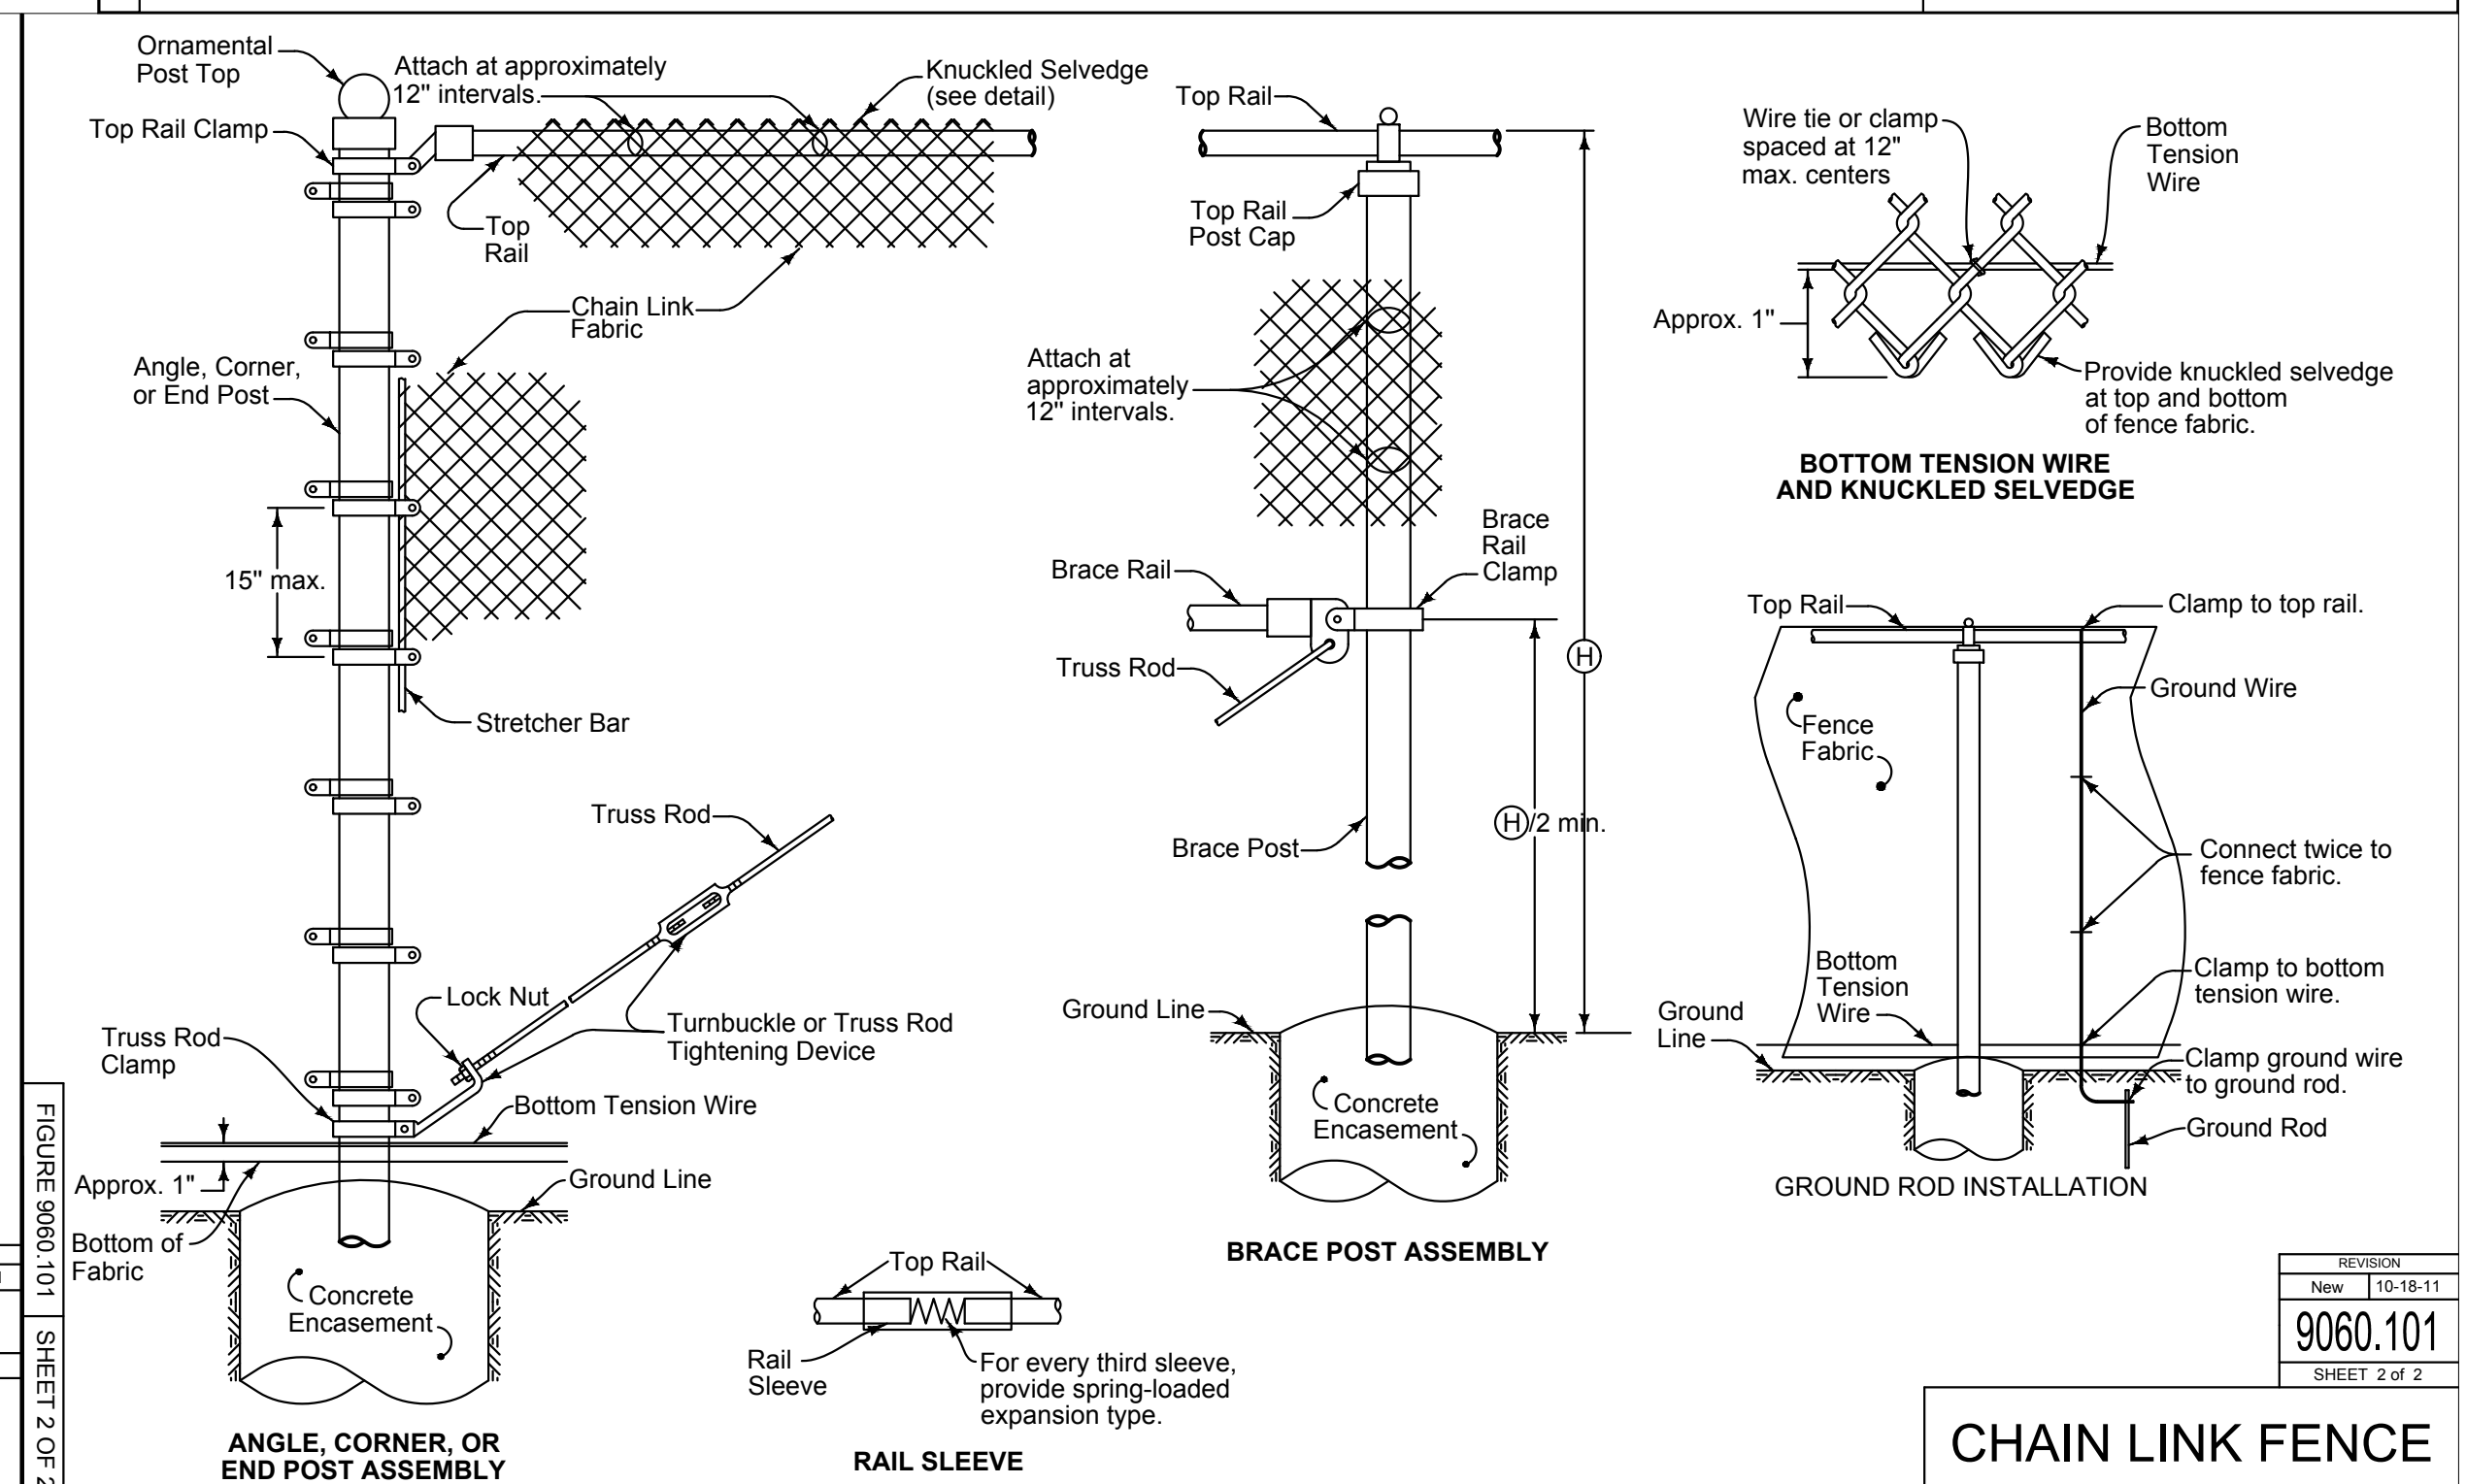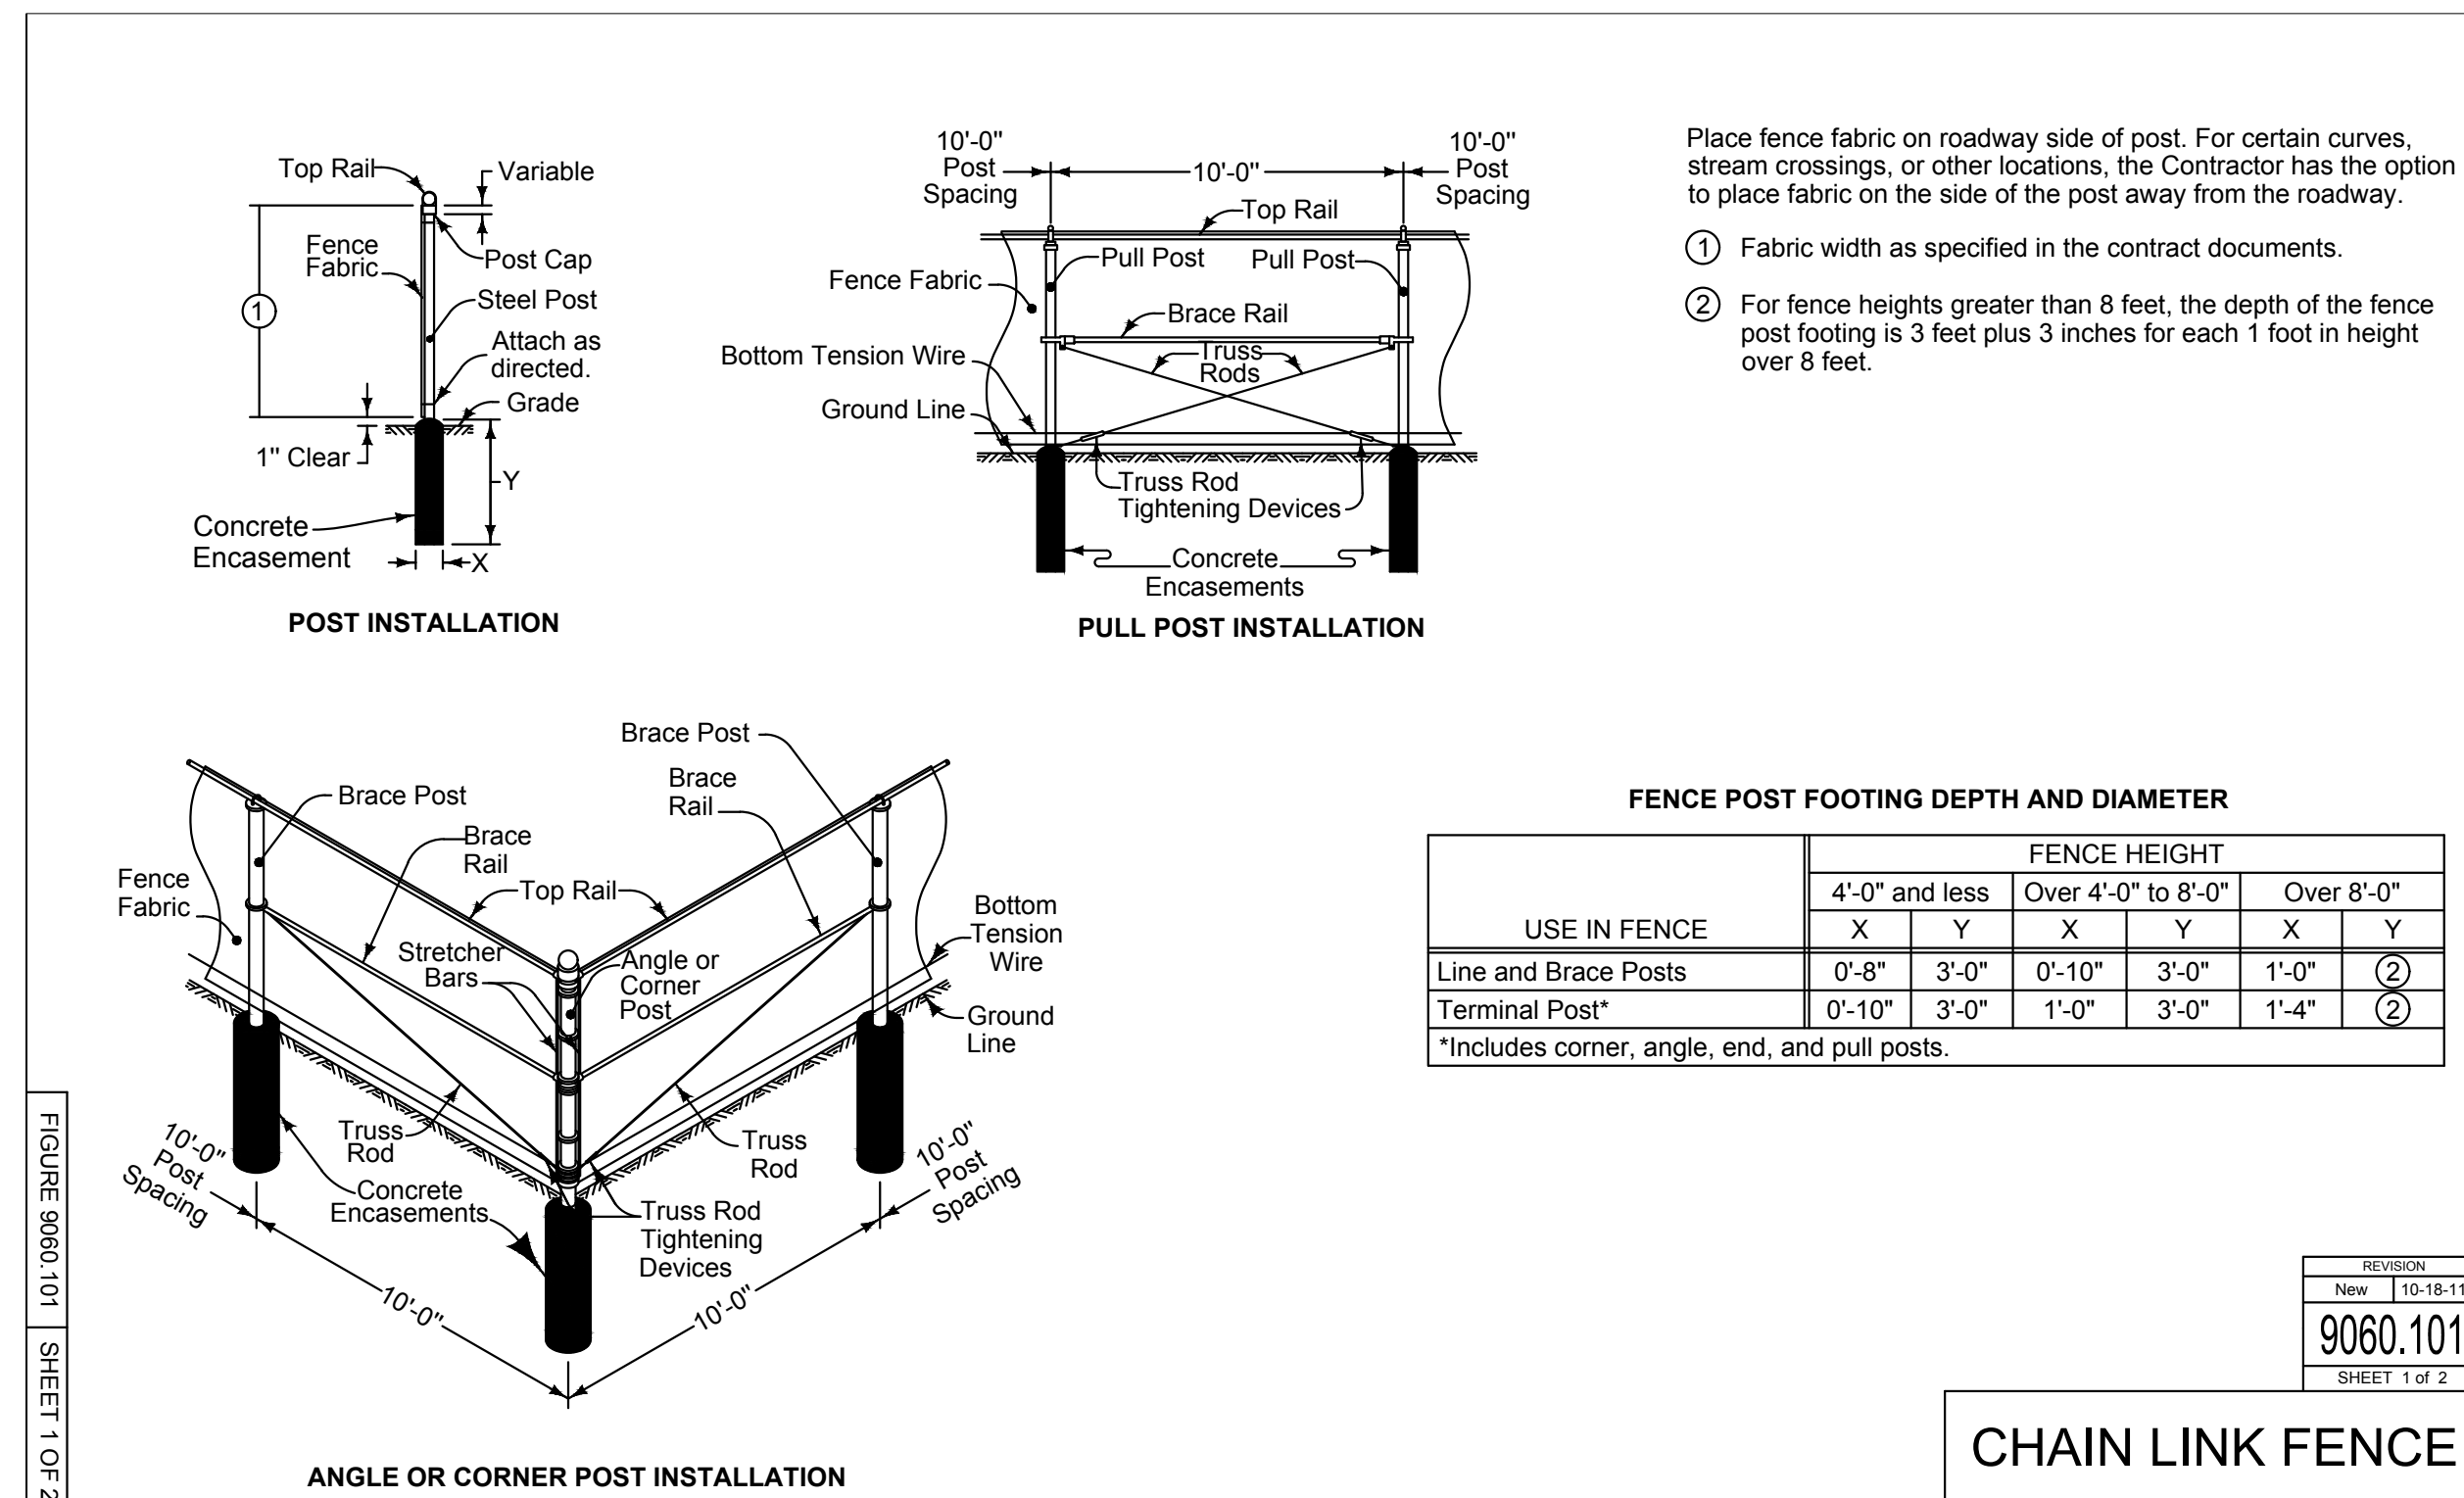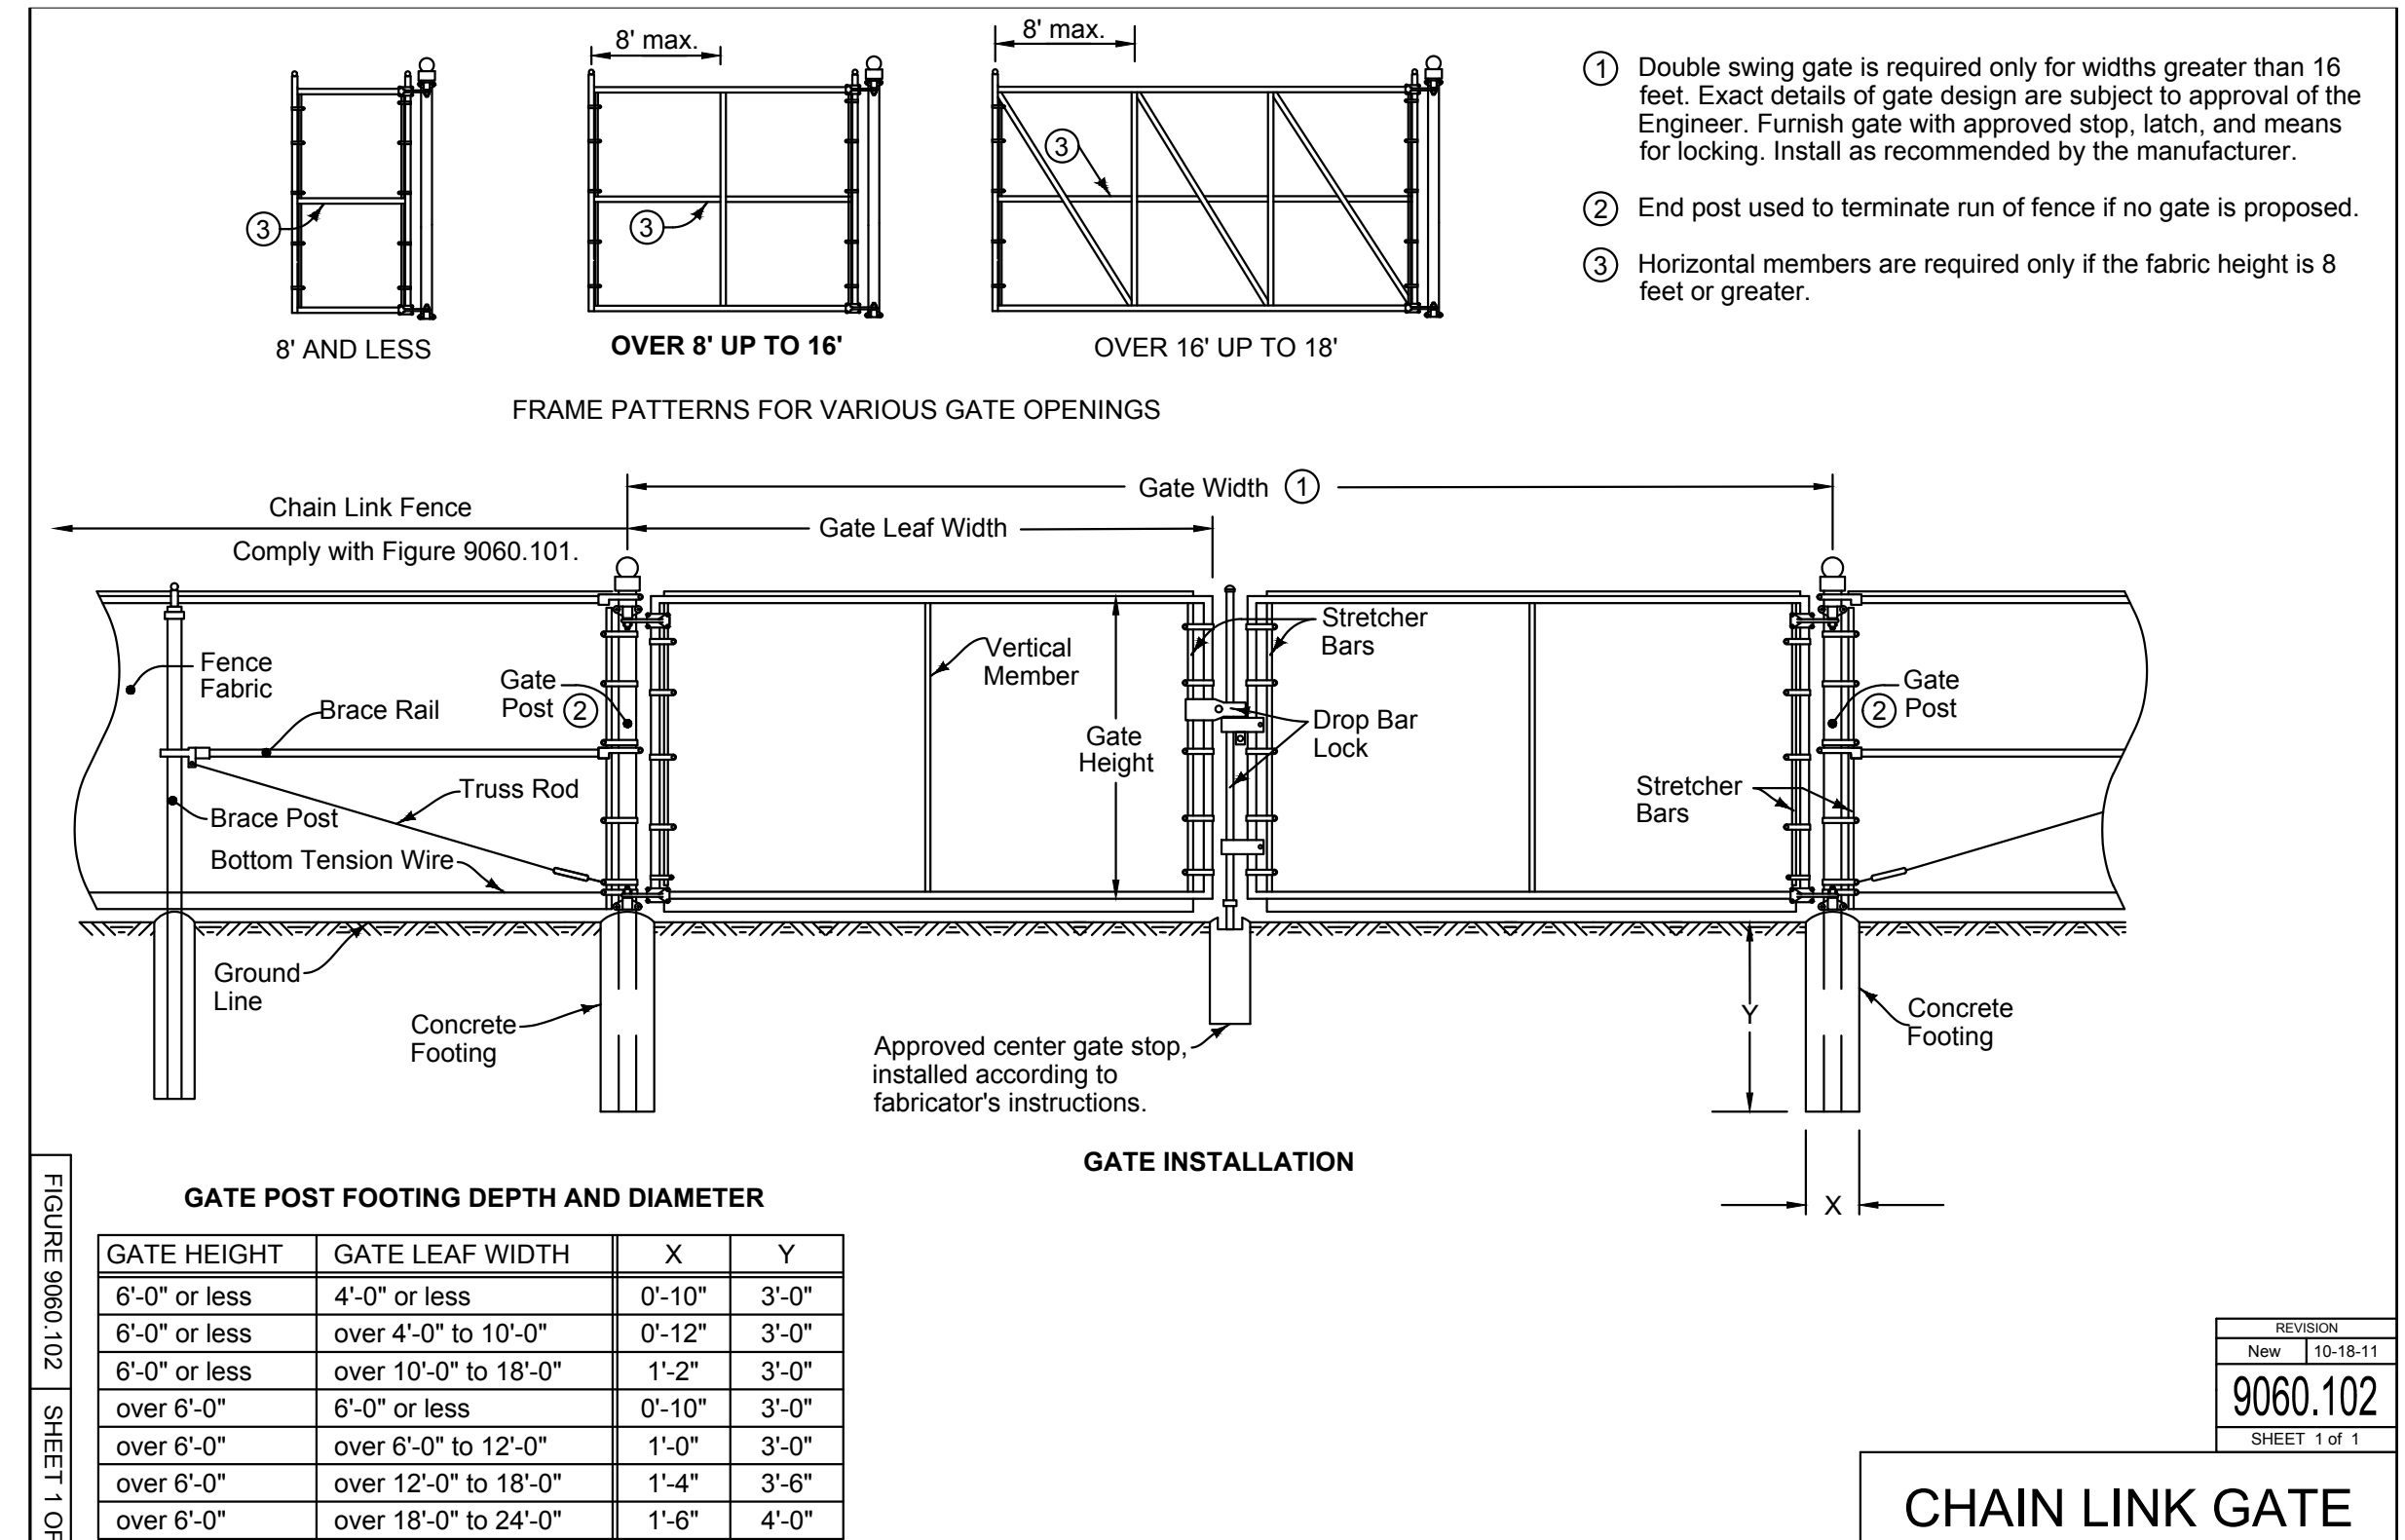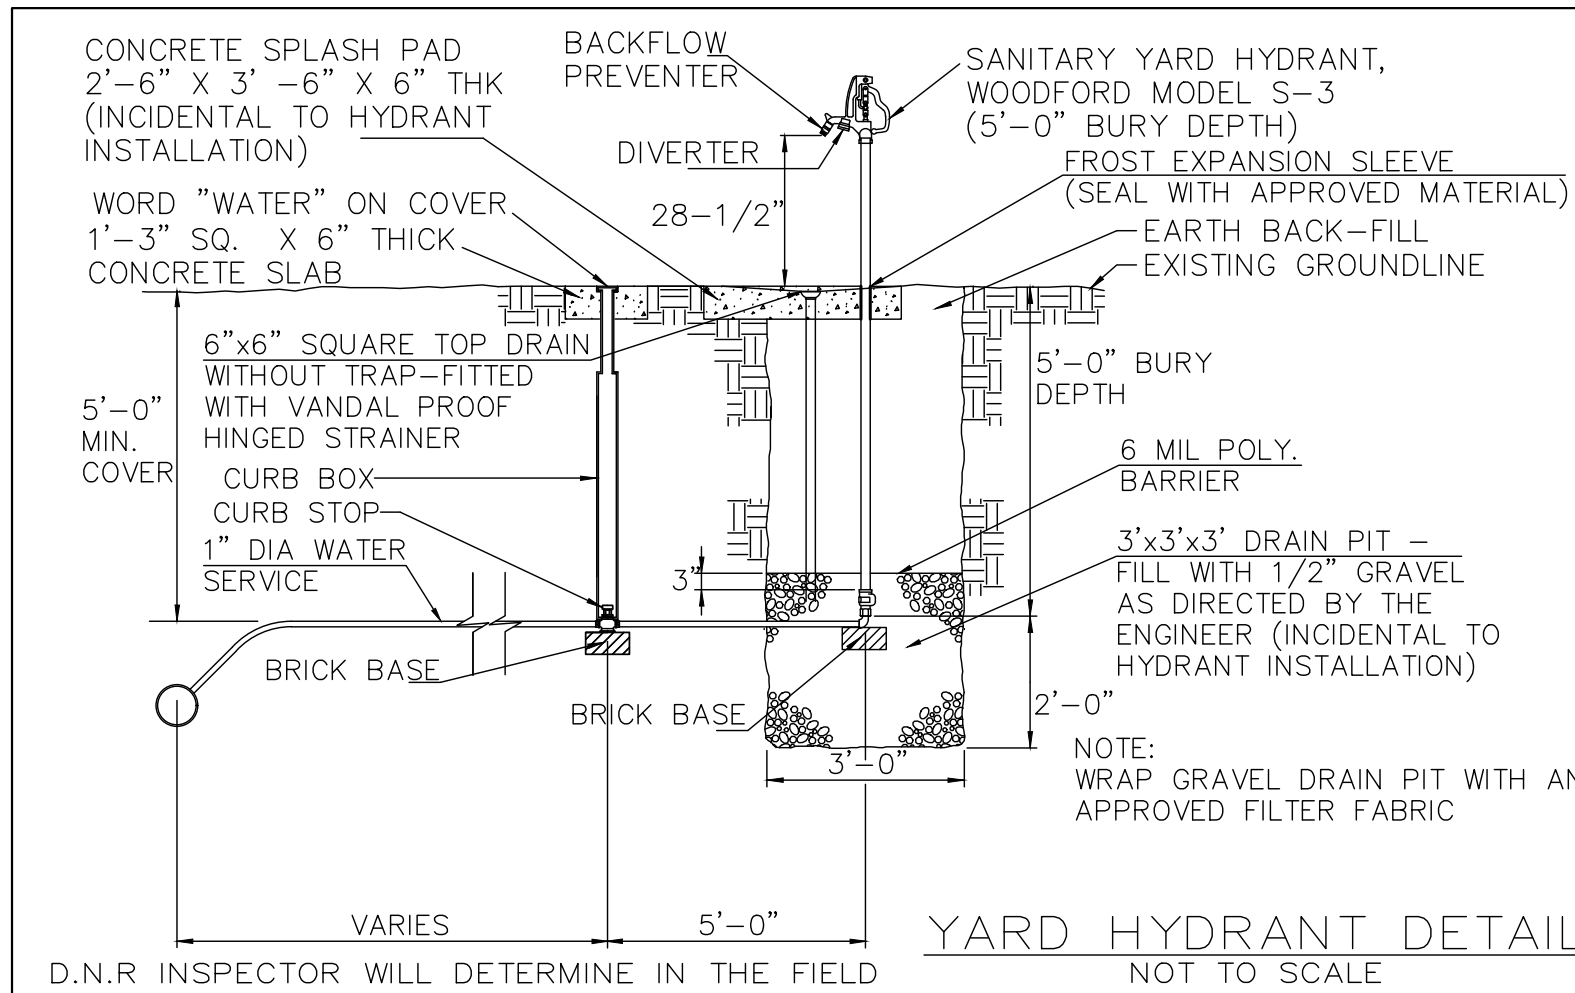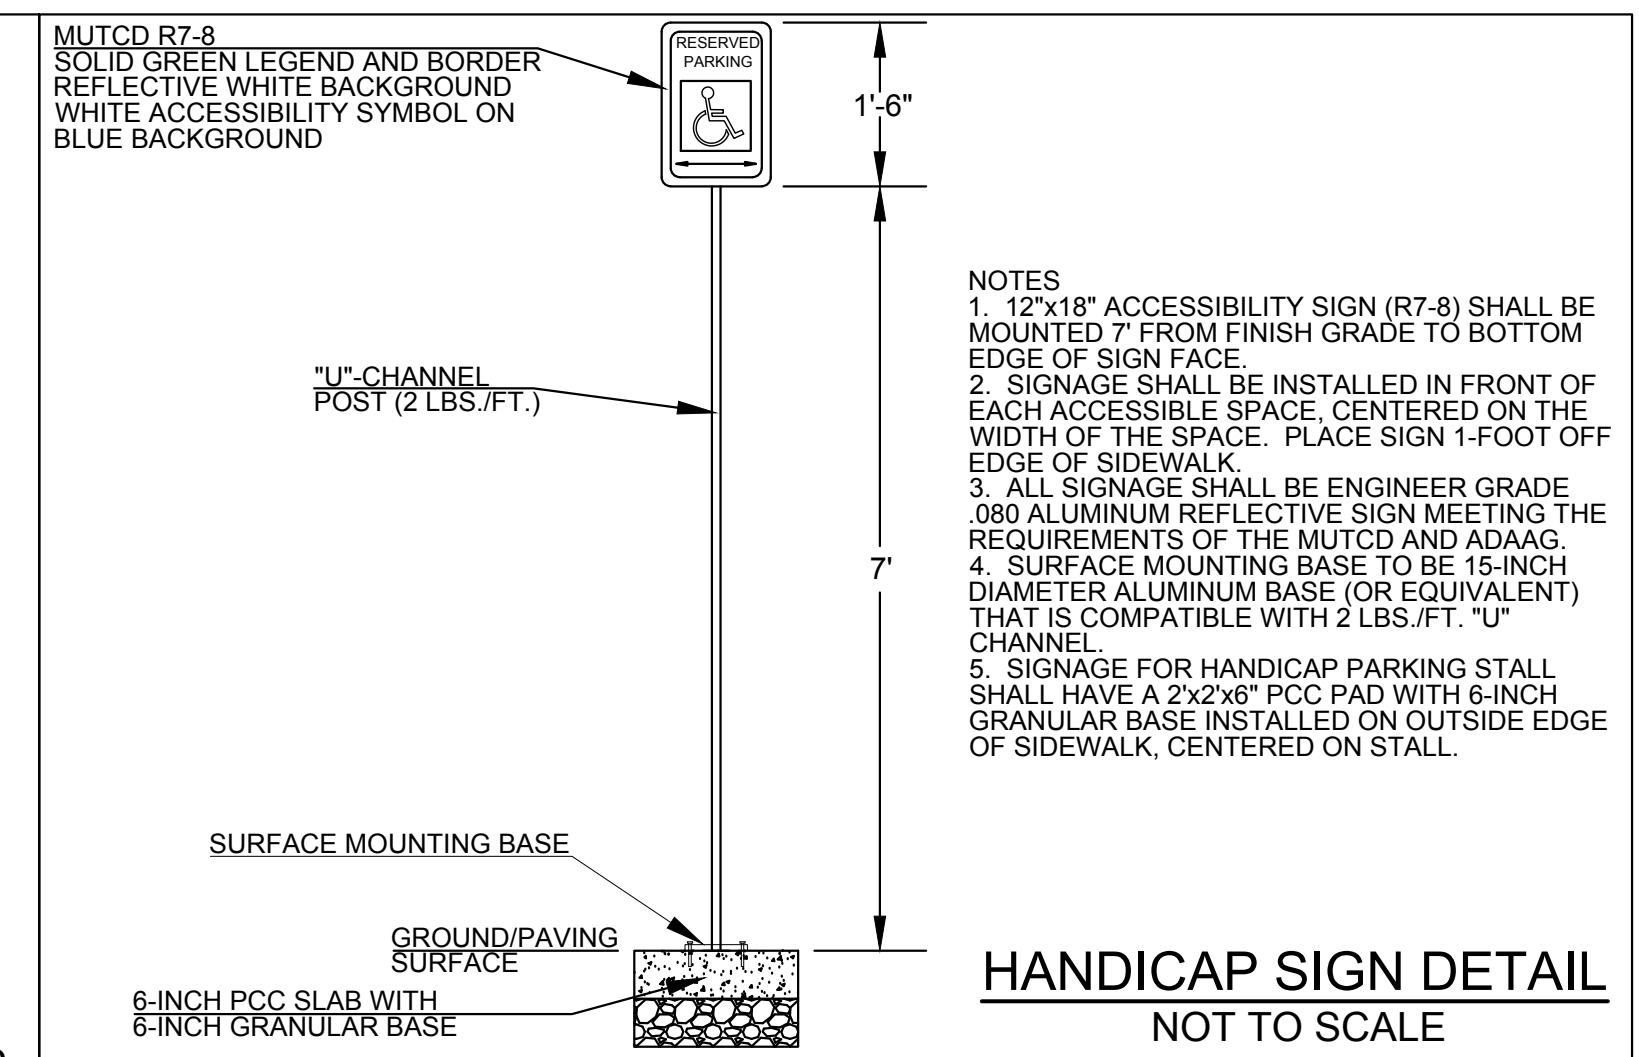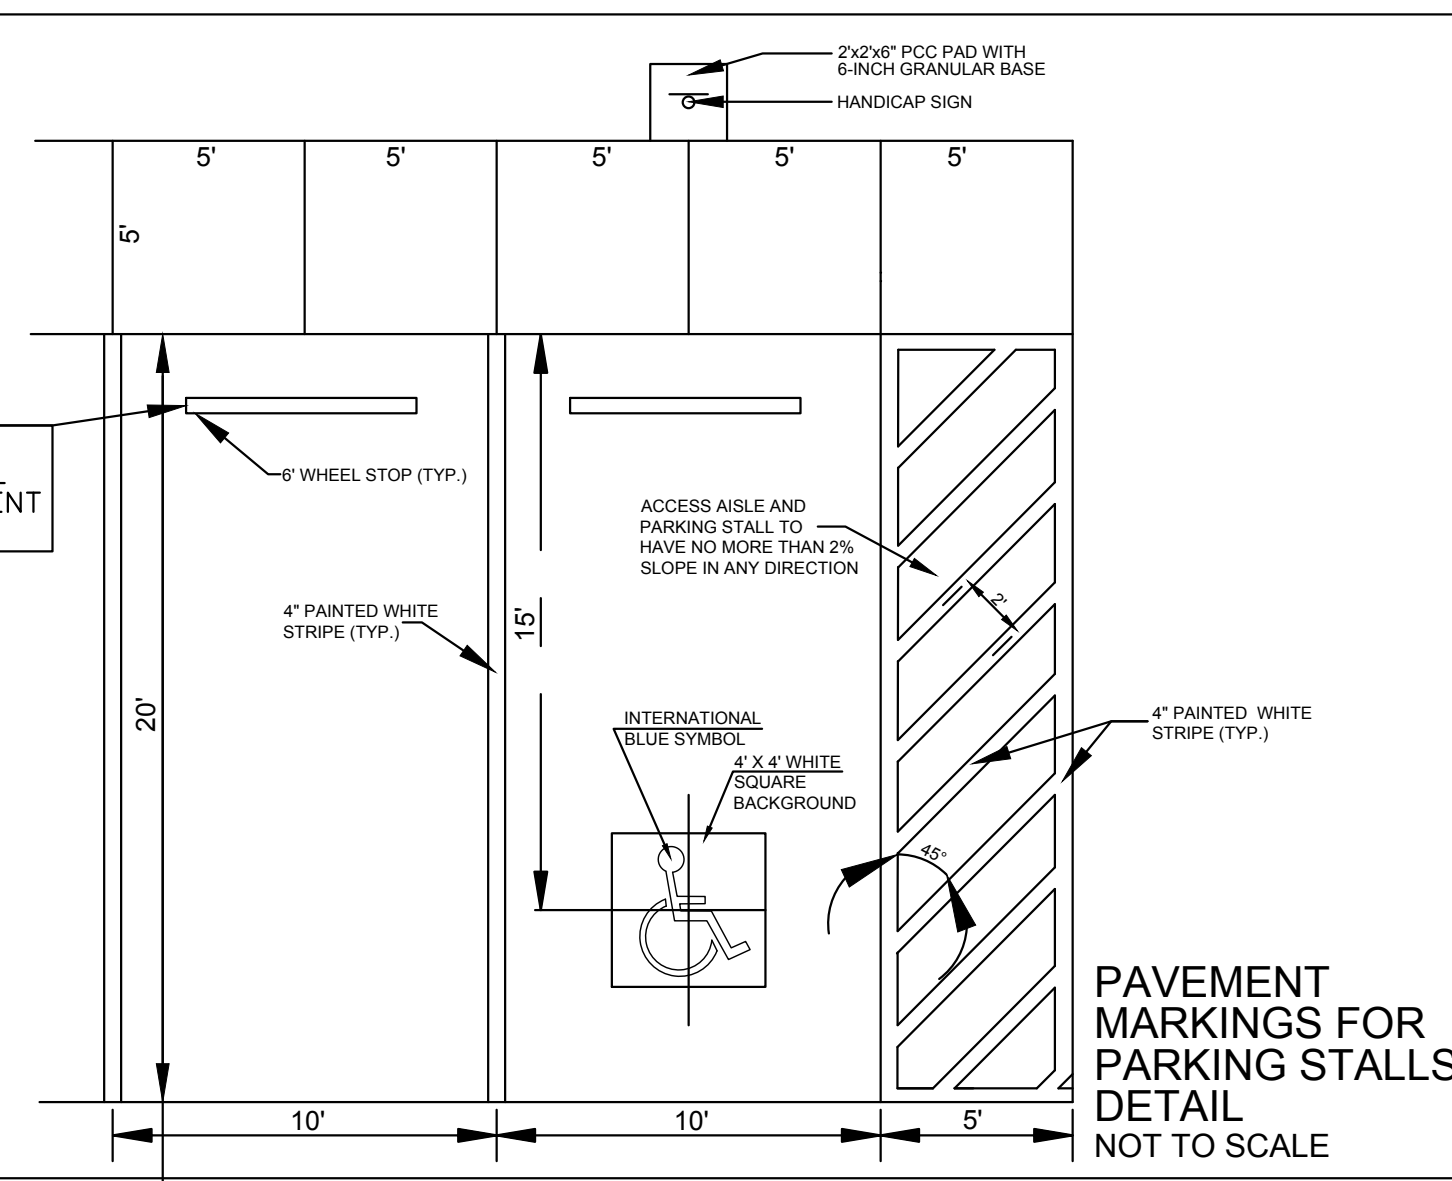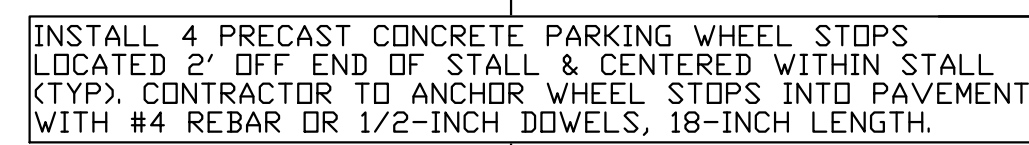





02 SITE PLAN  
SCALE: NTS

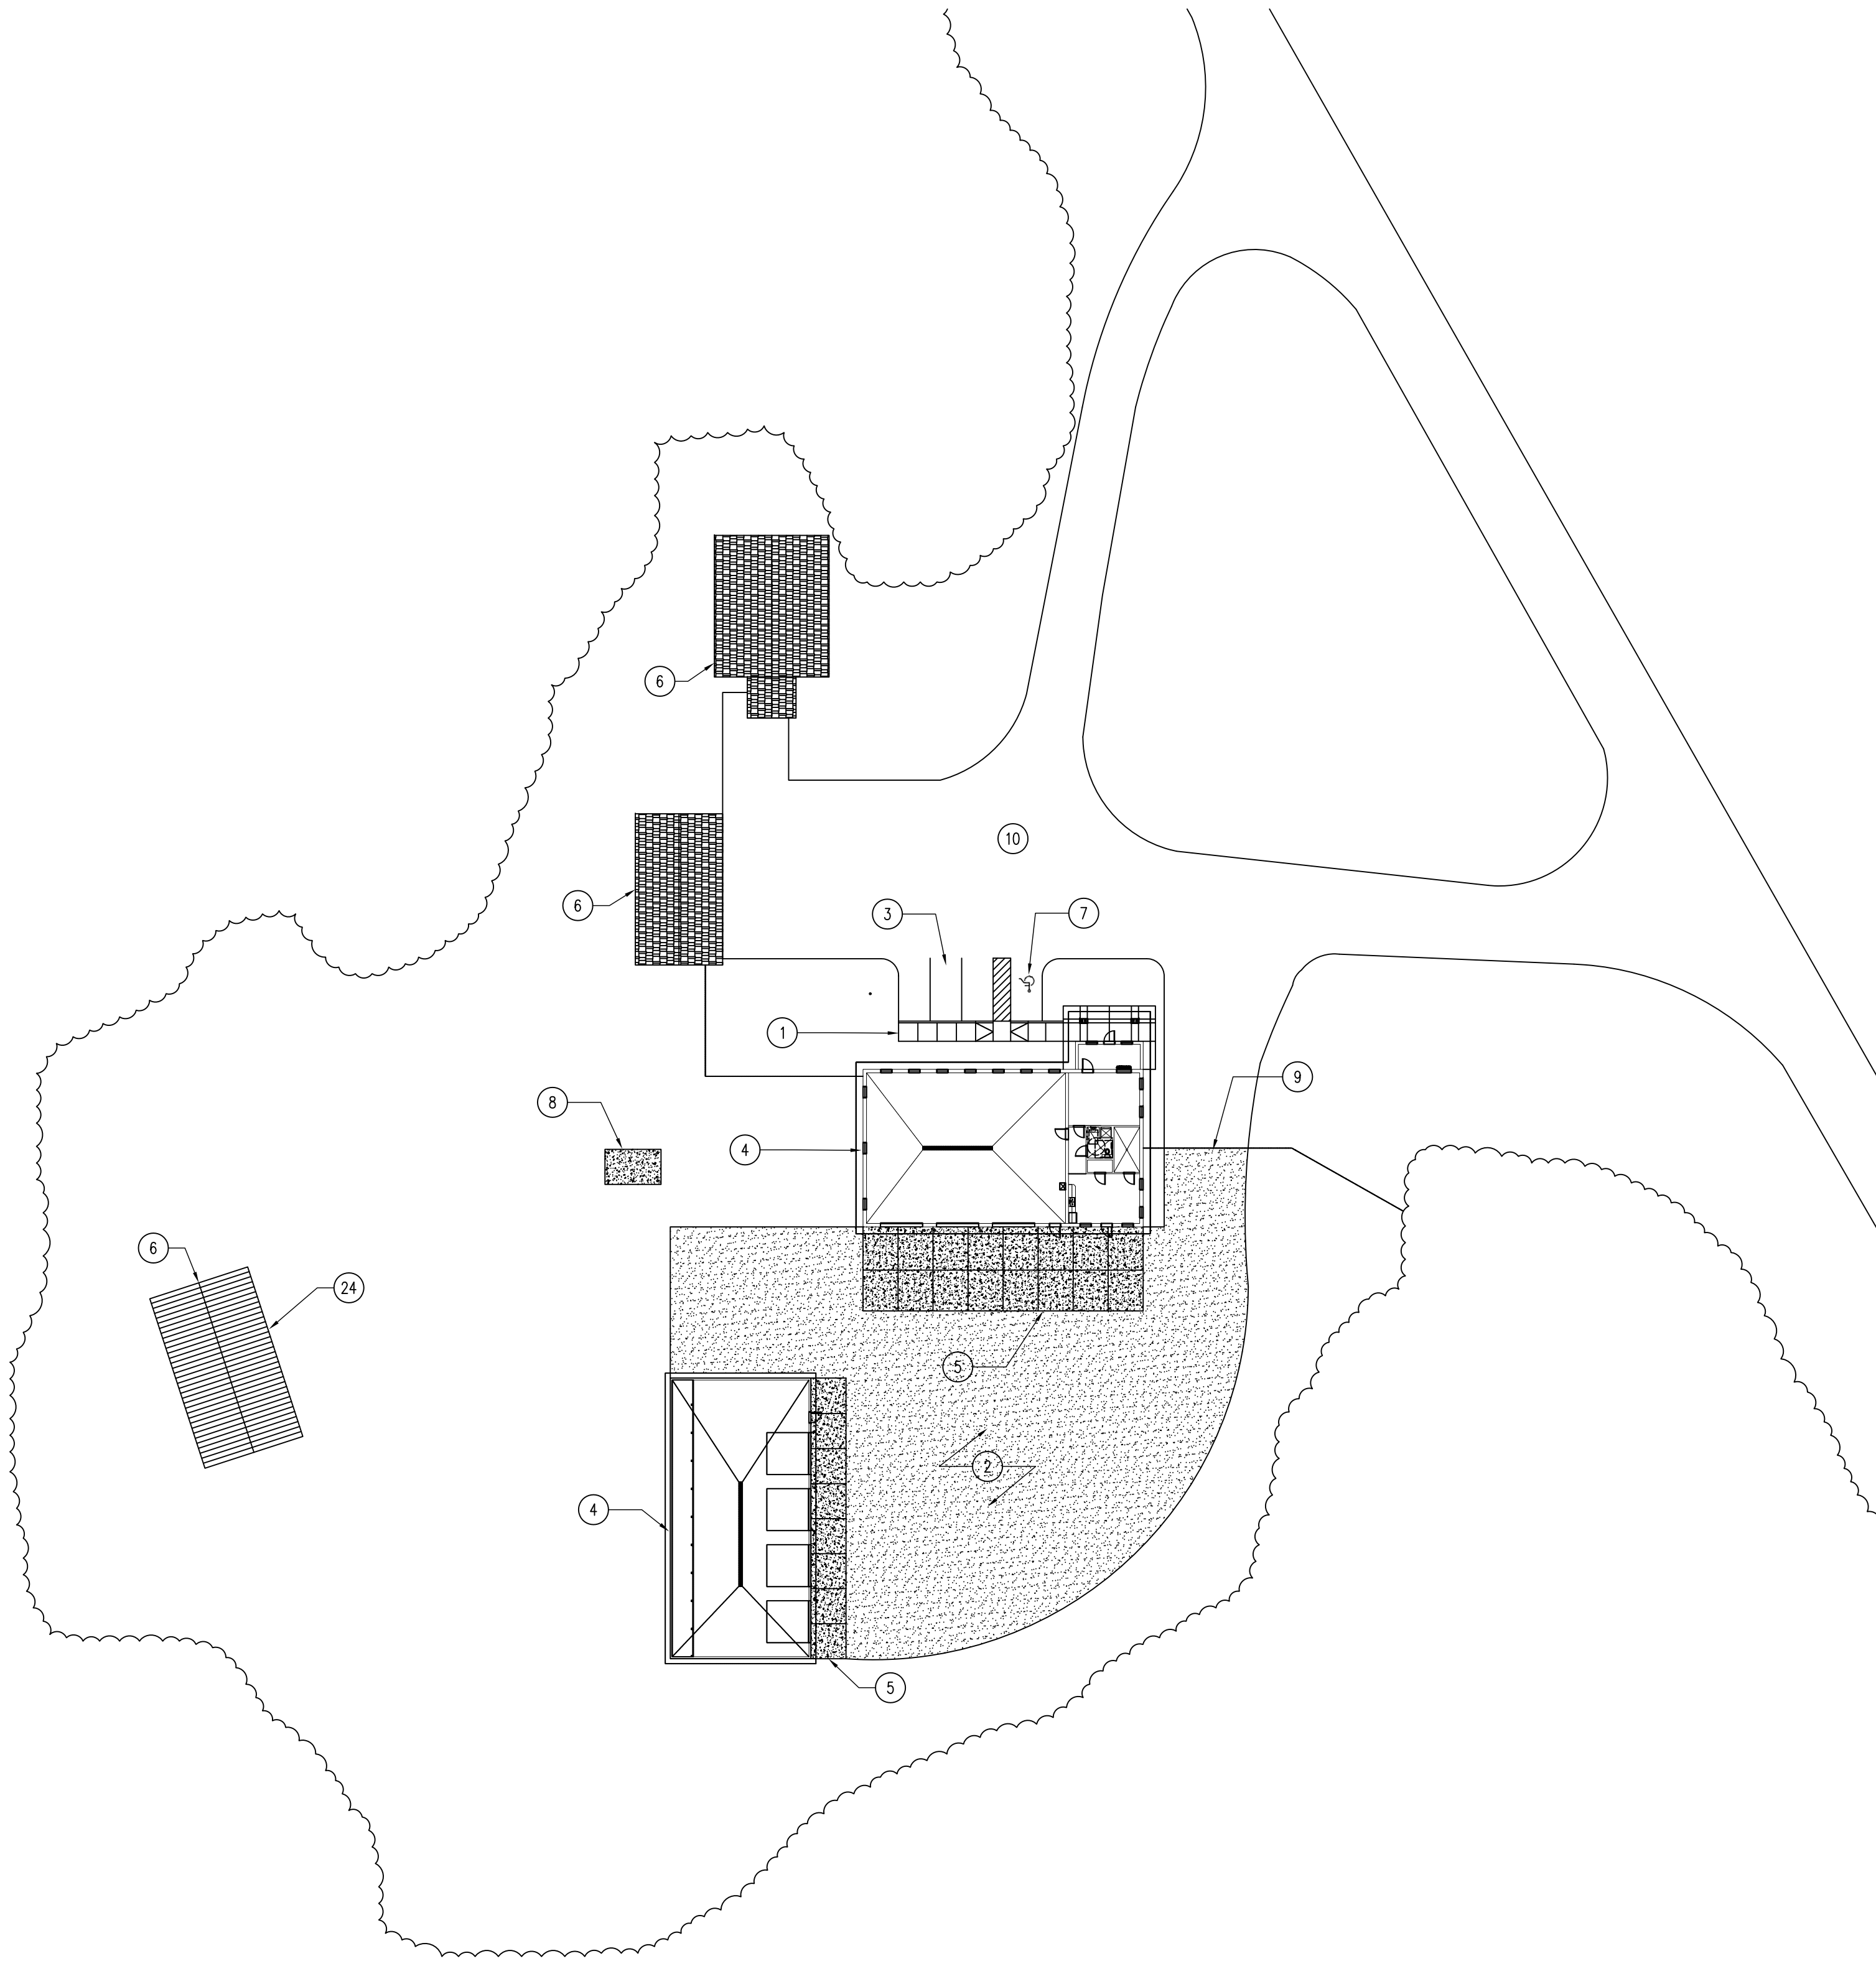


04 DETAIL - BUILDING FOUNDATION  
SCALE: 1" = 1'-0"

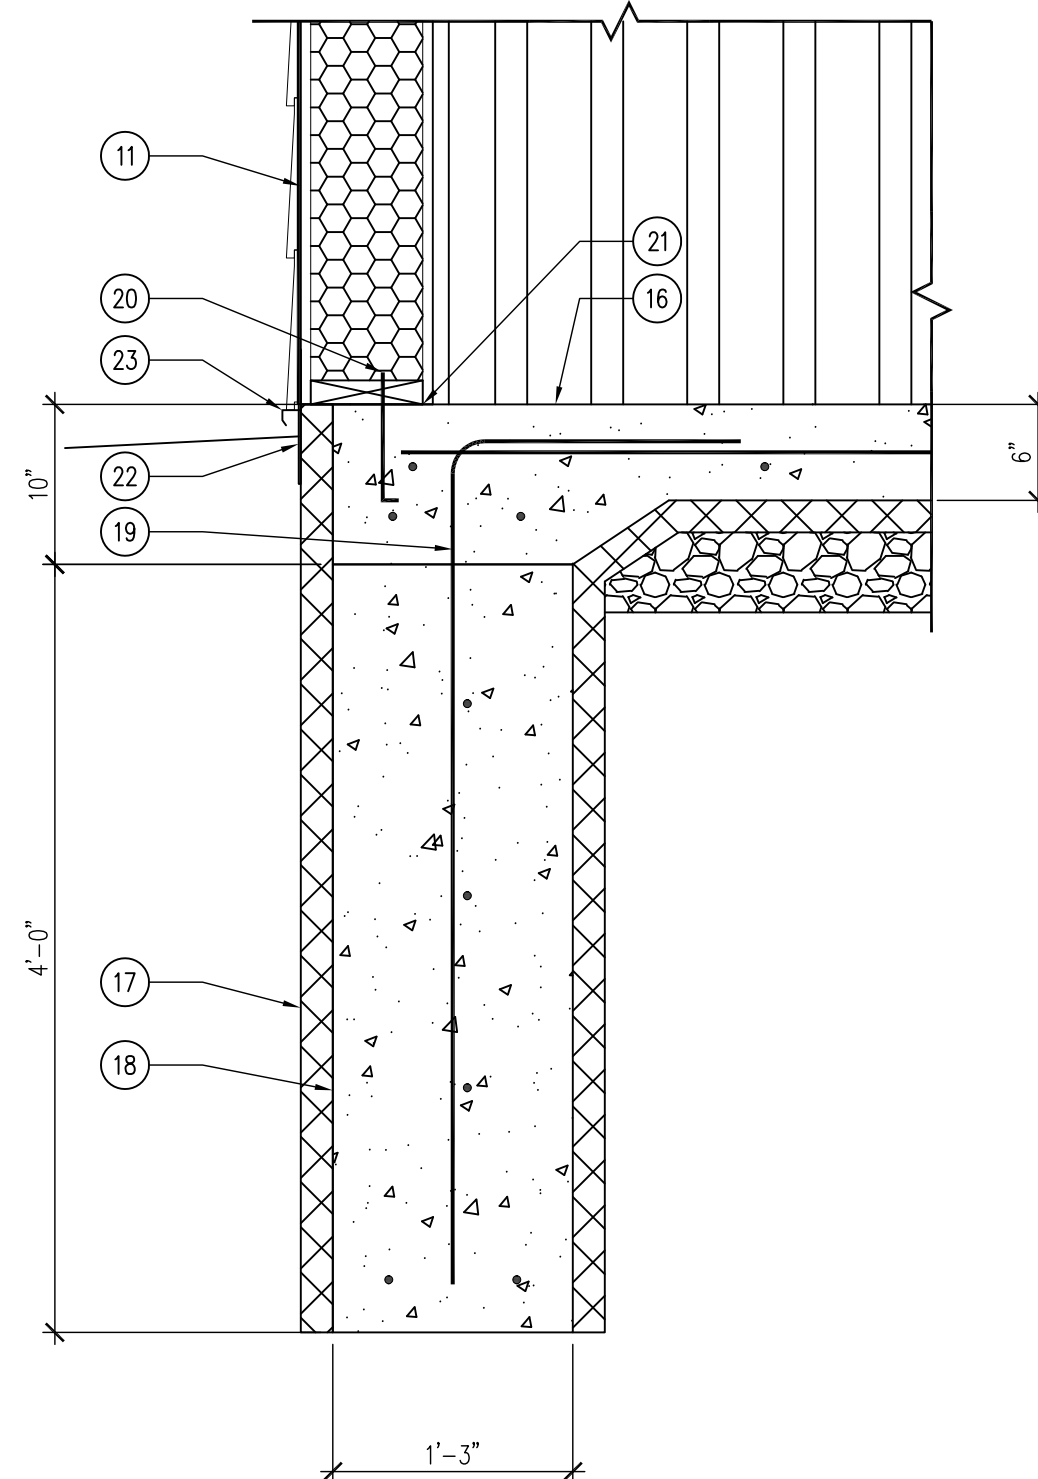

03 DETAIL - BOLLARD  
SCALE: NTS

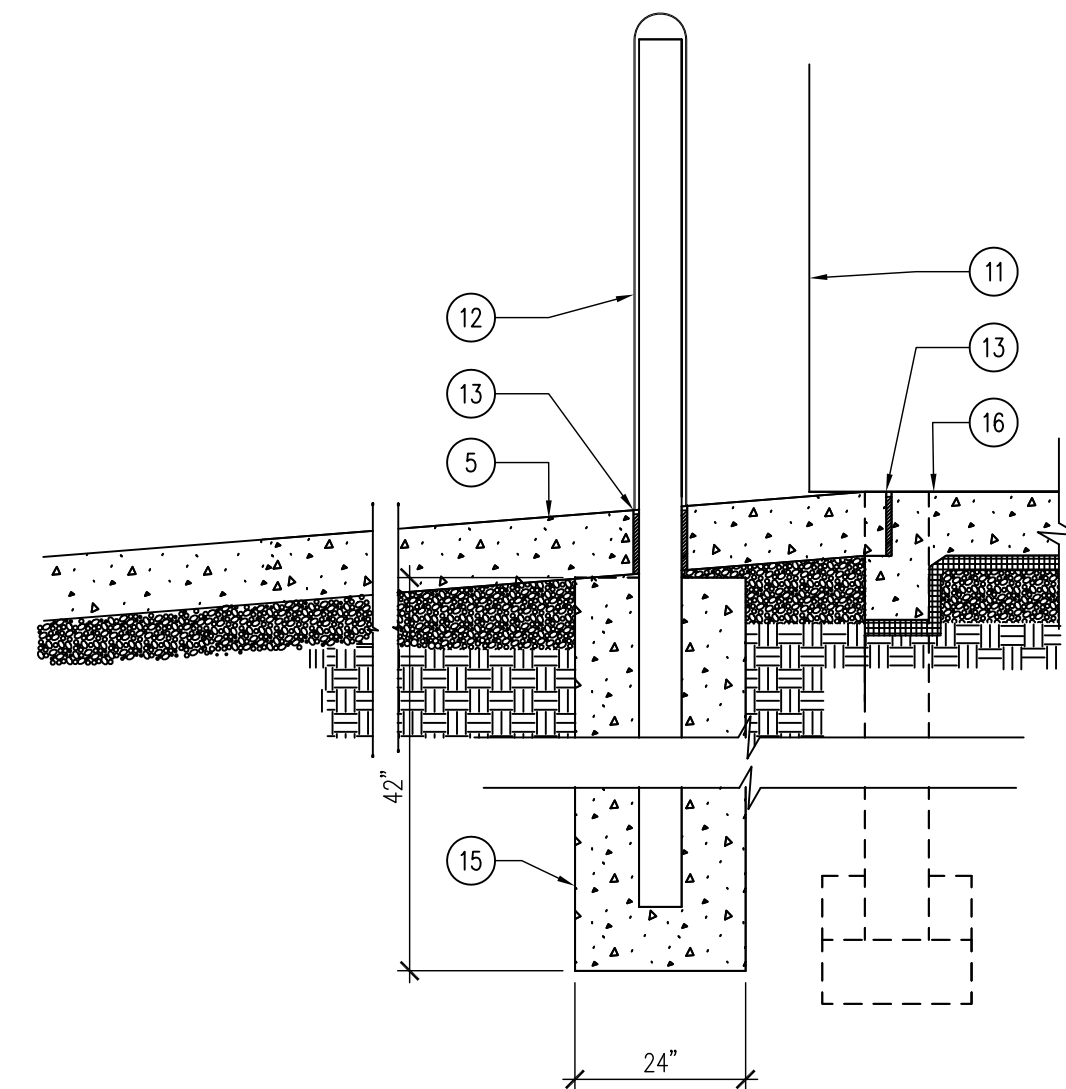

01 FUEL TANK PAD LAYOUT  
SCALE: NTS

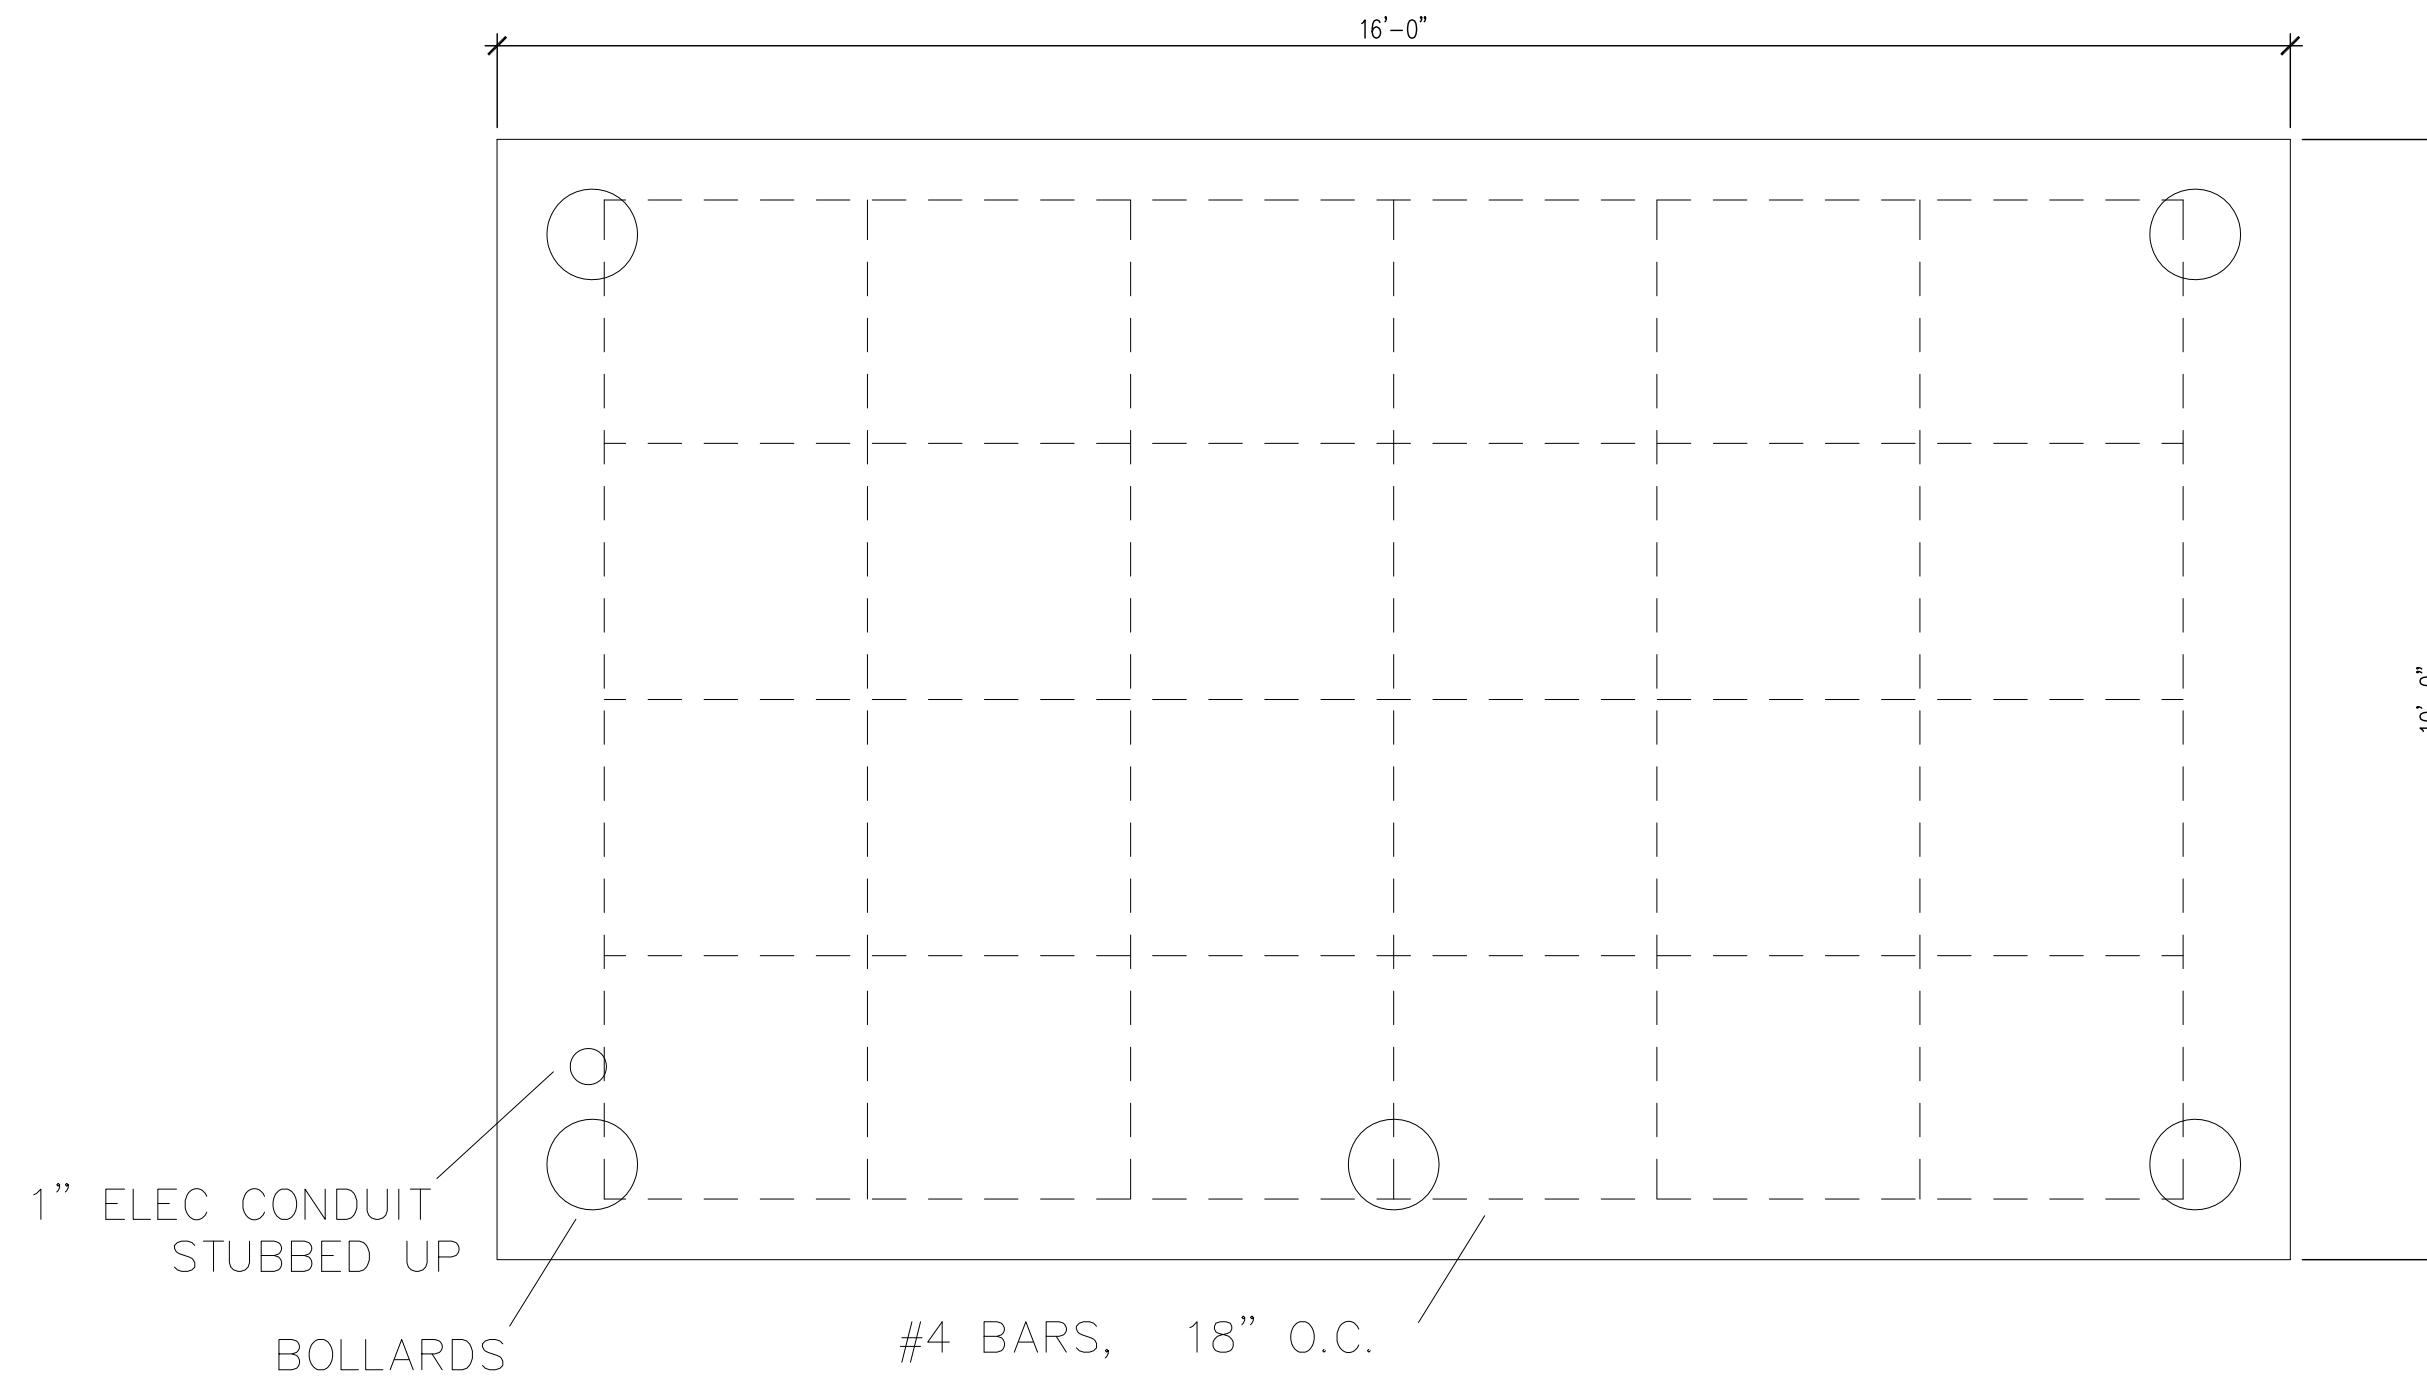

#### FUEL TANK NARRATIVE

CONTRACTOR SHALL PROVIDE:  
FUEL TANK - THE FUEL TANK SHALL BE A 500 GALLON DOUBLE WALL, SPLIT 250/250 WITH ALL NECESSARY GAUGES, VENTS, CAPS, DRAIN PLUGS, OVERSPILL CONTAINMENT AND DECALS. ALL WIRING IS TO BE EXPLOSION PROOF. TWO GASBOY 72-S FUEL PUMPS (OR EQUAL) ARE TO BE INCLUDED WITH THE TANK. INSTALLATION INCLUDES ELECTRICAL HOOKUP. TANK MUST MEET ALL APPLICABLE CODES FOR OUTSIDE FUEL STORAGE TANKS. ANY PERMITS NECESSARY WILL BE THE RESPONSIBILITY OF THE CONTRACTOR.  
TANK PAD - TANK SHALL BE BOLTED DOWN TO A CONCRETE PAD OF SUFFICIENT SIZE, TO BE POURED BY THE CONTRACTOR AT A LOCATION TO BE DETERMINED ON SITE. FOUR (4) BOLLARDS SHALL BE INSTALLED AT THE PERIMETER OF THE TANK PAD, SEE BOLLARD DETAIL FOR MORE INFORMATION.

#### KEYNOTES

- NEW 5'-0" ACCESSIBLE CONCRETE PEDESTRIAN SIDEWALK, REFER TO CIVIL PLANS.
- CRUSHED LIMESTONE EQUIPMENT YARD WITH 8'-0" CHAINLINK FENCING, REFER TO CIVIL PLANS.
- CONCRETE PARKING AREA, REFER TO CIVIL DRAWINGS.
- PROPOSED BUILDING, REFER TO REFERENCE PLAN SHEET A-100 & A-200.
- CONCRETE GARAGE APRON, REFER REFERENCE PLANS.
- EXISTING BUILDING TO REMAIN.
- UNIVERSAL ADA PARKING SYMBOL WITH 5'-0" WIDE STRIPED ACCESS LANE.
- CONCRETE PAD FOR NEW FUEL TANK, 6" THICK WITH #4 REBAR 18" O.C. BOTH DIRECTIONS, 12" SUBBASE, DIMENSION AS SHOWN.
- CHAINLINK SWING GATE, REFER TO CIVIL PLANS.
- EXISTING CONCRETE DRIVE TO REMAIN.
- PROPOSED BUILDING, REFER TO REFERENCE PLANS.
- 6" DIAMETER X 3/4" THICK STEEL POST, 8'-0" LONG, 3'-0" EMBEDDED IN CONCRETE FOOTING. FILL POST SOLID WITH CONCRETE GROUT, PROVIDE OSHA YELLOW PLASTIC COVER SLEEVES FOR ALL BOLLARDS.
- 1/2" EXPANSION JOINT WITH CONTINUOUS SEALANT.
- NOT USED.
- 24" DIAMETER CONCRETE FOOTING, MINIMUM 42" DEEP.
- BUILDING SLAB, REFER TO REFERENCE PLANS.
- 2" RIGID SUB-SLAB INSULATION. TAPE AND SEAL ALL JOINTS.
- 15" CONCRETE TRENCH FOUNDATION WITH #5 REBAR 12" O.C. BOTH DIRECTIONS WITH 18" OVERLAP, MINIMUM 48" DEEP.
- #4 "J" BAR, MINIMUM 36" EMBEDMENT INTO FOOTING, 24" EMBEDMENT INTO SLAB.
- SILL ANCHOR, BY BUILDING MANUFACTURER.
- SILL GASKET.
- CELLULAR PVC PROTECTION BOARD, PAINT TO MATCH SIDING.
- METAL FLASHING DRIP EDGE, MATCH SIDING COLOR.
- EXISTING 30' X 50' BUILDING TO RECEIVE NEW STEEL SIDING AND ROOF TO MATCH THE NEW STORAGE BUILDING.


#### GENERAL NOTES

- REFER TO FINISH, DOOR & WINDOW SCHEDULE, SHEET A-600.
- REFER TO REFLECTED CEILING PLAN FOR CEILING HEIGHTS, SHEET A-110.
- REFER TO INDEX SHEET FOR WALL TYPES, SHEET A-002.
- FIELD VERIFY ALL DIMENSIONS PRIOR TO CONSTRUCTION, SHEET A-101.
- FIELD VERIFY ALL EQUIPMENT LOCATIONS FOR ELECTRICAL OUTLET LOCATIONS, REFER TO ELECTRICAL PLAN.
- CONTRACTOR SHALL HAVE THIS BUILDING, PRIOR TO CONSTRUCTION, PRE-ENGINEERED BY BUILDING SUPPLIER.

#### ARCHITECTURAL SITE PLAN

NEW OFFICE & STORAGE BUILDING FOR:  
**GREEN VALLEY STATE PARK**

1480 130TH STREET  
UNION COUNTY, IOWA

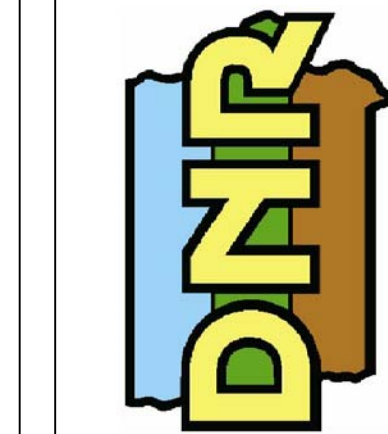

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CONSULTANT:

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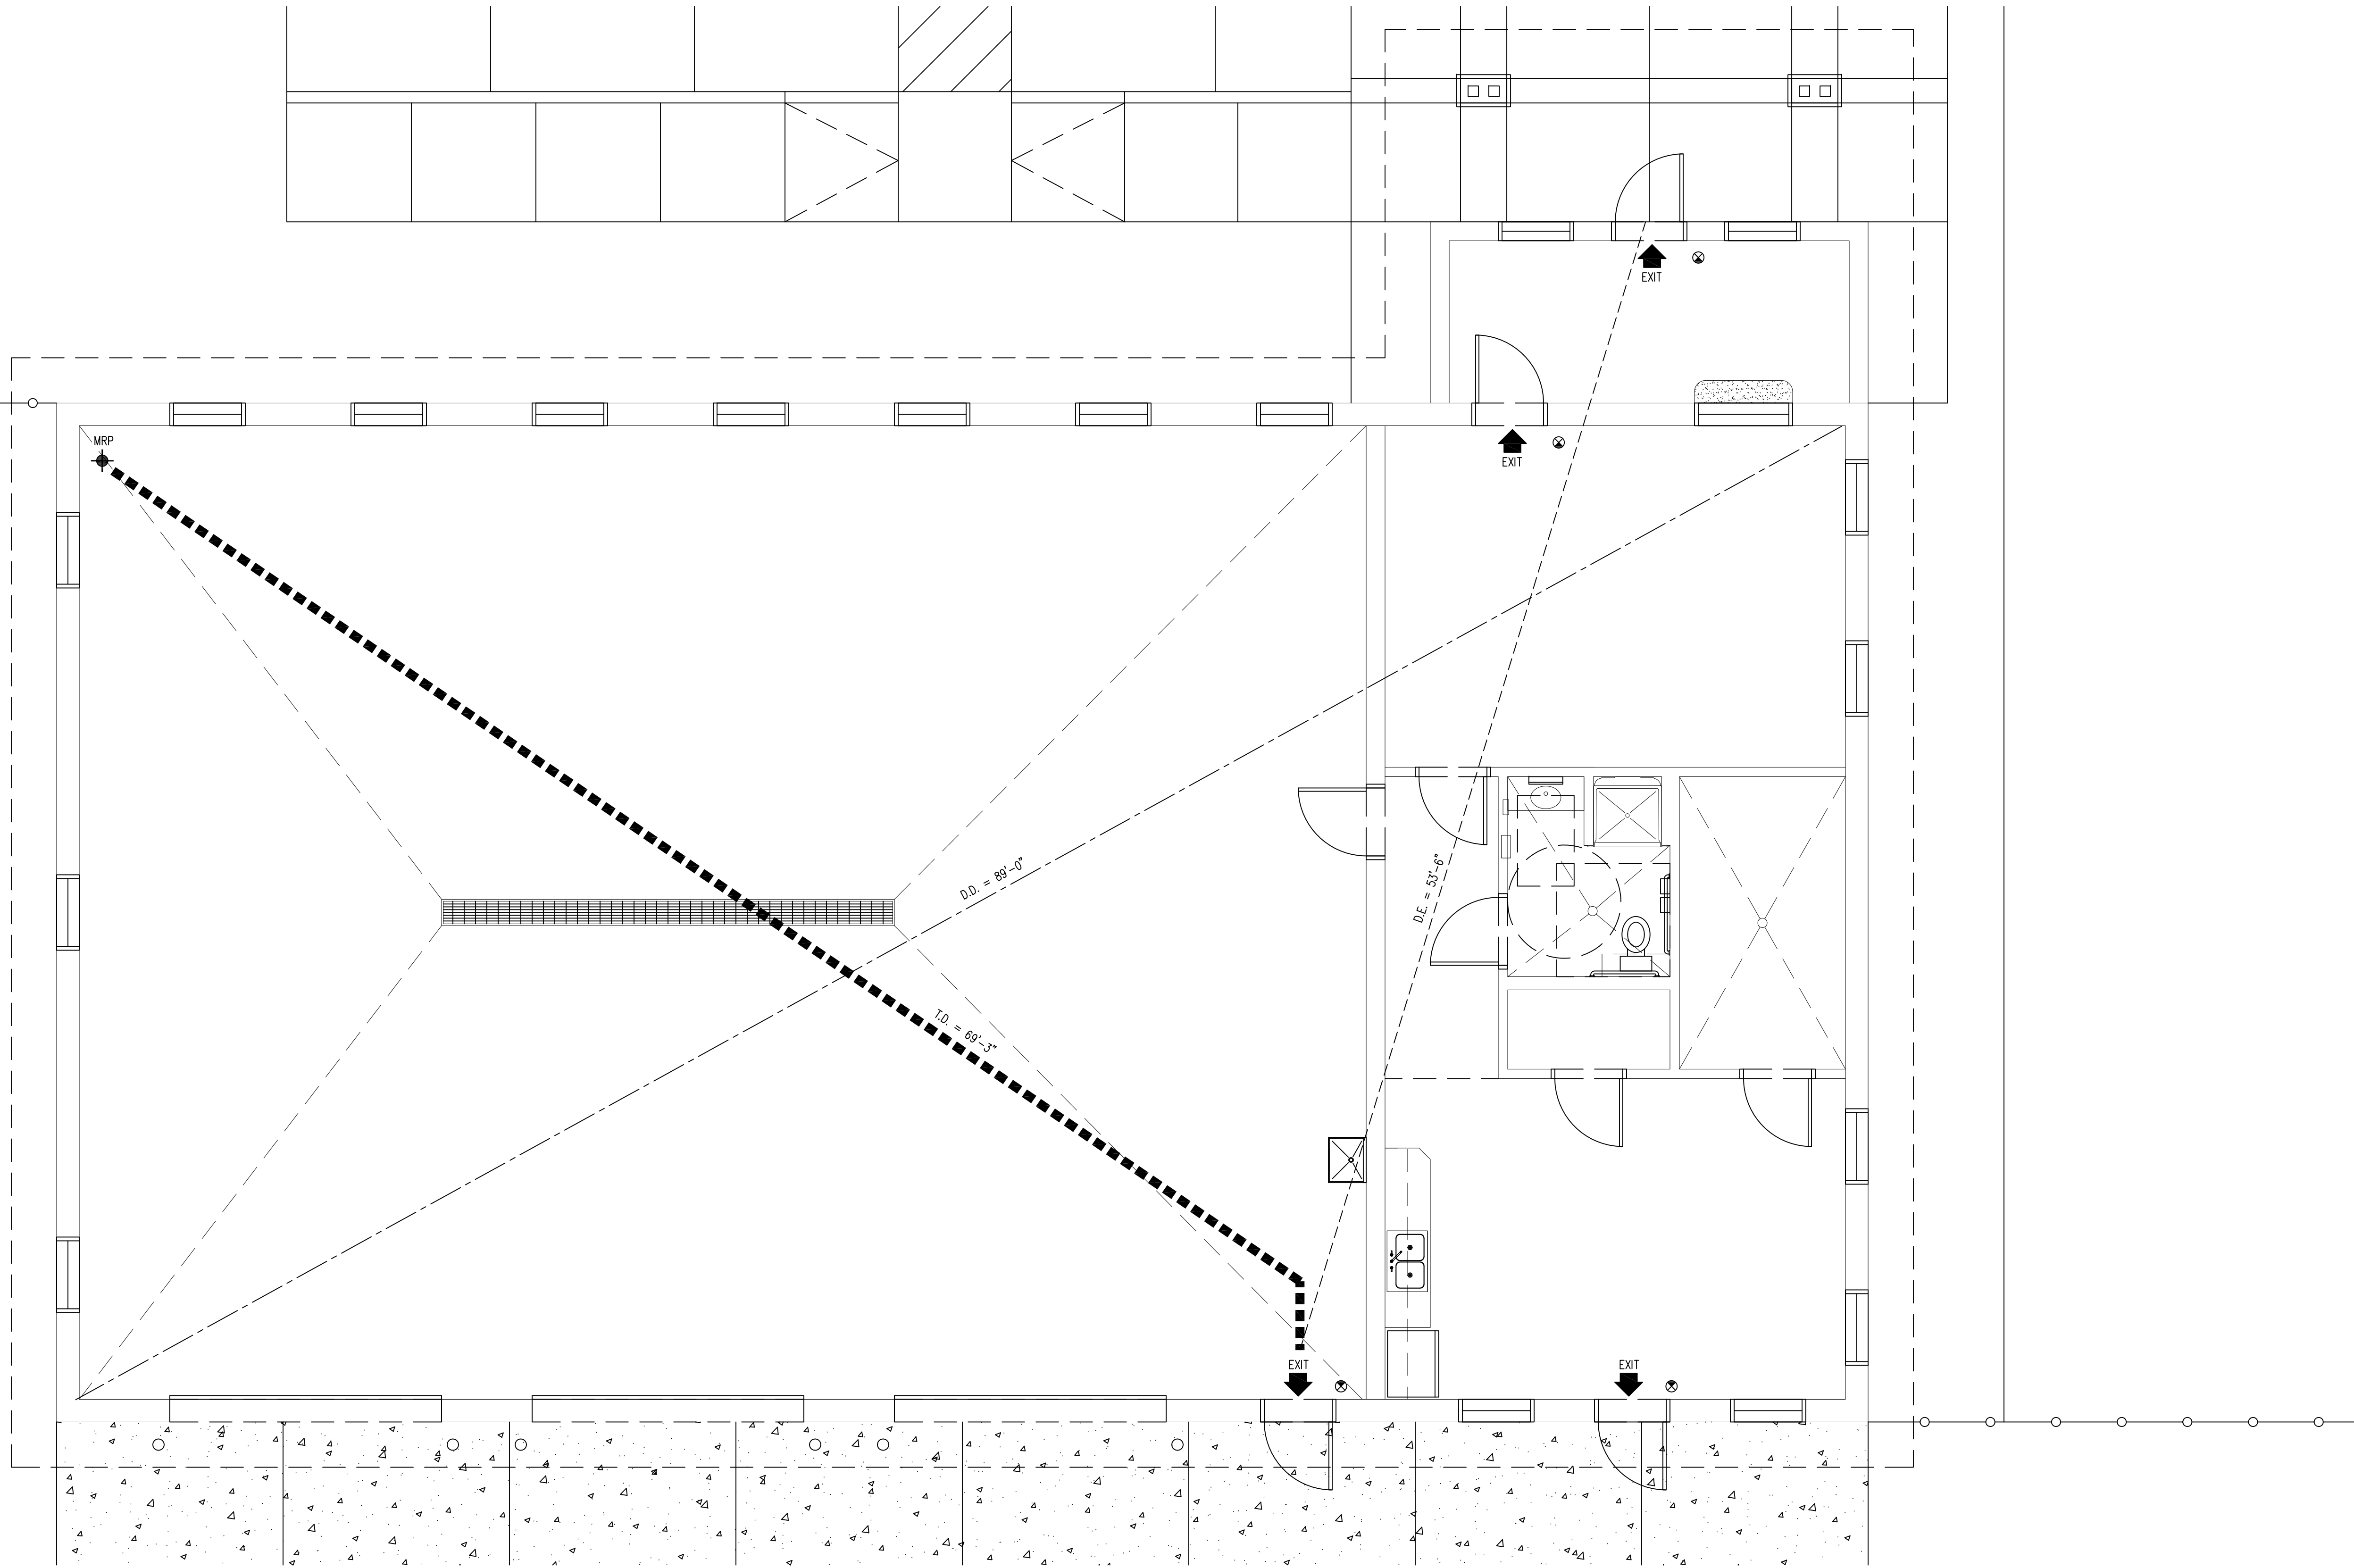
CHK'D BY: DATE:  
07.29.2015

SHEET No:

**A-010**



01 LIFE SAFETY PLAN  
SCALE: 1/4" = 1'-0"



CODE SUMMARY

	BUILDING AREA	3,754 GSF		REQUIRED	PROVIDED
	TENANT AREA	873 NSF	ALLOWABLE BLDG AREA (IBC TBL 503)	17,500 SF	3,754 SF
	CONSTRUCTION TYPE	V-B WITHOUT SPRINKLER SYSTEM			
	OCCUPANCY	GROUP B - BUSINESS / GROUP S-1 - STORAGE	HEIGHT LIMITATION (IBC TBL 503)	2 STORIES (40')	1 STORIES (15')
			AUTOMATIC SPRINKLER SYSTEM (NFPA 13)	NO	NO
			EXIT ACCESS TRAVEL DISTANCE (IBC 1016.1)	200'-0"	69'-3"
			EXIT ACCESS DOORWAYS (IBC TBL 1019.1)	1	3
			EGRESS WIDTH PER OCCUPANT (IBC TBL 1005.1) LEVEL [ .2"]	(.2") X 13 = 2.6"	3 DOORS @ 36"= 108"

LIFE SAFETY LEGEND

SYMBOL	DESCRIPTION	LINE TYPE
D.E.	EXIT TO EXIT IN LINEAR FEET	---
T.D.	TRAVEL DISTANCE FROM M.R.P.	■■■■■■■■■■
D.D.	DIAGONAL DISTANCE	----
⊗	EXIT LIGHT	
M.R.P.	MOST REMOTE POINT	◆
EXIT	EXIT / ENTRY	
[FEC]	FIRE EXTINGUISHER	

GENERAL NOTES

- a. INFORMATION PROVIDED ON THE LIFE SAFETY PLAN INDICATES EGRESS REQUIREMENTS.  
b. ALL CODE REFERENCES ARE FROM INTERNATIONAL BUILDING CODE, W/ AMENDMENTS UNLESS OTHERWISE NOTED


LIFE SAFETY PLAN

NEW OFFICE & STORAGE BUILDING FOR:

GREEN VALLEY STATE PARK

1480 130TH STREET  
UNION COUNTY, IOWA

CONSULTANT:

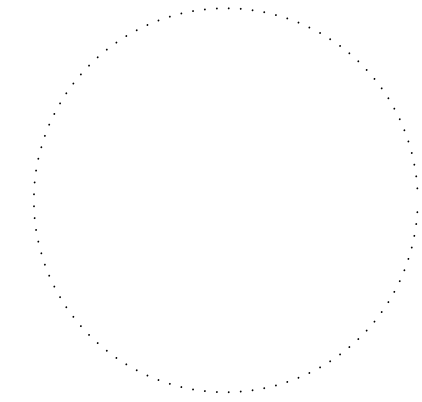

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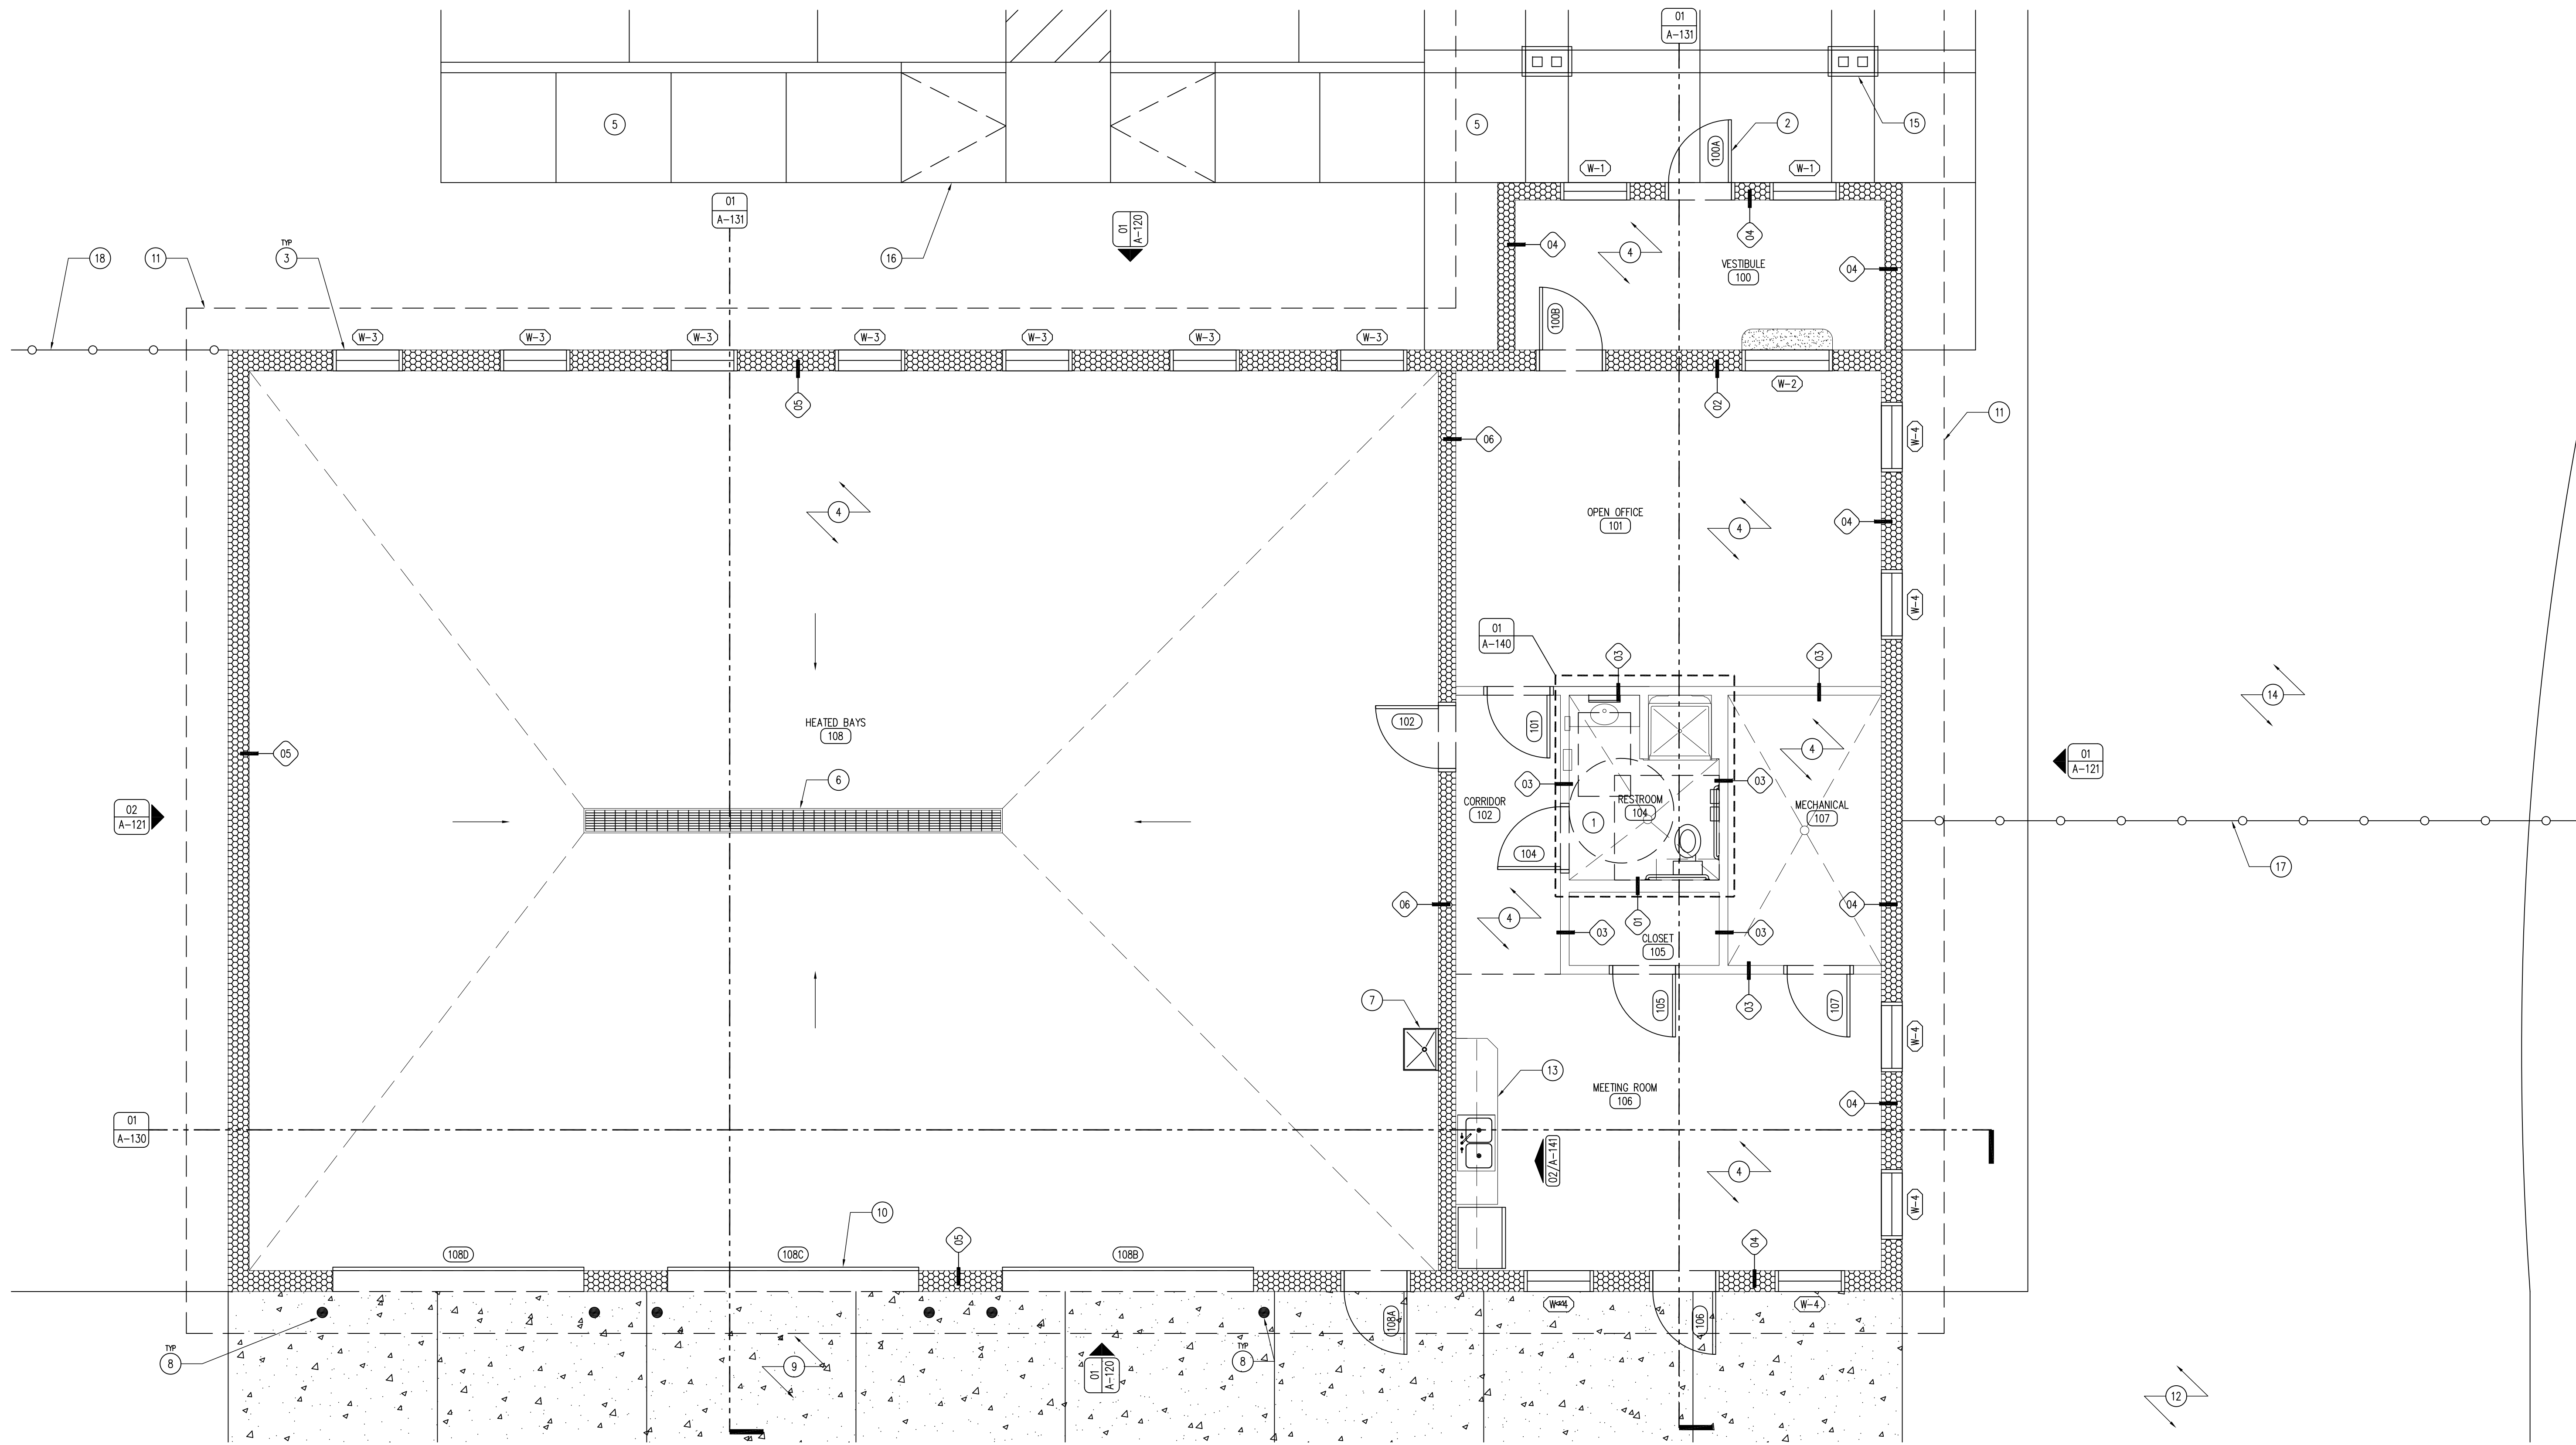
DRAWN BY: PROJECT NUMBER:  
15-04-88-01

CHK'D BY: DATE:  
07.29.2015

SHEET NO:

A-020





01 REFERENCE FLOOR PLAN  
SCALE: 1/4" = 1'-0"

KEYNOTES

- UNI-SEX RESTROOM, REFER TO ENLARGED FLOOR PLAN 01/A-140 FOR MORE INFORMATION.
- DOOR AS SCHEDULED, REFER TO SHEET A-600.
- WINDOW AS SCHEDULED, REFER TO SHEET A-600.
- FLOOR FINISH AS SCHEDULED, REFER TO SHEET A-600.
- CONCRETE SIDEWALK, REFER TO CIVIL DRAWINGS.
- TRENCH DRAIN WITH HEAVY DUTY STEEL GRATE, REFER TO PLUMBING DRAWINGS.
- UTILITY SINK, REFER TO PLUMBING DRAWINGS.
- STEEL TRAFFIC BOLLARD, REFER TO DETAIL 04/A-010.
- 6" CONCRETE SLAB APRON WITH #4 REBAR 24" O.C. WITH 4" SUBBASE, TO EXTENT ENTIRE LENGTH OF BUILDING.
- OVERHEAD GARAGE DOOR, REFER TO DOOR SCHEDULE SHEET A-600.
- ROOF LINE ABOVE.
- CRUSHED LIMESTONE EQUIPMENT YARD WITH 8'-0" CHAINLINK PERIMETER FENCE.
- CABINETS AND COUNTER-TOP AS SPECIFIED, REFER TO SHEET A-141.
- CONCRETE DRIVE, REFER TO CIVIL DRAWINGS.
- COLUMN BASE, REFER TO SHEET A-120 FOR MORE INFORMATION.
- ADA SIDEWALK RAMP WITH DETECTION STRIP, REFER TO CIVIL DRAWINGS FOR MORE INFORMATION.
- FENCE SWING-GATE, REFER TO CIVIL DRAWINGS FOR MORE INFORMATION.
- FENCING, REFER TO CIVIL DRAWINGS FOR MORE INFORMATION.

GENERAL NOTES

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- FIELD VERIFY ALL DIMENSIONS PRIOR TO CONSTRUCTION, SHEET A-101.
- FIELD VERIFY ALL EQUIPMENT LOCATIONS FOR ELECTRICAL OUTLET LOCATIONS, REFER TO ELECTRICAL PLAN.
- CONTRACTOR SHALL HAVE THIS BUILDING, PRIOR TO CONSTRUCTION, PRE-ENGINEERED BY BUILDING SUPPLIER.

REFERENCE FLOOR PLAN

NEW OFFICE & STORAGE BUILDING FOR:

GREEN VALLEY STATE PARK

1480 130TH STREET

UNION COUNTY, IOWA

CONSULTANT:

IOWA DEPARTMENT OF  
NATURAL RESOURCES

ENGINEERING SERVICES - WALLACE BUILDING  
502 E. 9TH ST., DES MOINES, IA 50319-0034  
P: 515.725.8200  
F: 515.725.8202



NO. BY DATE REVISION

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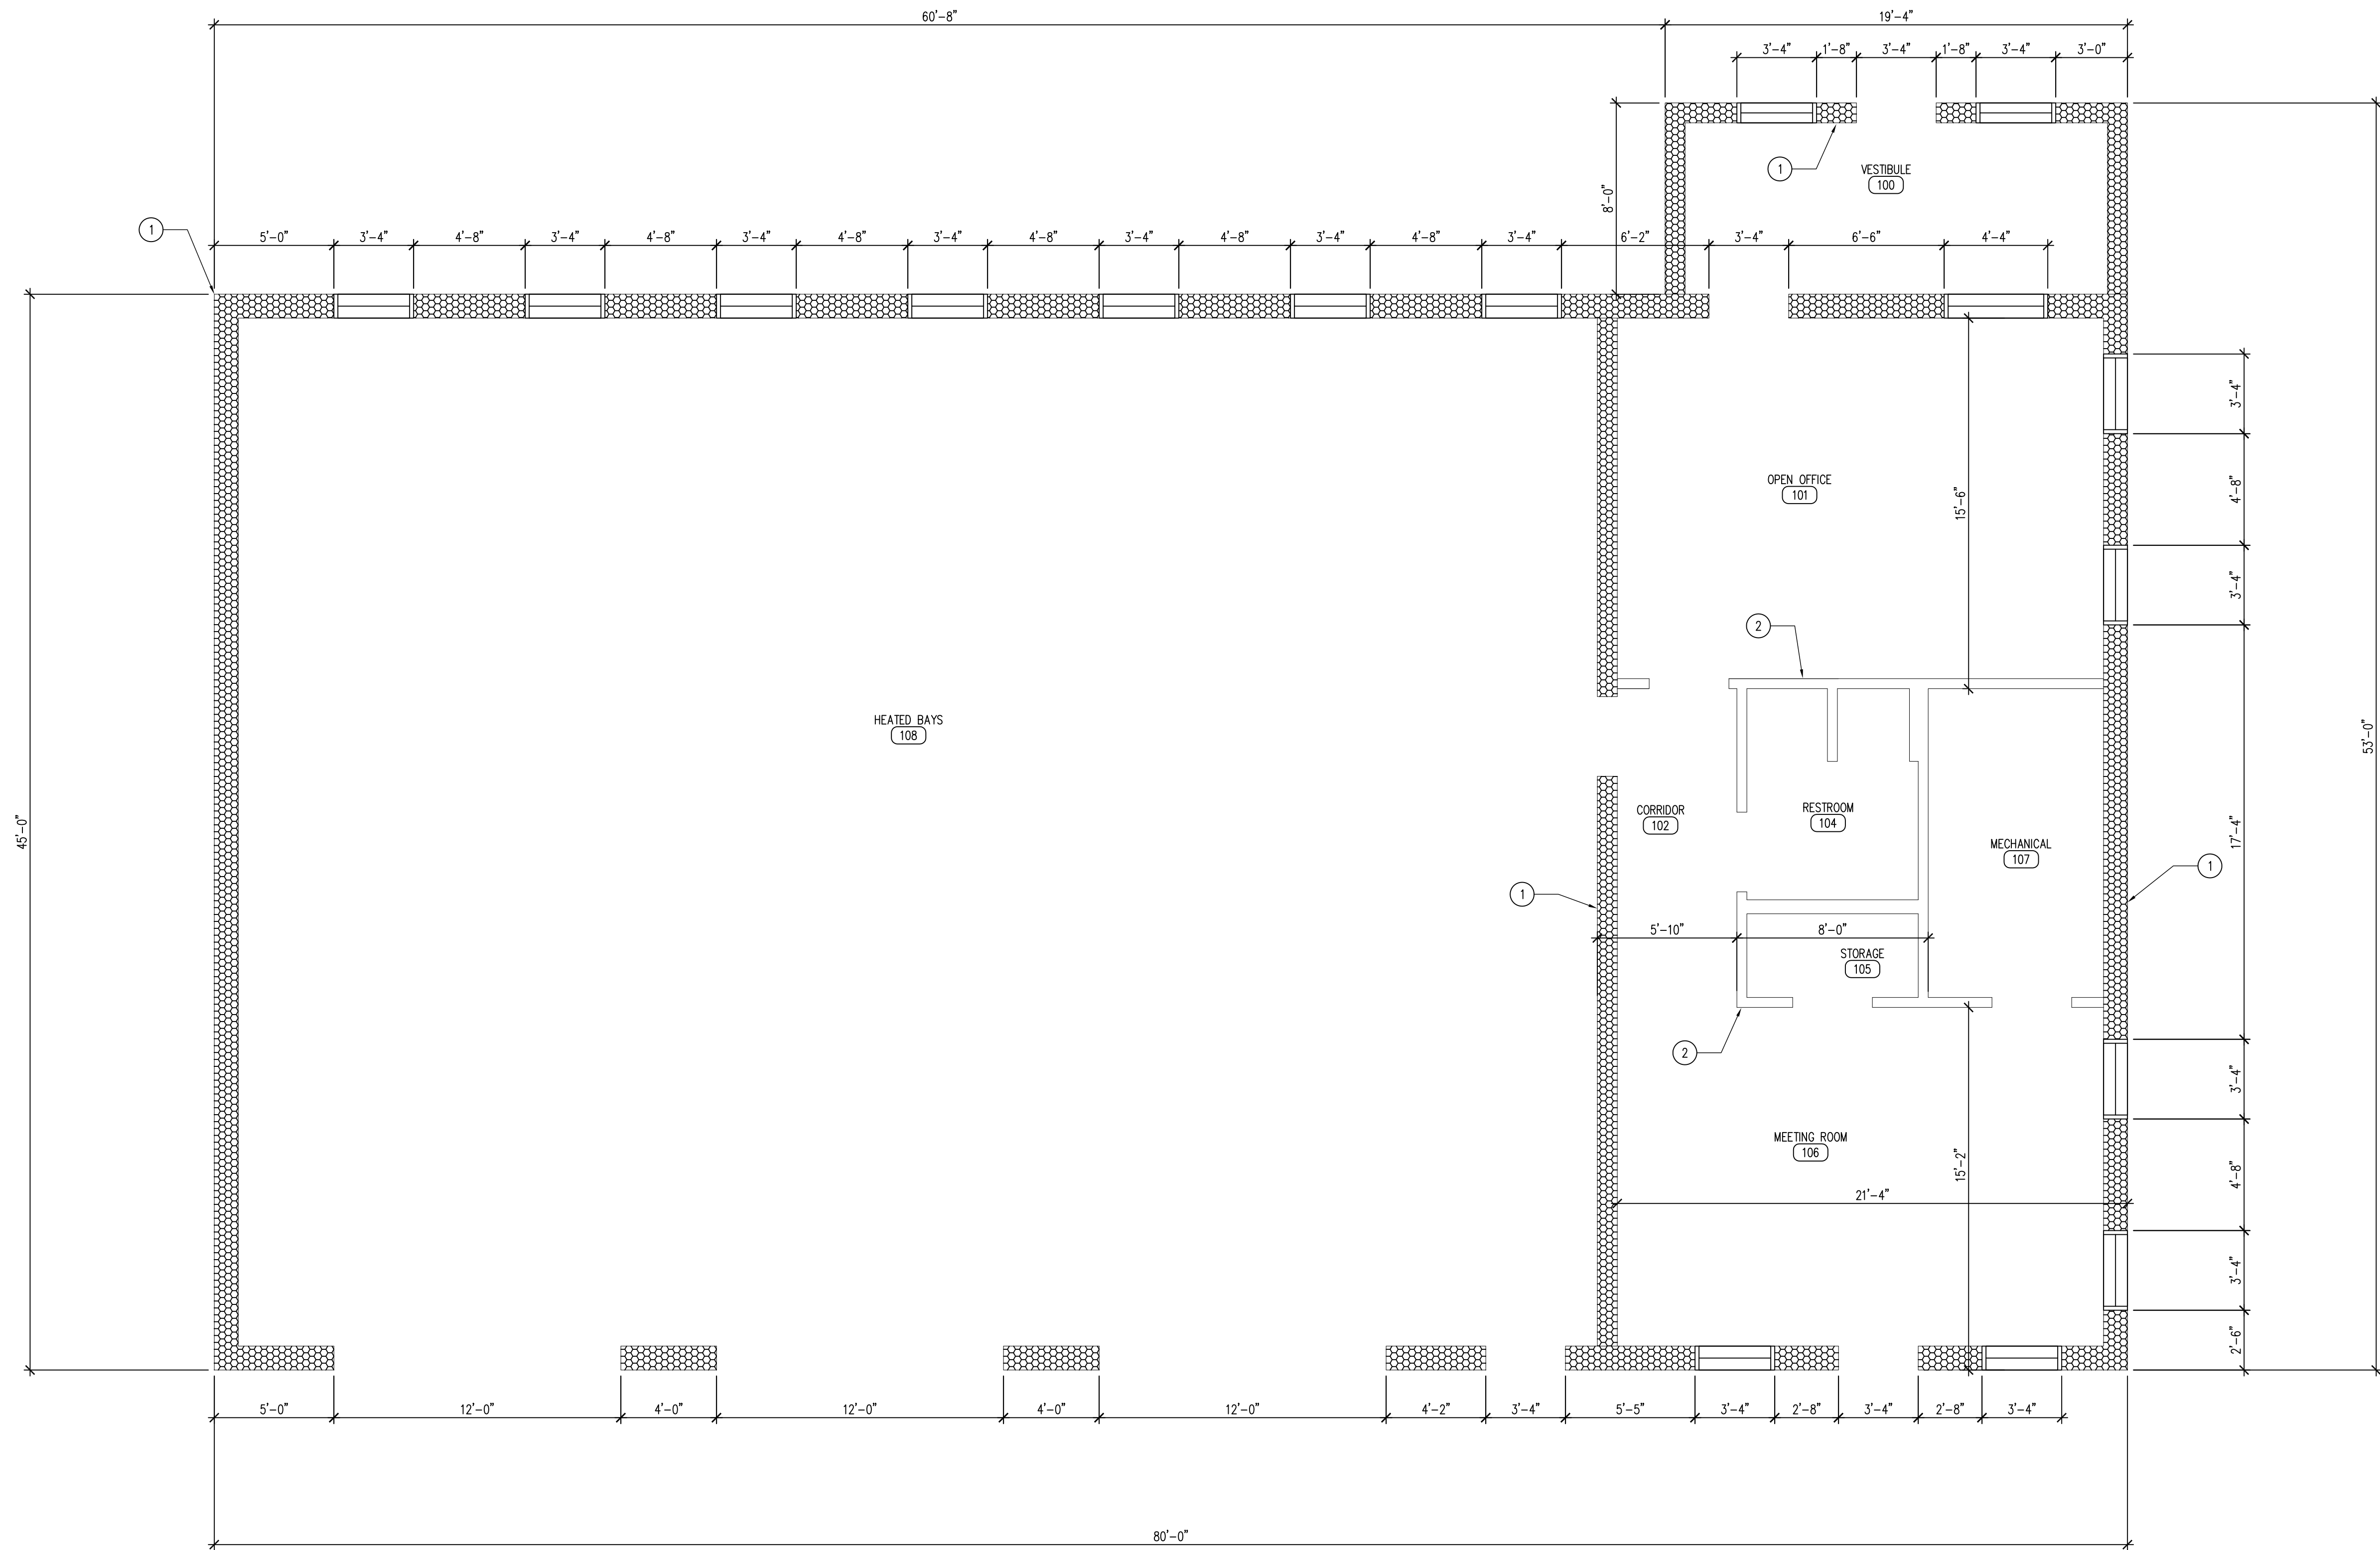
CHK'D BY: DATE:

07.29.2015

SHEET NO:

A-100





**01** DIMENSION FLOOR PLAN  
SCALE: 1/4" = 1'-0"

KEYNOTES

1. STRUCTURAL INSULATED PANEL WALL, SEE WALL TYPES SHEET A-002.
2. INTERIOR STUD WALL, SEE WALL TYPES SHEET A-002.

GENERAL NOTES

- A. REFER TO FINISH, DOOR & WINDOW SCHEDULE, SHEET A-600.
- B. REFER TO REFLECTED CEILING PLAN FOR CEILING HEIGHTS, SHEET A-110.
- C. REFER TO INDEX SHEET FOR WALL TYPES, SHEET A-002.
- D. FIELD VERIFY ALL DIMENSIONS PRIOR TO CONSTRUCTION, SHEET A-101.
- E. FIELD VERIFY ALL EQUIPMENT LOCATIONS FOR ELECTRICAL OUTLET LOCATIONS, REFER TO ELECTRICAL PLAN.
- F. CONTRACTOR SHALL HAVE THIS BUILDING, PRIOR TO CONSTRUCTION, PRE-ENGINEERED BY BUILDING SUPPLIER.


DIMENSION FLOOR PLAN

NEW OFFICE & STORAGE BUILDING FOR:

**GREEN VALLEY STATE PARK**

UNION COUNTY, IOWA  
1480 130TH STREET

CONSULTANT:

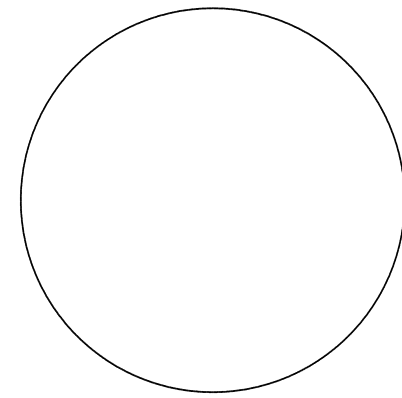

**IOWA DEPARTMENT OF  
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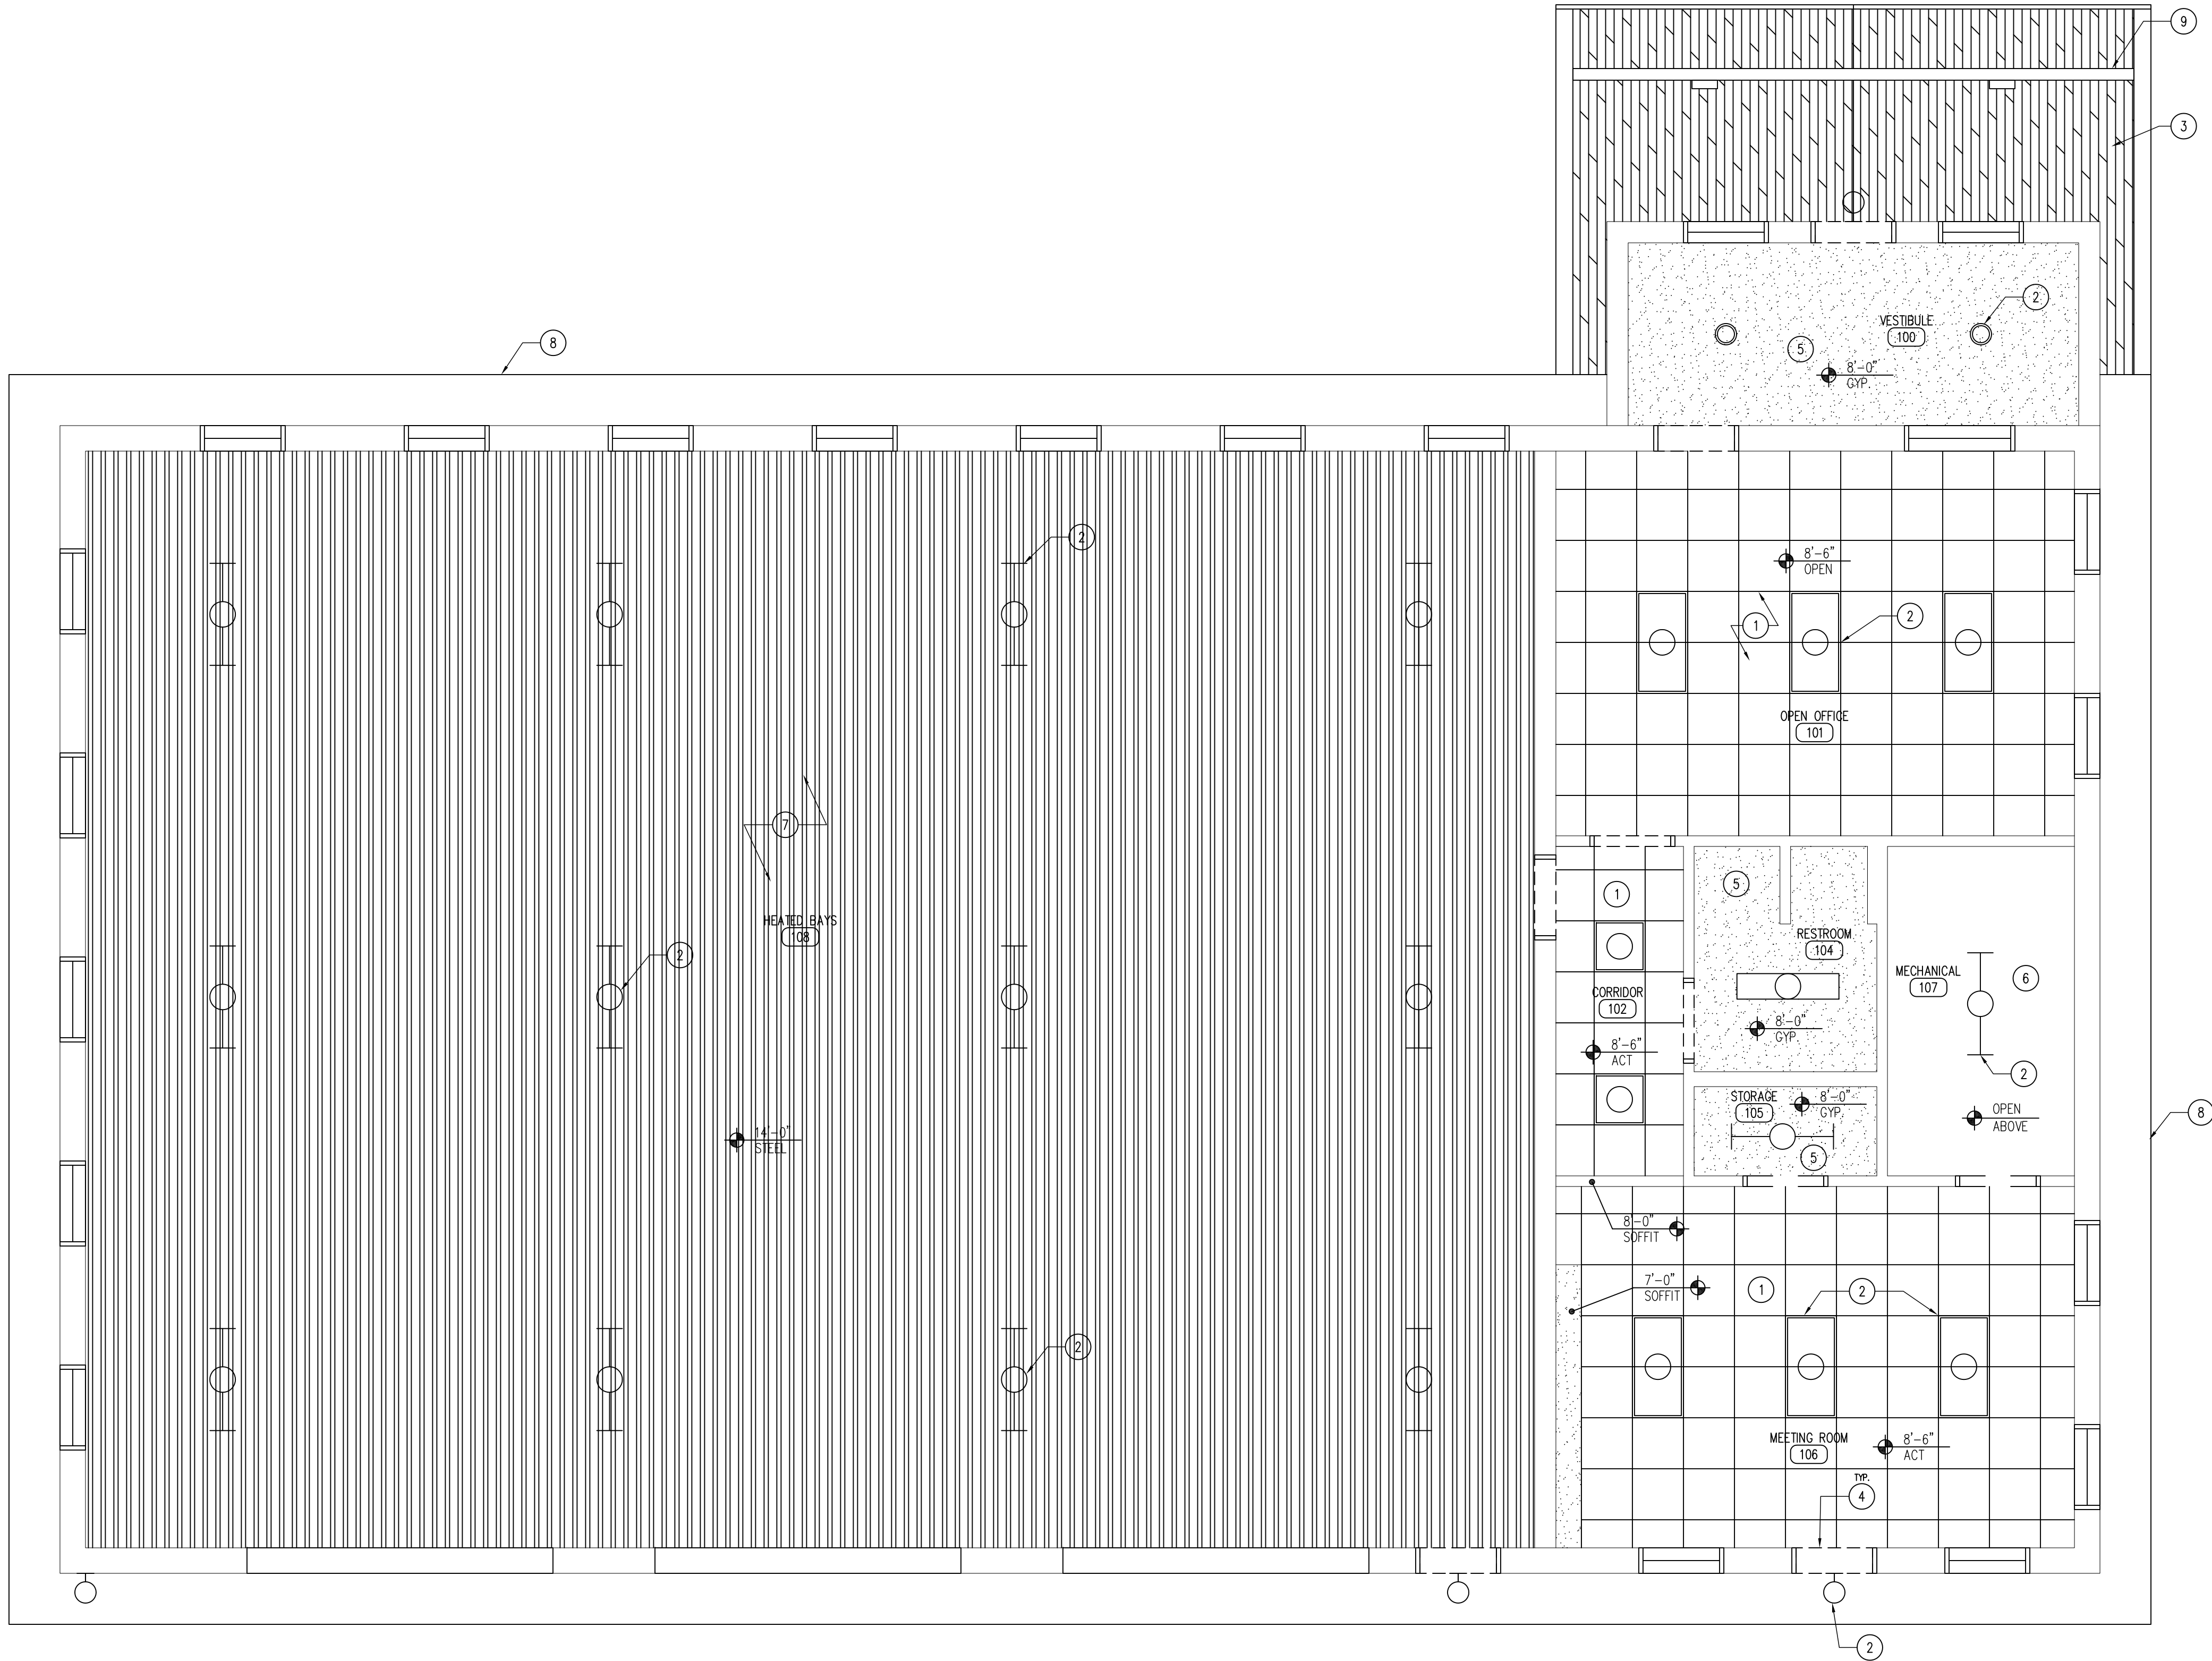
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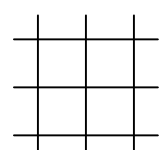
**A-101**




01 REFLECTED CEILING PLAN  
SCALE: 1/4" = 1'-0"



LEGEND



2' x 2' CEILING TILE AND GRID SYSTEM

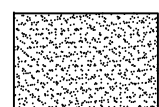

REXWALL ESSENTIAL BOARD




29 GAUGE LINER PANEL




FLUORESCENT / LED CAN LIGHT FIXTURE




WALL SCONCE/WALL PACK

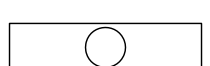

FLUORESCENT LIGHT FIXTURE.

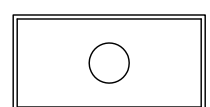

2' x 4' FLUORESCENT LIGHT FIXTURE.

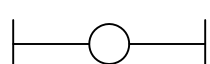

2' x 4' FLUORESCENT LIGHT FIXTURE  
SURFACE MOUNTED

KEYNOTES

- 2' X 2' X 3/8" ARMSTRONG ULTIMA (REGULAR) ACOUSTICAL CEILING TILE WITH 1/2" PRELUDE SUSPENSION SYSTEM.
- ELECTRICAL LIGHT FIXTURE, REFER TO ELECTRICAL DRAWINGS FOR FIXTURE SPECIFICATIONS AND POWER REQUIREMENTS.
- 3X DOUGLAS FIR T&G CEILING, TWO COATS OF CLEAR POLYURETHANE.
- DOOR HEADER BELOW.
- 5/8" GYPSUM HARD CEILING.
- NO-CEILING - OPEN TO GYPSUM DECKING ABOVE.
- 29 GAUGE LINER PANEL - WHITE.
- FLUSH SOFFIT PANELS TO MATCH STANDING SEAM METAL ROOF.
- DOUGLAS FIR, HEAVY TIMBER, ROUGH SAWN TRUSS.

GENERAL NOTES

- REFER TO FINISH, DOOR & WINDOW SCHEDULE, SHEET A-600.
- REFER TO REFLECTED CEILING PLAN FOR CEILING HEIGHTS, SHEET A-110.
- REFER TO INDEX SHEET FOR WALL TYPES, SHEET A-002.
- FIELD VERIFY ALL DIMENSIONS PRIOR TO CONSTRUCTION, SHEET A-101.
- FIELD VERIFY ALL EQUIPMENT LOCATIONS FOR ELECTRICAL OUTLET LOCATIONS, REFER TO ELECTRICAL PLAN.
- CONTRACTOR SHALL HAVE THIS BUILDING, PRIOR TO CONSTRUCTION, PRE-ENGINEERED BY BUILDING SUPPLIER.

REFLECTED CEILING PLAN

NEW OFFICE & STORAGE BUILDING FOR:

GREEN VALLEY STATE PARK

1480 130TH STREET  
UNION COUNTY, IOWA

CONSULTANT:

IOWA DEPARTMENT OF  
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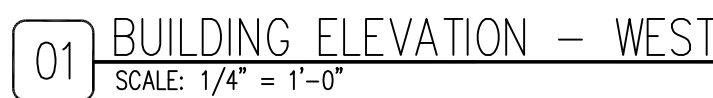
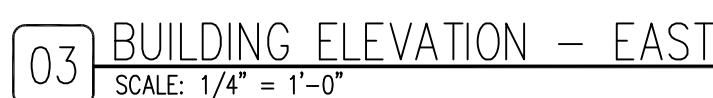
CHK'D BY: DATE:

07.29.2015

SHEET No:

A-110





## GENERAL NOTES

- |   |  |   |  |  |
|---|--|---|--|--|
| <p>WINDOW AS SCHEDULED, REFER TO SHEET A-600.</p> <p>8 1/2" JAMES HARDIE PLANK LAP SIDING, SELECT CEDAR/MILK, COLOR TO BE TIMBER BARK.</p> <p>METAL VENTED FLUSH-SOFFIT AND FASCIA PANEL. COLOR TO MATCH ROOF.</p> <p>PAC-CLAD SNAP-CLAD METAL ROOF, COLOR TO BE DARK BRONZE.</p> <p>DOOR AS SCHEDULED, REFER TO SHEET A-600.</p> <p>SEAMLESS METAL GUTTER AND DOWNSPOUT SYSTEM WITH LEAF GUARD TO MATCH ROOF.</p> <p>TRAFFIC BOLLARD WITH PLASTIC COVER SLEEVE, REFER TO 02/A-202.</p> <p>SNOW AND ICE GUARD BAR, PLACE OVER ENTIRE EAVE OF ROOF, BOTH SIDES.</p> <p>2X BLOCKING AS REQUIRED.</p> <p>INSULATION BAFFLE.</p> <p>TRUSS HANGER CLIP (SPECIFIED BY BUILDING MANUFACTURER).</p> <p>TRUSS (SPECIFIED BY BUILDING MANUFACTURER), FOR DEMONSTRATION PURPOSES ONLY.</p> <p>STRUCTURAL INSULATED PANEL (SIP) WALL, BY BUILDING MANUFACTURER.</p> <p>VAPOR BARRIER, PER MANUFACTURER'S RECOMMENDATIONS.</p> <p>TOP PLATE WITH SEALANT ON ALL JOINTS, PER BUILDING MANUFACTURER'S RECOMMENDATIONS.</p> <p>R-42 CERTAINTED FIBER-GLASS BATT ROOF INSULATION.</p> <p>3/4" PLYWOOD ROOF DECK SHEATHING WITH WATER AND ICE SHIELD OVER ENTIRE ROOF.</p> <p>PAC-CLAD RIDGE VENT AND CAP, MATCH COLOR OF ROOF.</p> <p>ROOF CLIPS, PER MANUFACTURER'S RECOMMENDATIONS.</p> <p>CONTINUOUS TRENCH FOOTING FOUNDATION, REFER TO DETAIL 02/A-130.</p> | <p>29 GAUGE STEEL LINER PANEL THROUGHOUT ENTIRE HEATED BAY AREA - WHITE.</p> <p>2" SUB-SLAB RIGID INSULATION UNDER ENTIRE SLAB AND AROUND PERIMETER OF FOUNDATION. TAPE AND SEAL ALL JOINTS.</p> <p>3/2" EXPANSION JOINT WITH SEALANT.</p> <p>TREATED SIP SILL PLATE, PER MANUFACTURER'S RECOMMENDATIONS.</p> <p>3/8" TYPE X GYPSUM BOARD DECK. INSTALL DIRECTLY TO TRUSSES THROUGHOUT OFFICE AREA.</p> <p>5.5" JAMES HARDIE 4/4 RUSTIC TRIM BOARDS, PRIMED AND PAINTED DARK BRONZE AROUND WINDOWS AND DOORS, COLOR TO MATCH SIDING ON BUILDING CORNERS.</p> <p>6" SOUND BATT INSULATION.</p> <p>4" SOUND BATT INSULATION.</p> <p>ADA ACCESSIBLE DOOR THRESHOLD.</p> <p>24 X 24 ARMSTRONG ULTIMA REGULAR ACOUSTIC CEILING TILES, REFER TO SHEET A-600.</p> <p>PARTITION WALL AS SCHEDULED, REFER TO SHEET A-002.</p> <p>TRENCH DRAIN, REFER TO PLUMBING DRAWINGS.</p> <p>33" R-19 BATT INSULATION.</p> <p>2X FASCIA, WRAP IN BREAK METAL TO MATCH ROOF.</p> <p>3/4" METAL VAPOR FLASHING BY ROOFING MANUFACTURER.</p> <p>METAL SILL FLASHING BY BUILDING MANUFACTURER.</p> <p>METAL HEAD-WALL FLASHING BY ROOFING MANUFACTURER.</p> <p>OVERHEAD GARAGE DOOR, REFER TO SHEET A-600.</p> | <p>6" CONCRETE SLAB WITH CONTINUOUS #4 REBAR 24" O.C. BOTH DIRECTIONS, OVER 2" SUB-SLAB RIGID INSULATION, TAPED AND SEALED, WITH 4" SUBBASE OVER POLYETHYLENE VAPOR BARRIER.</p> <p>#5 DOWEL, EMBED INTO SLAB 24" MINIMUM.</p> <p>WALL FINISH AS SCHEDULED, REFER TO SHEET A-600.</p> <p>METAL FLASHING, MATCH ROOF COLOR.</p> <p>BACKER ROD AND SEALANT.</p> <p>#5 DOWEL-ROUND "J" HOOK, EMBED 36" INTO FOOTING, 18" INTO SLAB.</p> <p>6X6 ROUGH-SAWN DOUGLAS FIR COLUMN, STAIN WITH TWO COATS TWP 103.</p> <p>HEAVY TIMBER, ROUGH-SAWN DOUGLAS FIR TRUSS, STAIN TWO COATS TWP 103 WITH OVERSIZED METAL BRACKETS AS SHOWN, POWDER COAT BLACK.</p> <p>3/4" X 4" HARD MAPLE TRIM, REFER TO SHEET A-600.</p> <p>3X DOUGLAS FIR T&amp;G DECKING, TWO COATS OF CLEAR POLYURETHANE.</p> <p>CEILING AS SCHEDULED, REFER TO SHEET A-110.</p> <p>UTILITY SINK, REFER TO PLUMBING DRAWINGS.</p> <p>RUBBER BASE, REFER TO SHEET A-600.</p> <p>CELLULAR PVC PROTECTION BOARD.</p> <p>STONE WATER-TABLE, STONE TO BE ROUND-SIDE, OUT, SPLIT-FACE, GRANITE BOULDERS - THIN VENEER, BY EDEN STONE. MORTAR TO BE ASTM C270, COLOR TBD.</p> <p>4" HONED INDIANA Limestone WATER-TABLE DRIP EDGE CAP-STONE, BUFF COLORED.</p> <p>STONE COLUMN DOOR, STONE TO MATCH WALL STONE.</p> | <p>56 4" HONED INDIANA Limestone COLUMN CAP, BUFF COLORED, WITH DRIP EDGE.</p> <p>CAST IN PLACE CONCRETE COLUMN FOUNDATION WITH #4 REBAR 12" O.C. ALL DIRECTIONS.</p> <p>2X6 CEDAR FASCIA TRIM EDGE, STAIN TWO COATS TWP 103.</p> <p>SILL GASKET.</p> <p>3/8" OVERSIZED MILD-STEEL TRUSS BRACKET, POWDER COAT BLACK. ALL HARDWARE TO BE 3/4" GALVANIZED WITH LOCK WASHERS.</p> <p>STEEL COLUMN BASE PLATE, 3/8" MILD-STEEL POWDER COATED BLACK. ANCHOR BOLTS TO BE UNDER COLUMNS, FLOT HOLE CAP AND BASE PLATE, THEN EPOXY SET ANCHOR BOLTS TO CONCRETE BASE LEVEL. EMBED MINIMUM 18".</p> <p>CONCRETE WALK WITH SUBBASE, REFER TO CIVIL DRAWINGS.</p> <p>SILL ANCHOR, PER BUILDING MANUFACTURER'S RECOMMENDATIONS.</p> <p>WATER AND ICE SHIELD OVER ENTIRE ROOF DECKING PER MANUFACTURER'S RECOMMENDATIONS.</p> <p>2X OUTRIGGER EAVE, PER BUILDING MANUFACTURER.</p> <p>METAL RAKE EDGE FLASHING BY ROOFING MANUFACTURER.</p> <p>6" CONCRETE APRON SLAB WITH CONTINUOUS #4 REBAR 24" O.C. BOTH DIRECTIONS WITH 4" SUBBASE.</p> <p>STOOP FOOTING, EXTEND 48", #5 DOWELS INTO SLAB 12" O.C., 18" EMBEDMENT MINIMUM.</p> <p>LOUVER VENT, REFER TO MECHANICAL DRAWINGS.</p> | <p>A. REFER TO FINISH, DOOR &amp; WINDOW SCHEDULE, SHEET A-600.</p> <p>B. REFER TO REFLECTED CEILING PLAN FOR CEILING HEIGHTS, SHEET A-110.</p> <p>C. REFER TO INDEX SHEET FOR WALL TYPES, SHEET A-002.</p> <p>D. FIELD VERIFY ALL DIMENSIONS PRIOR TO CONSTRUCTION, SHEET A-101.</p> <p>E. FIELD VERIFY ALL EQUIPMENT LOCATIONS FOR ELECTRICAL OUTLET LOCATIONS, REFER TO ELECTRICAL PLAN.</p> <p>F. CONTRACTOR SHALL HAVE THIS BUILDING, PRIOR TO CONSTRUCTION, PRE-ENGINEERED BY BUILDING SUPPLIER.</p> |
|---|--|---|--|--|

CONSULTANT:

**IOWA DEPARTMENT OF  
NATURAL RESOURCES**

ENGINEERING SERVICES - WALLACE BUILDING  
502 E. 9TH ST., DES MOINES, IA 50319-0034  
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## EXTERIOR ELEVATIONS

NEW OFFICE &amp; STORAGE BUILDING FOR:

# GREEN VALLEY STATE PARK





UNION COUNTY, IOWA

1480 130TH STREET

NO.	BY DATE	REVISION
DRAWN BY:		PROJECT NUMBER: 15-04-88-01
CHK'D BY:		DATE: 07.29.2015
SHEET No:		

# A-120




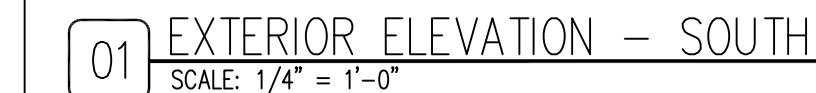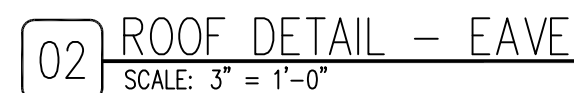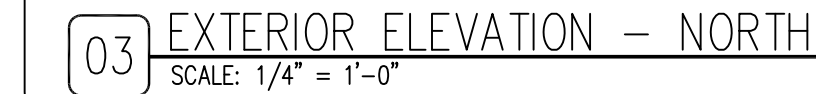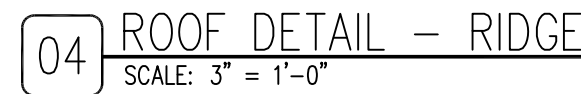


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1480 130TH STREET




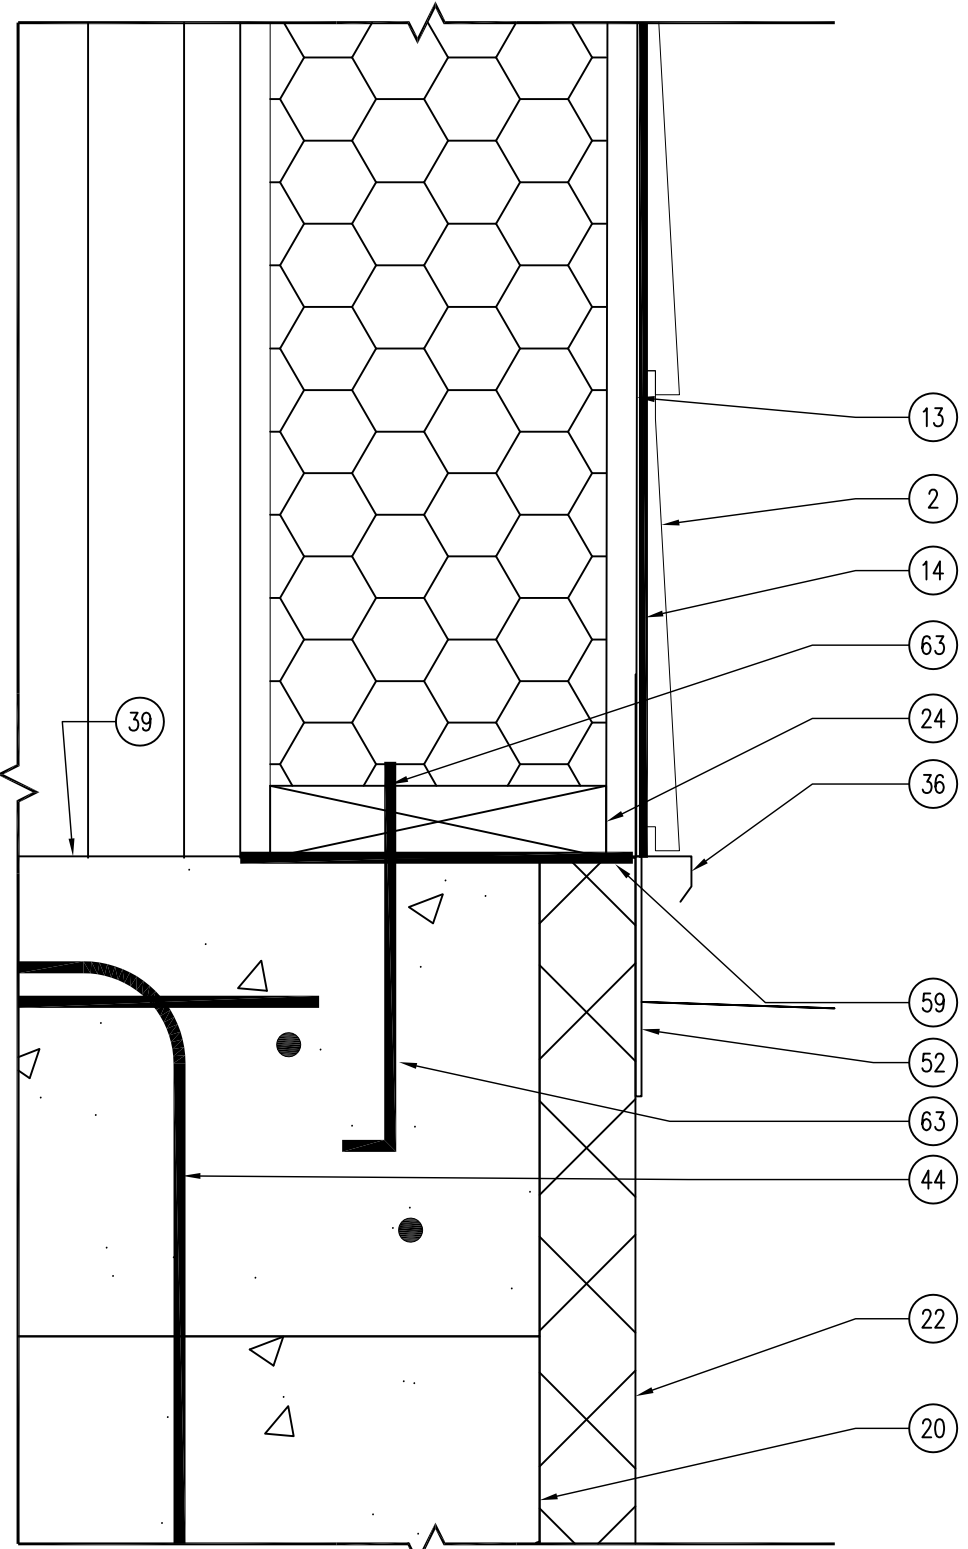


06 DETAIL – WALL SILL PLATE  
SCALE: 3" = 1'-0"

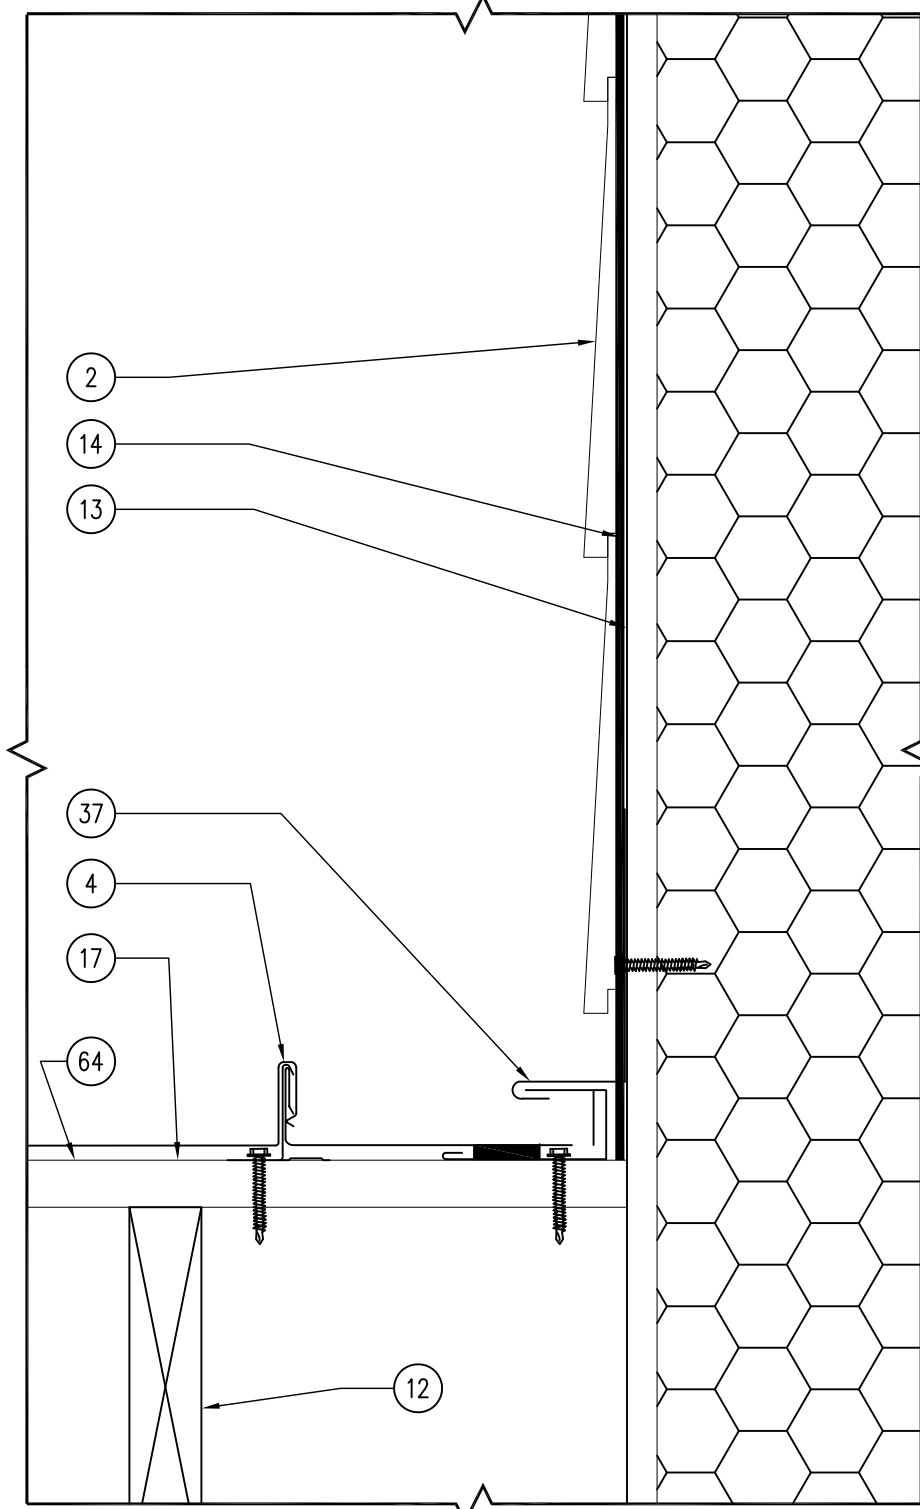


05 DETAIL – ROOF HEAD WALL  
SCALE: 3" = 1'-0"

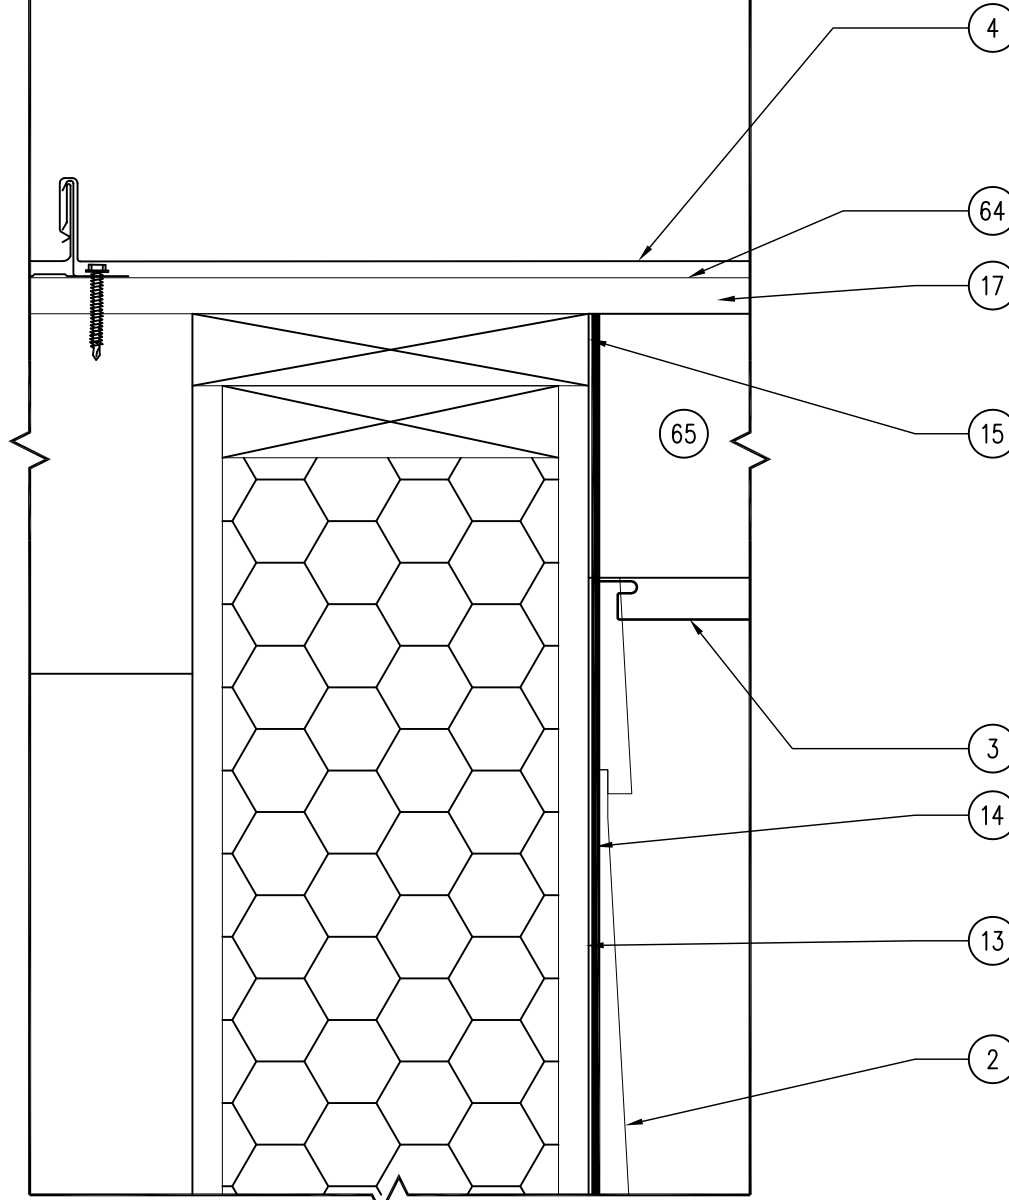


04 DETAIL – WALL TOP PLATE  
SCALE: 3" = 1'-0"

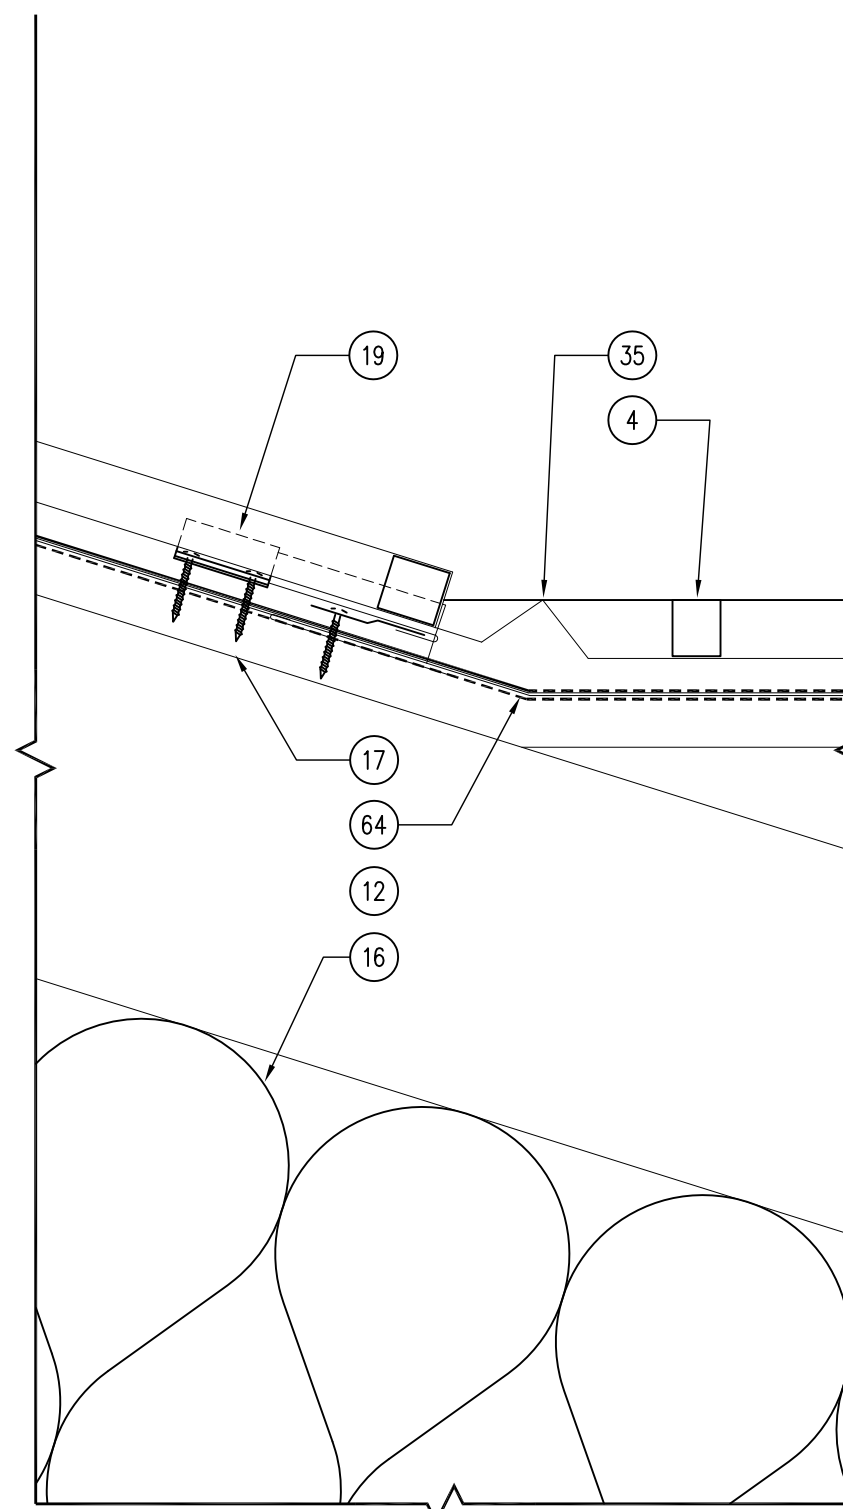

03 DETAIL – ROOF VALLEY FLASHING  
SCALE: 3" = 1'-0"

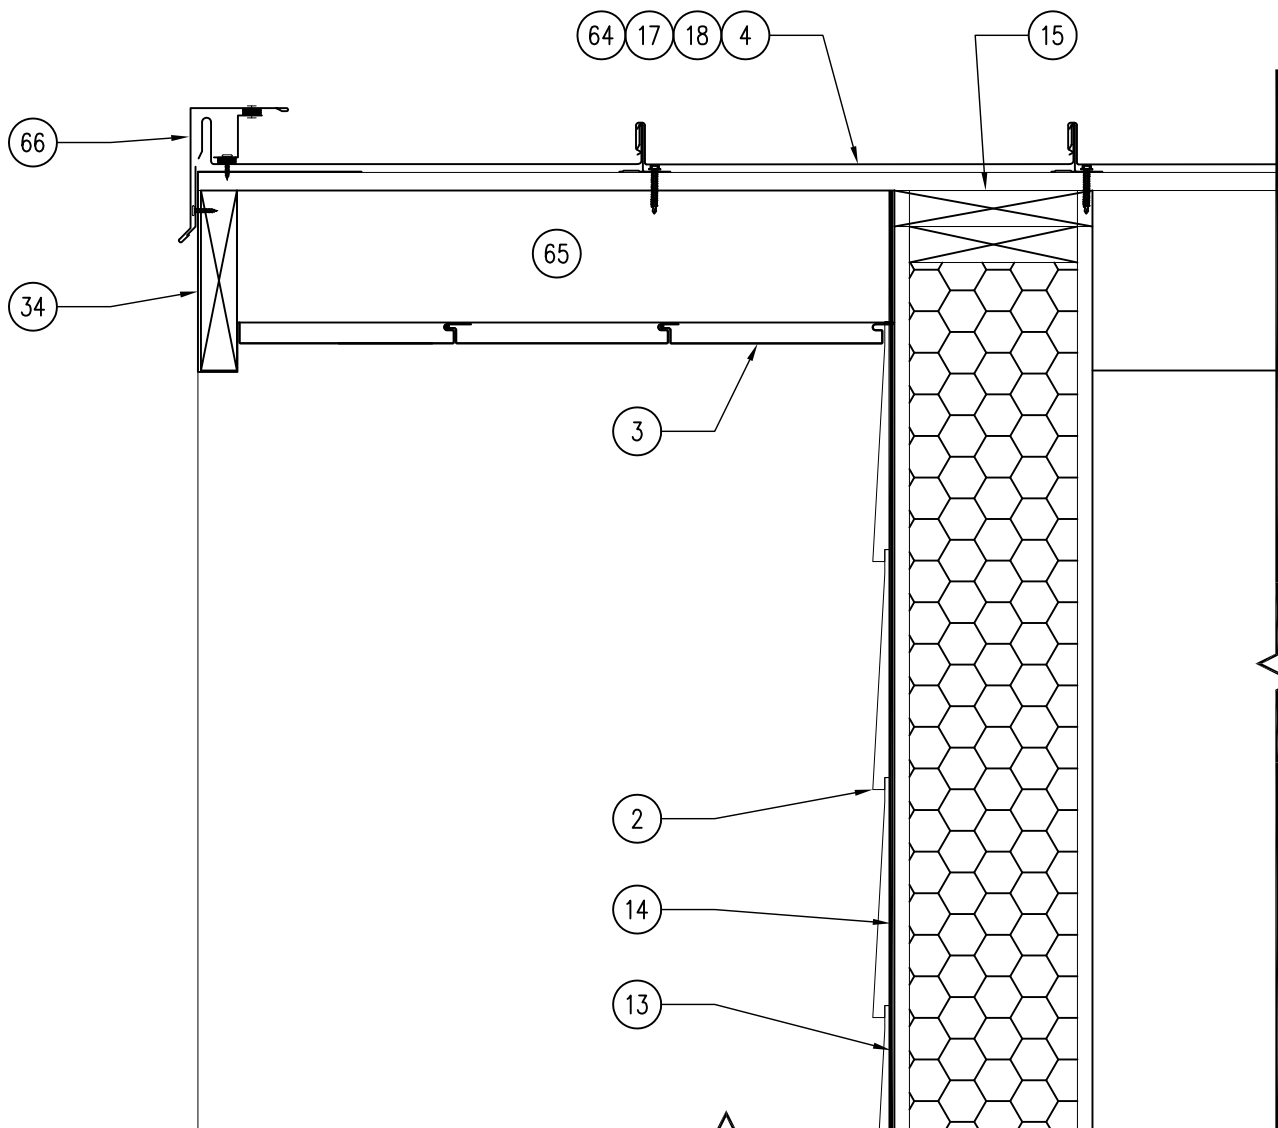

02 DETAIL – ROOF GABLE EDGE  
SCALE: 1 1/2" = 1'-0"

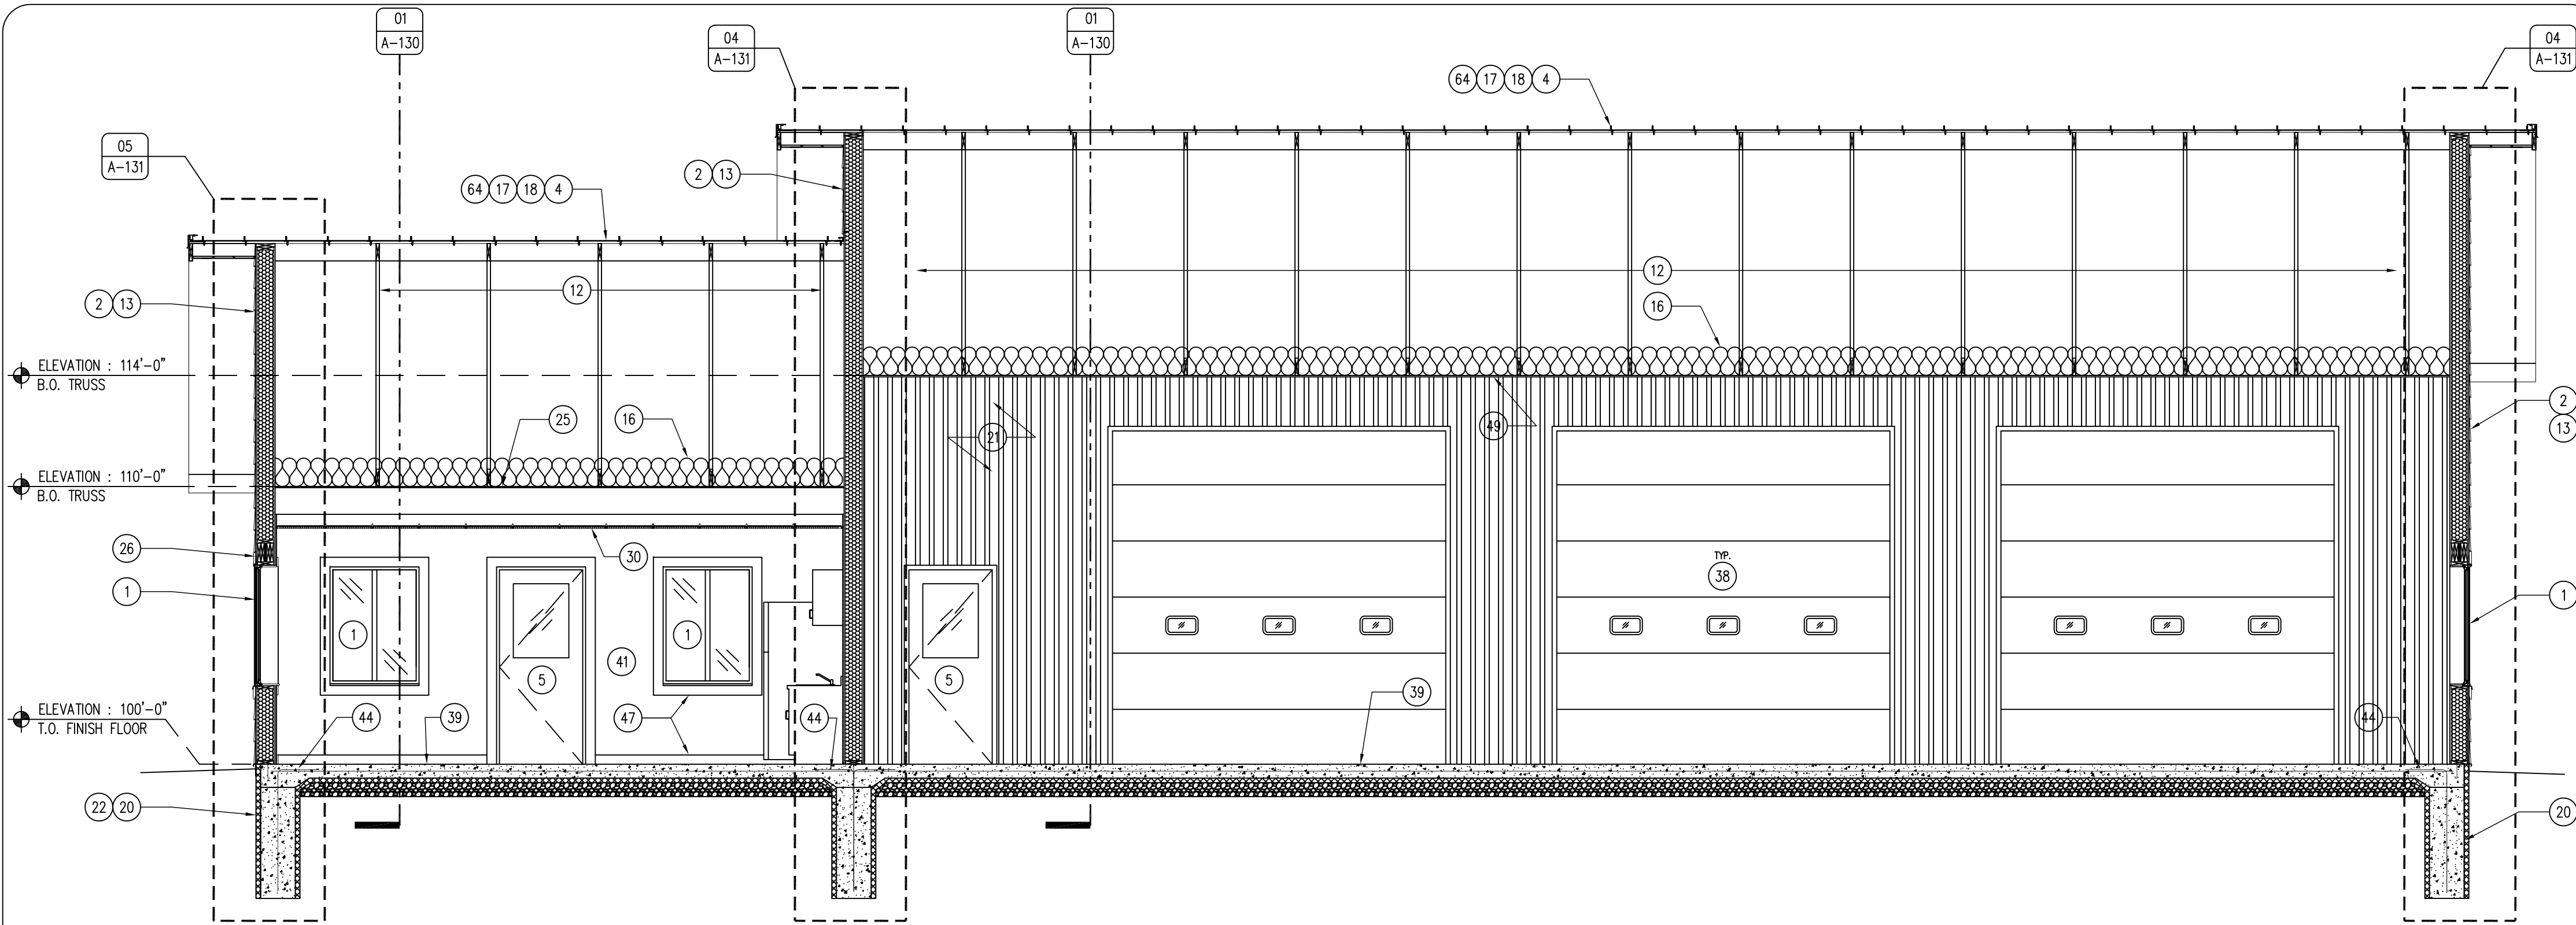

01 BUILDING SECTION  
SCALE: 1/4" = 1'-0"

#### KEYNOTES

- WINDOW AS SCHEDULED, REFER TO SHEET A-600.
- 8 1/2" JAMES HARDIE PLANK LAP SIDING, SELECT CEDARMILL, COLOR TO BE TIMBER BARK.
- METAL VENTED FLUSH-SOFFIT AND FASCIA PANEL. COLOR TO MATCH ROOF.
- PAC-CLAD SNAP-CLAD METAL ROOF. COLOR TO BE DARK BRONZE.
- DOOR AS SCHEDULED, REFER TO SHEET A-600.
- SEAMLESS METAL GUTTER AND DOWNSPOUT SYSTEM WITH LEAF GUARD TO MATCH ROOF.
- TRAFFIC BOLLARD WITH PLASTIC COVER SLEEVE, REFER TO 02/A-202.
- SNOW AND ICE GUARD BAR, PLACE OVER ENTIRE EAVE OF ROOF, BOTH SIDES.
- 2X BLOCKING AS REQUIRED.
- INSULATION Baffle.
- TRUSS HANGER CLIP (SPECIFIED BY BUILDING MANUFACTURER).
- TRUSS (SPECIFIED BY BUILDING MANUFACTURER), FOR DEMONSTRATION PURPOSES ONLY.
- STRUCTURAL INSULATED PANEL (SIP) WALL, BY BUILDING MANUFACTURER.
- VAPOR BARRIER, PER MANUFACTURER'S RECOMMENDATIONS.
- TOP PLATE WITH SEALANT ON ALL POINTS, PER BUILDING MANUFACTURER'S RECOMMENDATIONS.
- R-42 CERTAINTED FIBER-GLASS BATT ROOF INSULATION.
- 3/4" PLYWOOD ROOF DECK SHEATHING WITH WATER AND ICE SHIELD OVER ENTIRE ROOF.
- PAC-CLAD RIDGE VENT AND CAP, MATCH COLOR OF ROOF.
- ROOF CLIPS, PER MANUFACTURER'S RECOMMENDATIONS.
- CONTINUOUS TRENCH FOOTING FOUNDATION, REFER TO DETAIL 02/A-130.
- 29 GAUGE STEEL LINER PANEL THROUGHOUT ENTIRE HEATED BAY AREA – WHITE.
- 2" SUB-SLAB RIGID INSULATION UNDER ENTIRE SLAB AND AROUND PERIMETER OF FOUNDATION. TAPE AND SEAL ALL JOINTS.
- 1/2" EXPANSION JOINT WITH SEALANT.
- SIP SILL PLATE, PER MANUFACTURER'S RECOMMENDATIONS.
- 3/8" TYPE X GYPSUM BOARD DECK. INSTALL DIRECTLY TO TRUSSES THROUGHOUT OFFICE AREA.
- 5.5" JAMES HARDIE 4/4 RUSTIC TRIM BOARDS, PRIMED AND PAINTED DARK BRONZE AROUND WINDOWS AND DOORS, COLOR TO MATCH SIDING ON BUILDING CORNERS.
- 6" SOUND BATT INSULATION.
- 4" SOUND BATT INSULATION.
- ADA ACCESSIBLE DOOR THRESHOLD.
- 24 X 24 ARMSTRONG ULTIMA REGULAR ACOUSTIC CEILING TILES, REFER TO SHEET A-600.
- PARTITION WALL AS SCHEDULED, REFER TO SHEET A-002.
- TRENCH DRAIN, REFER TO PLUMBING DRAWINGS.
- 6" R-19 BATT INSULATION.
- 2X FASCIA, WRAP IN BREAK METAL TO MATCH ROOF.
- METAL VALLEY FLASHING BY ROOFING MANUFACTURER.
- METAL SILL FLASHING BY BUILDING MANUFACTURER.
- METAL HEAD-WALL FLASHING BY ROOFING MANUFACTURER.
- OVERHEAD GARAGE DOOR, REFER TO SHEET A-600.

- 6" CONCRETE SLAB WITH CONTINUOUS #4 REBAR 24" O.C. BOTH DIRECTIONS, OVER 2" SUB-SLAB RIGID INSULATION, TAPED AND SEALED, WITH 4" SUBBASE OVER POLYETHYLENE VAPOR BARRIER.
- #5 DOWEL, EMBED INTO SLAB 24" MINIMUM.
- WALL FINISH AS SCHEDULED, REFER TO SHEET A-600.
- METAL FLASHING, MATCH ROOF COLOR.
- BACKER ROD AND SEALANT.
- #5 DOWEL-ROD "J" HOOK, EMBED 36" INTO FOOTING, 18" INTO SLAB.
- 6X6 ROUGH-SAWN DOUGLAS FIR COLUMN, STAIN WITH TWO COATS TWP 103.
- HEAVY TIMBER, ROUGH-SAWN DOUGLAS FIR TRUSS, STAIN TWO COATS TWP 103 WITH OVERSIZED METAL BRACKETS AS SHOWN, POWDER COAT BLACK.
- 3/4" X 4" HARD MAPLE TRIM, REFER TO SHEET A-600.
- 3X DOUGLAS FIR T&G DECKING, TWO COATS OF CLEAR POLYURETHANE.
- CEILING AS SCHEDULED, REFER TO SHEET A-110.
- UTILITY SINK, REFER TO PLUMBING DRAWINGS.
- RUBBER BASE, REFER TO SHEET A-600.
- CELLULAR PVC PROTECTION BOARD.
- STONE WATER-TABLE, STONE TO BE ROUND-SIDE OUT, SPLIT-FACE, GRANITE BOULDERS – THIN VENEER, BY EDEN STONE. MORTAR TO BE ASTM C270, COLOR TBD.
- 4" HONED INDIANA Limestone WATER-TABLE DRIP EDGE CAP-STONE, BUFF COLORED.
- STONE COLUMN BASE, STONE TO MATCH WALL STONE.

- 4" HONED INDIANA Limestone COLUMN CAP, BUFF COLORED, WITH DRIP EDGE.
- CAST IN PLACE CONCRETE COLUMN FOUNDATION WITH #4 REBAR 12" O.C. ALL DIRECTIONS.
- 2X6 CEDAR FASCIA TRIM EDGE, STAIN TWO COATS TWP 103.
- SILL GASKET.
- 3/8" OVERSIZED MILD-STEEL TRUSS BRACKET, POWDER COAT BLACK. ALL HARDWARE TO BE 3/4" GALVANIZED WITH LOCK WASHERS.
- STEEL COLUMN BASE PLATE, 3/8" MILD-STEEL POWDER COATED BLACK. ANCHOR BOLTS TO BE UNDER COLUMNS, PILOT HOLE CAP AND BASE PLATE, THEN EPOXY SET ANCHOR BOLTS INTO CONCRETE BASE, LEVEL. EMBED MINIMUM 18".
- CONCRETE WALK WITH SUBBASE, REFER TO CIVIL DRAWINGS.
- SILL ANCHOR, PER BUILDING MANUFACTURER'S RECOMMENDATIONS.
- WATER AND ICE SHIELD OVER ENTIRE ROOF DECKING PER MANUFACTURER'S RECOMMENDATIONS.
- 2X OUTRIGGER EAVE, PER BUILDING MANUFACTURER.
- METAL RAKE EDGE FLASHING BY ROOFING MANUFACTURER.
- 6" CONCRETE APRON SLAB WITH CONTINUOUS #4 REBAR 24" O.C. BOTH DIRECTIONS WITH 4" SUBBASE.

#### GENERAL NOTES

- REFER TO FINISH, DOOR & WINDOW SCHEDULE, SHEET A-600.
- REFER TO REFLECTED CEILING PLAN FOR CEILING HEIGHTS, SHEET A-110.
- REFER TO INDEX SHEET FOR WALL TYPES, SHEET A-002.
- FIELD VERIFY ALL DIMENSIONS PRIOR TO CONSTRUCTION, SHEET A-101.
- FIELD VERIFY ALL EQUIPMENT LOCATIONS FOR ELECTRICAL OUTLET LOCATIONS, REFER TO ELECTRICAL PLAN.
- CONTRACTOR SHALL HAVE THIS BUILDING, PRIOR TO CONSTRUCTION, PRE-ENGINEERED BY BUILDING SUPPLIER.

#### EXTERIOR ELEVATIONS AND ROOF DETAILS

NEW OFFICE & STORAGE BUILDING FOR:

GREEN VALLEY STATE PARK

1480 130TH STREET

UNION COUNTY, IOWA

CONSULTANT:

IOWA DEPARTMENT OF  
NATURAL RESOURCES

ENGINEERING SERVICES - WALLACE BUILDING  
502 E. 9TH ST., DES MOINES, IA 50319-0034  
P: 515.725.8200  
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NO. BY REVISION


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15-04-88-01

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07.29.2015


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A-130




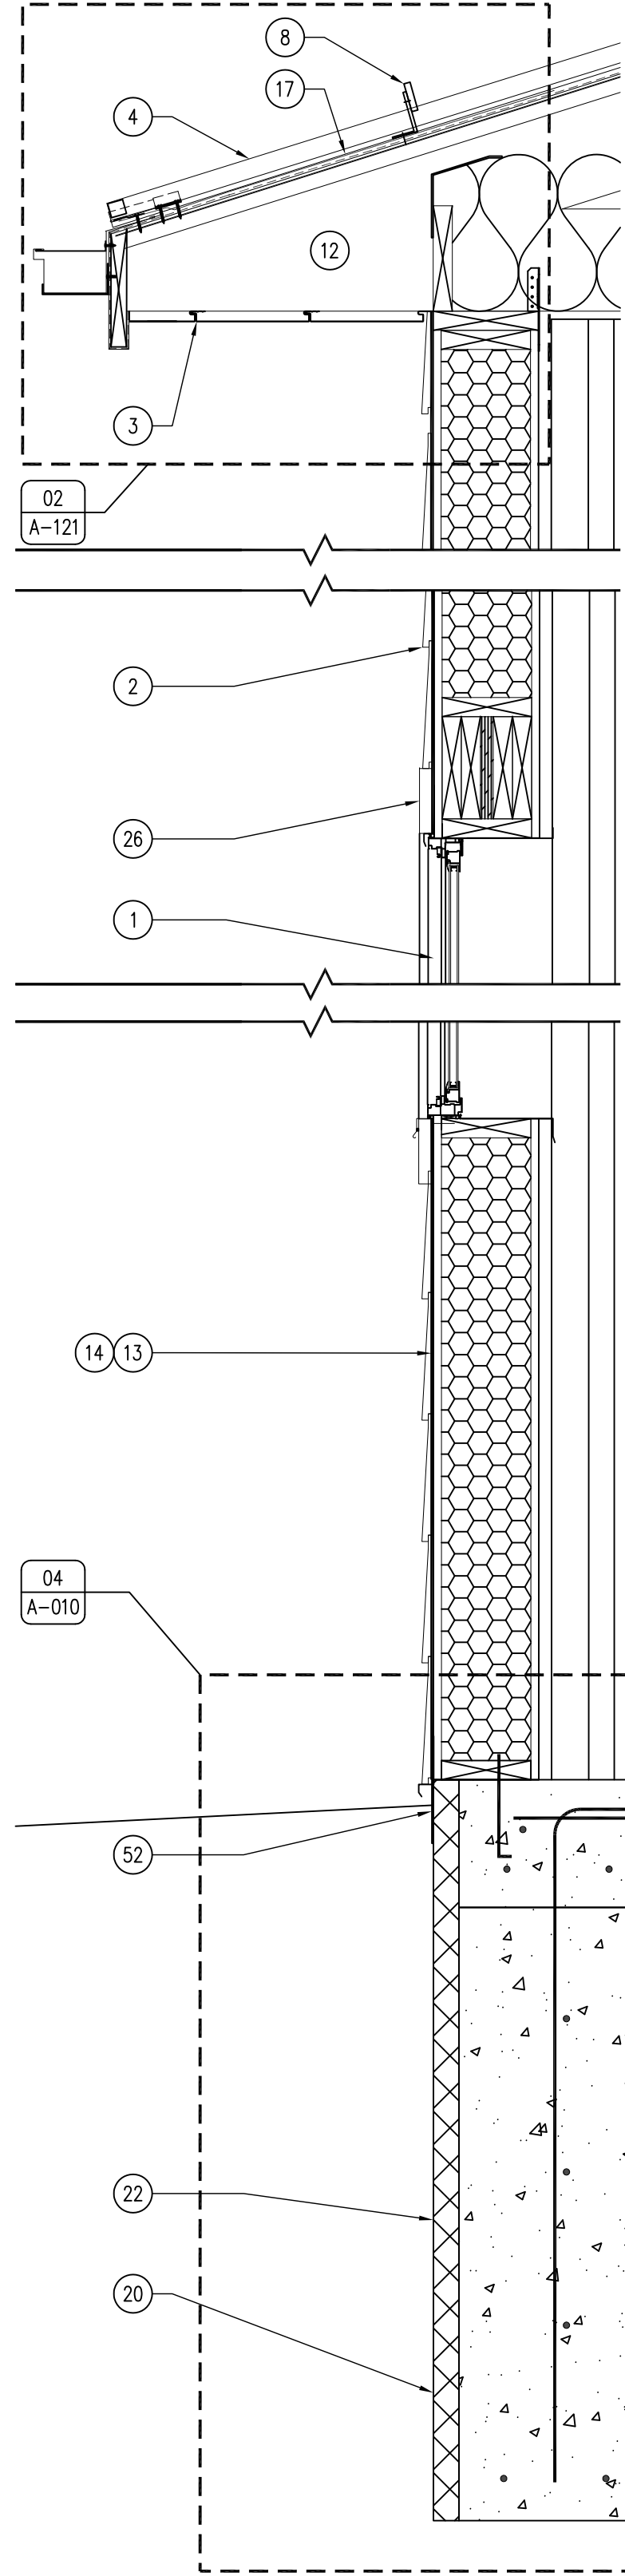


05 WALL SECTION  
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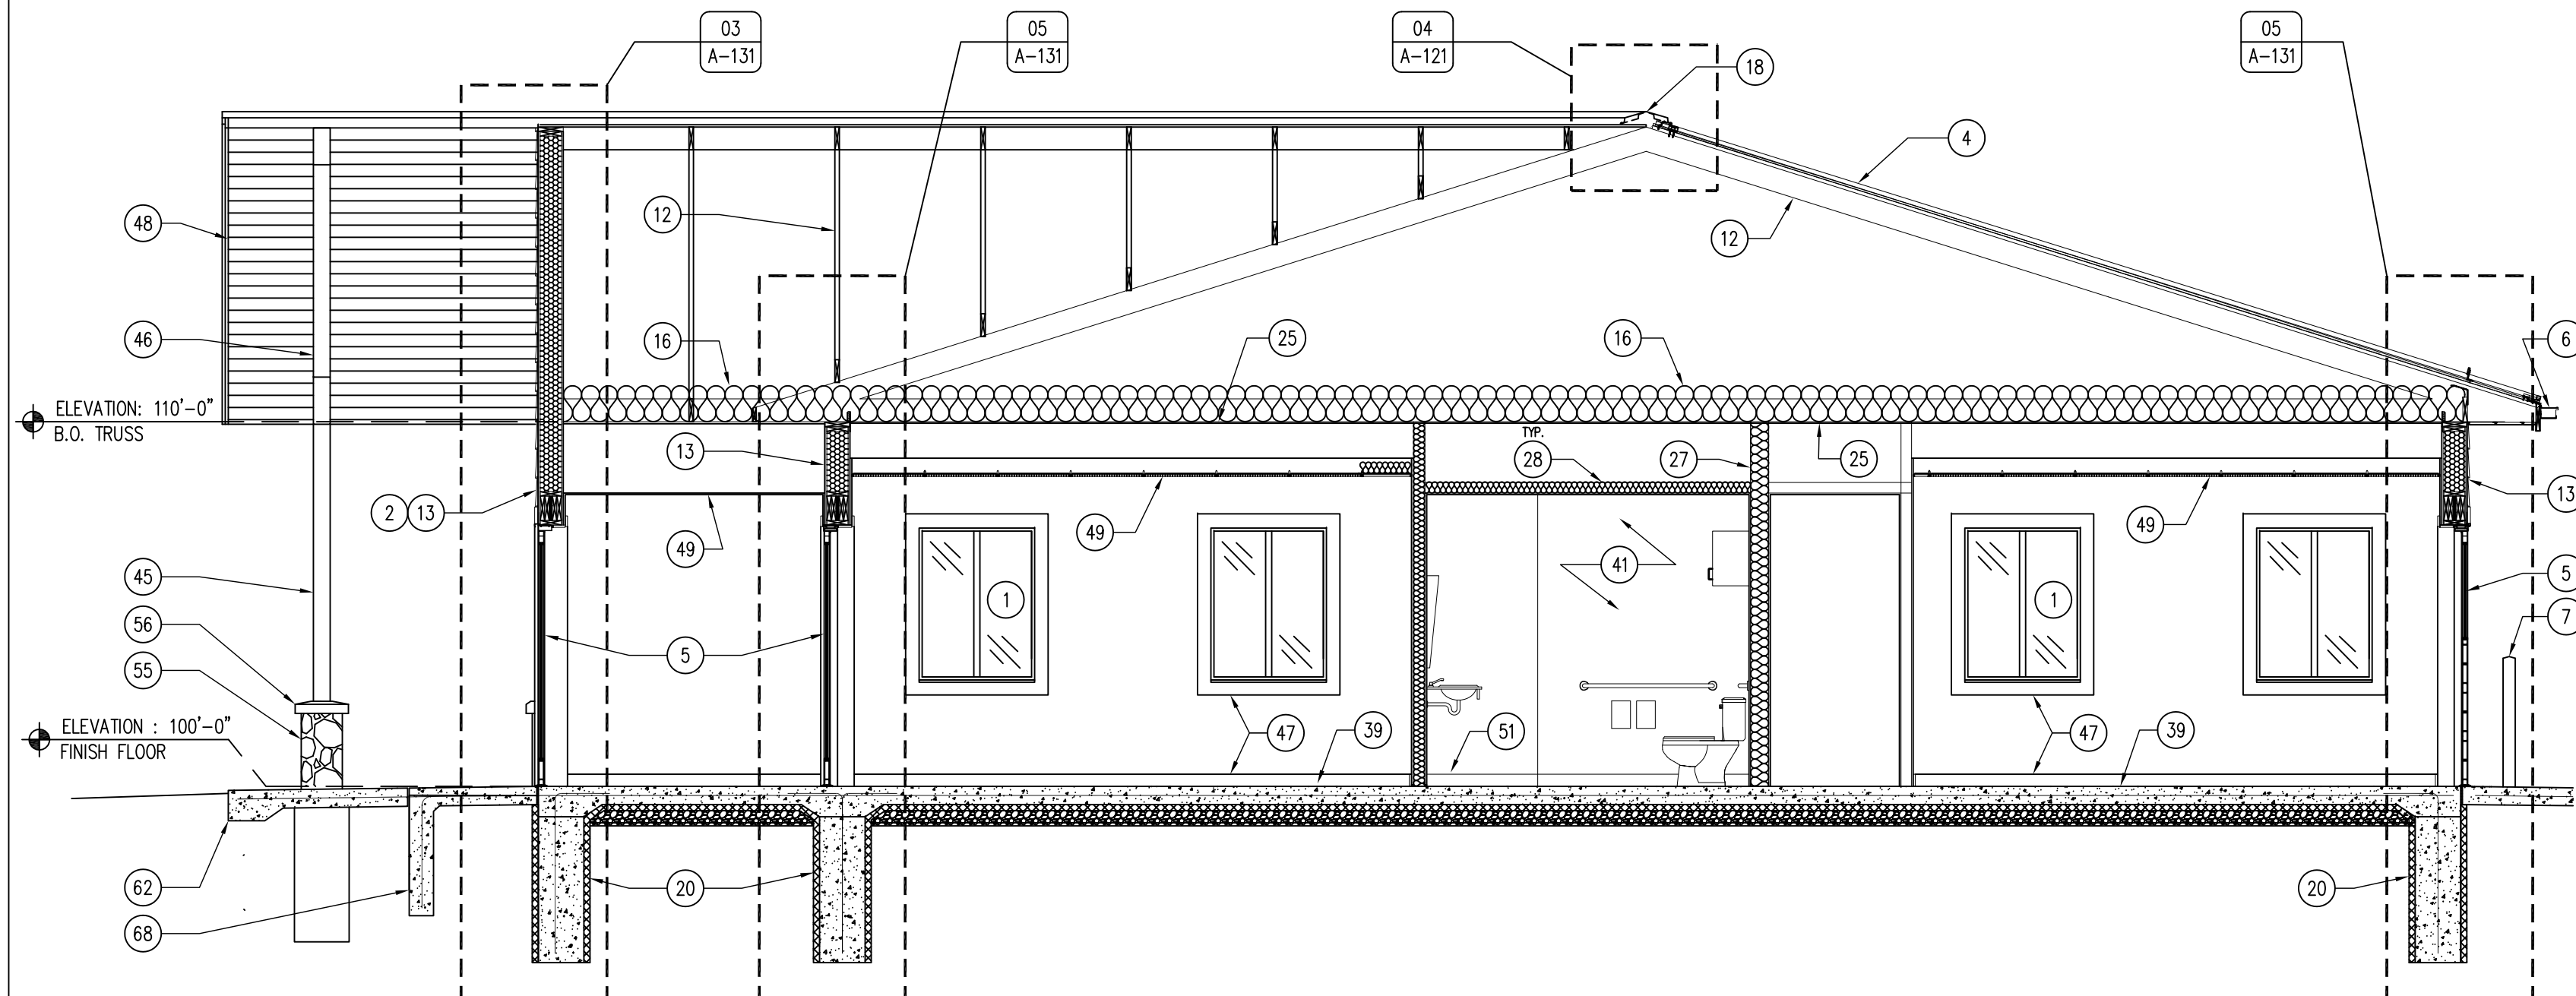
04 WALL SECTION  
SCALE: 1" = 1'-0"

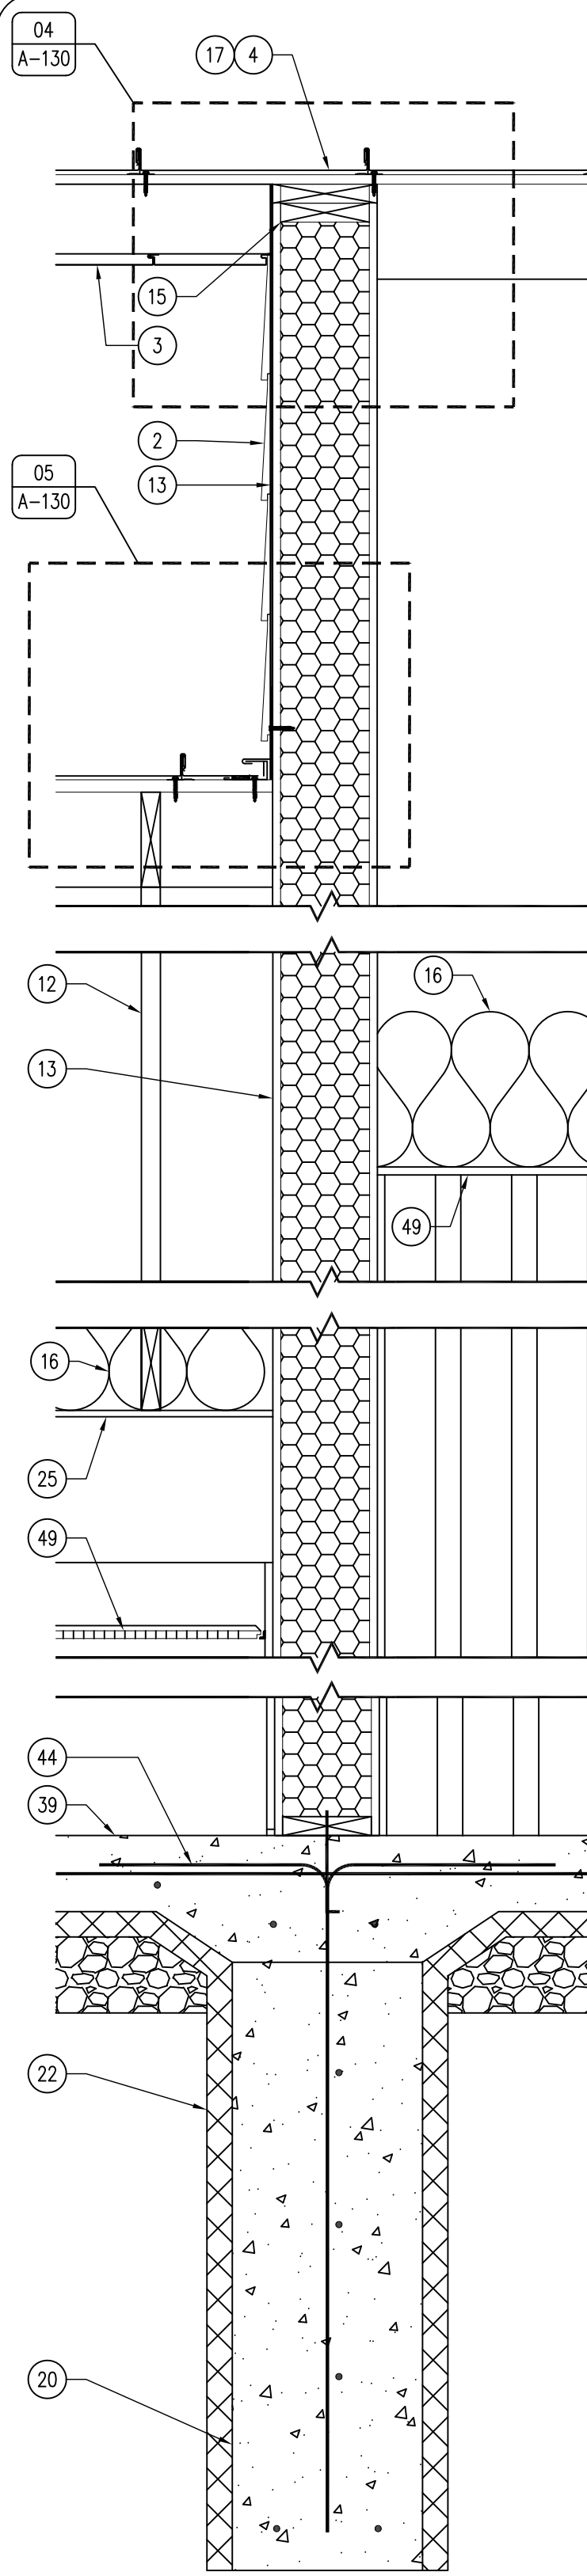

03 WALL SECTION  
SCALE: 1" = 1'-0"

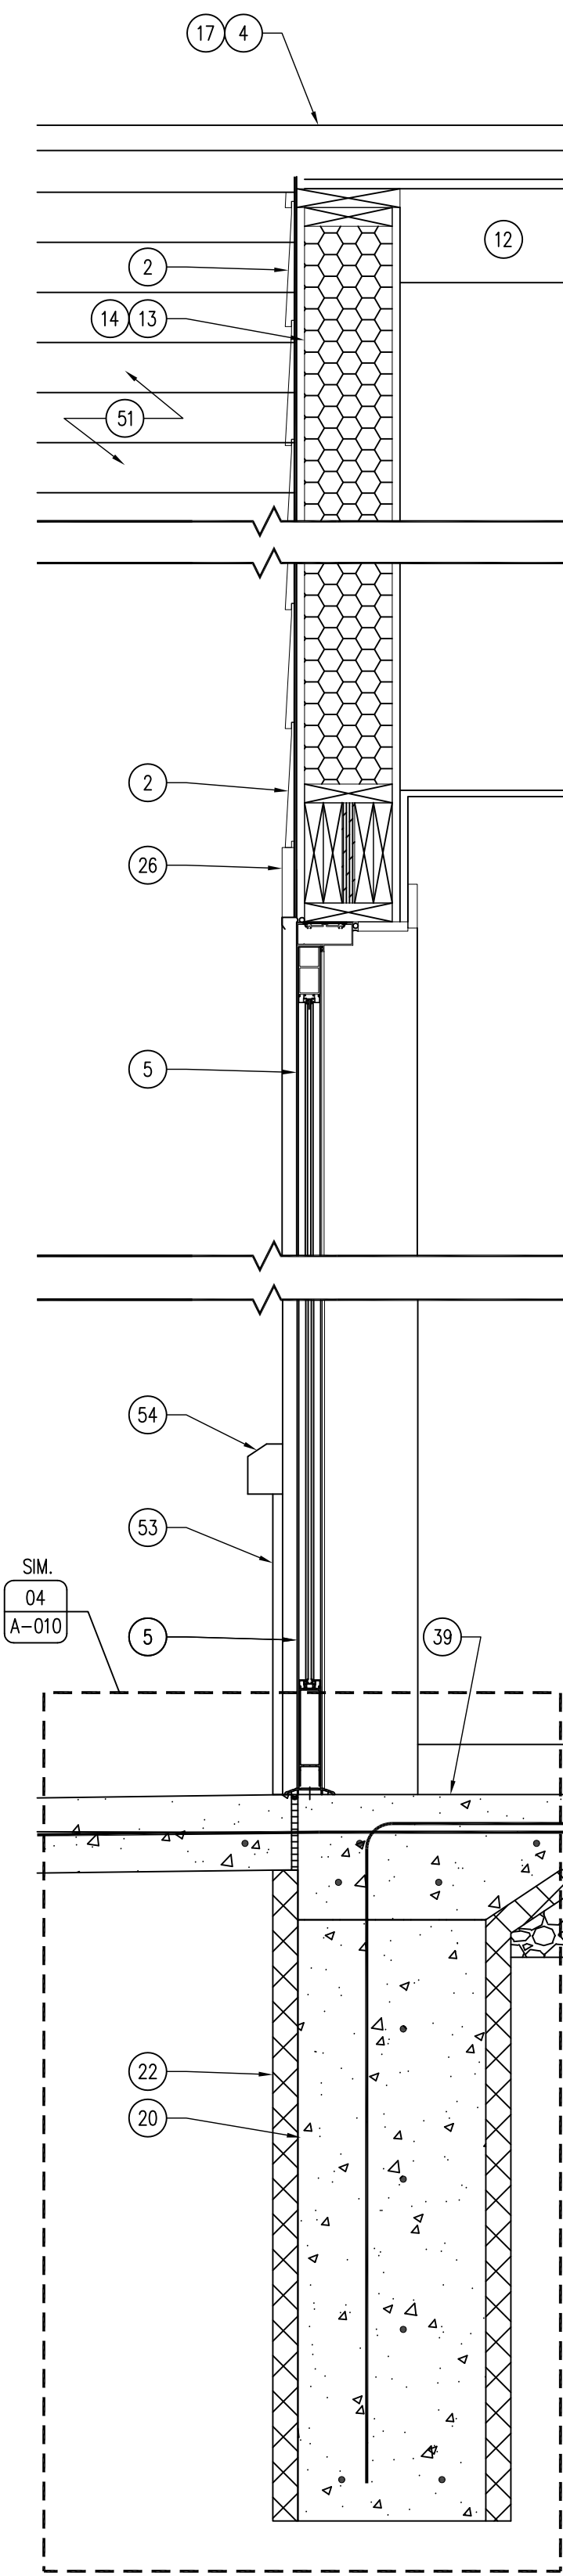

02 EXTERIOR ELEVATION  
SCALE: 1/4" = 1'-0"

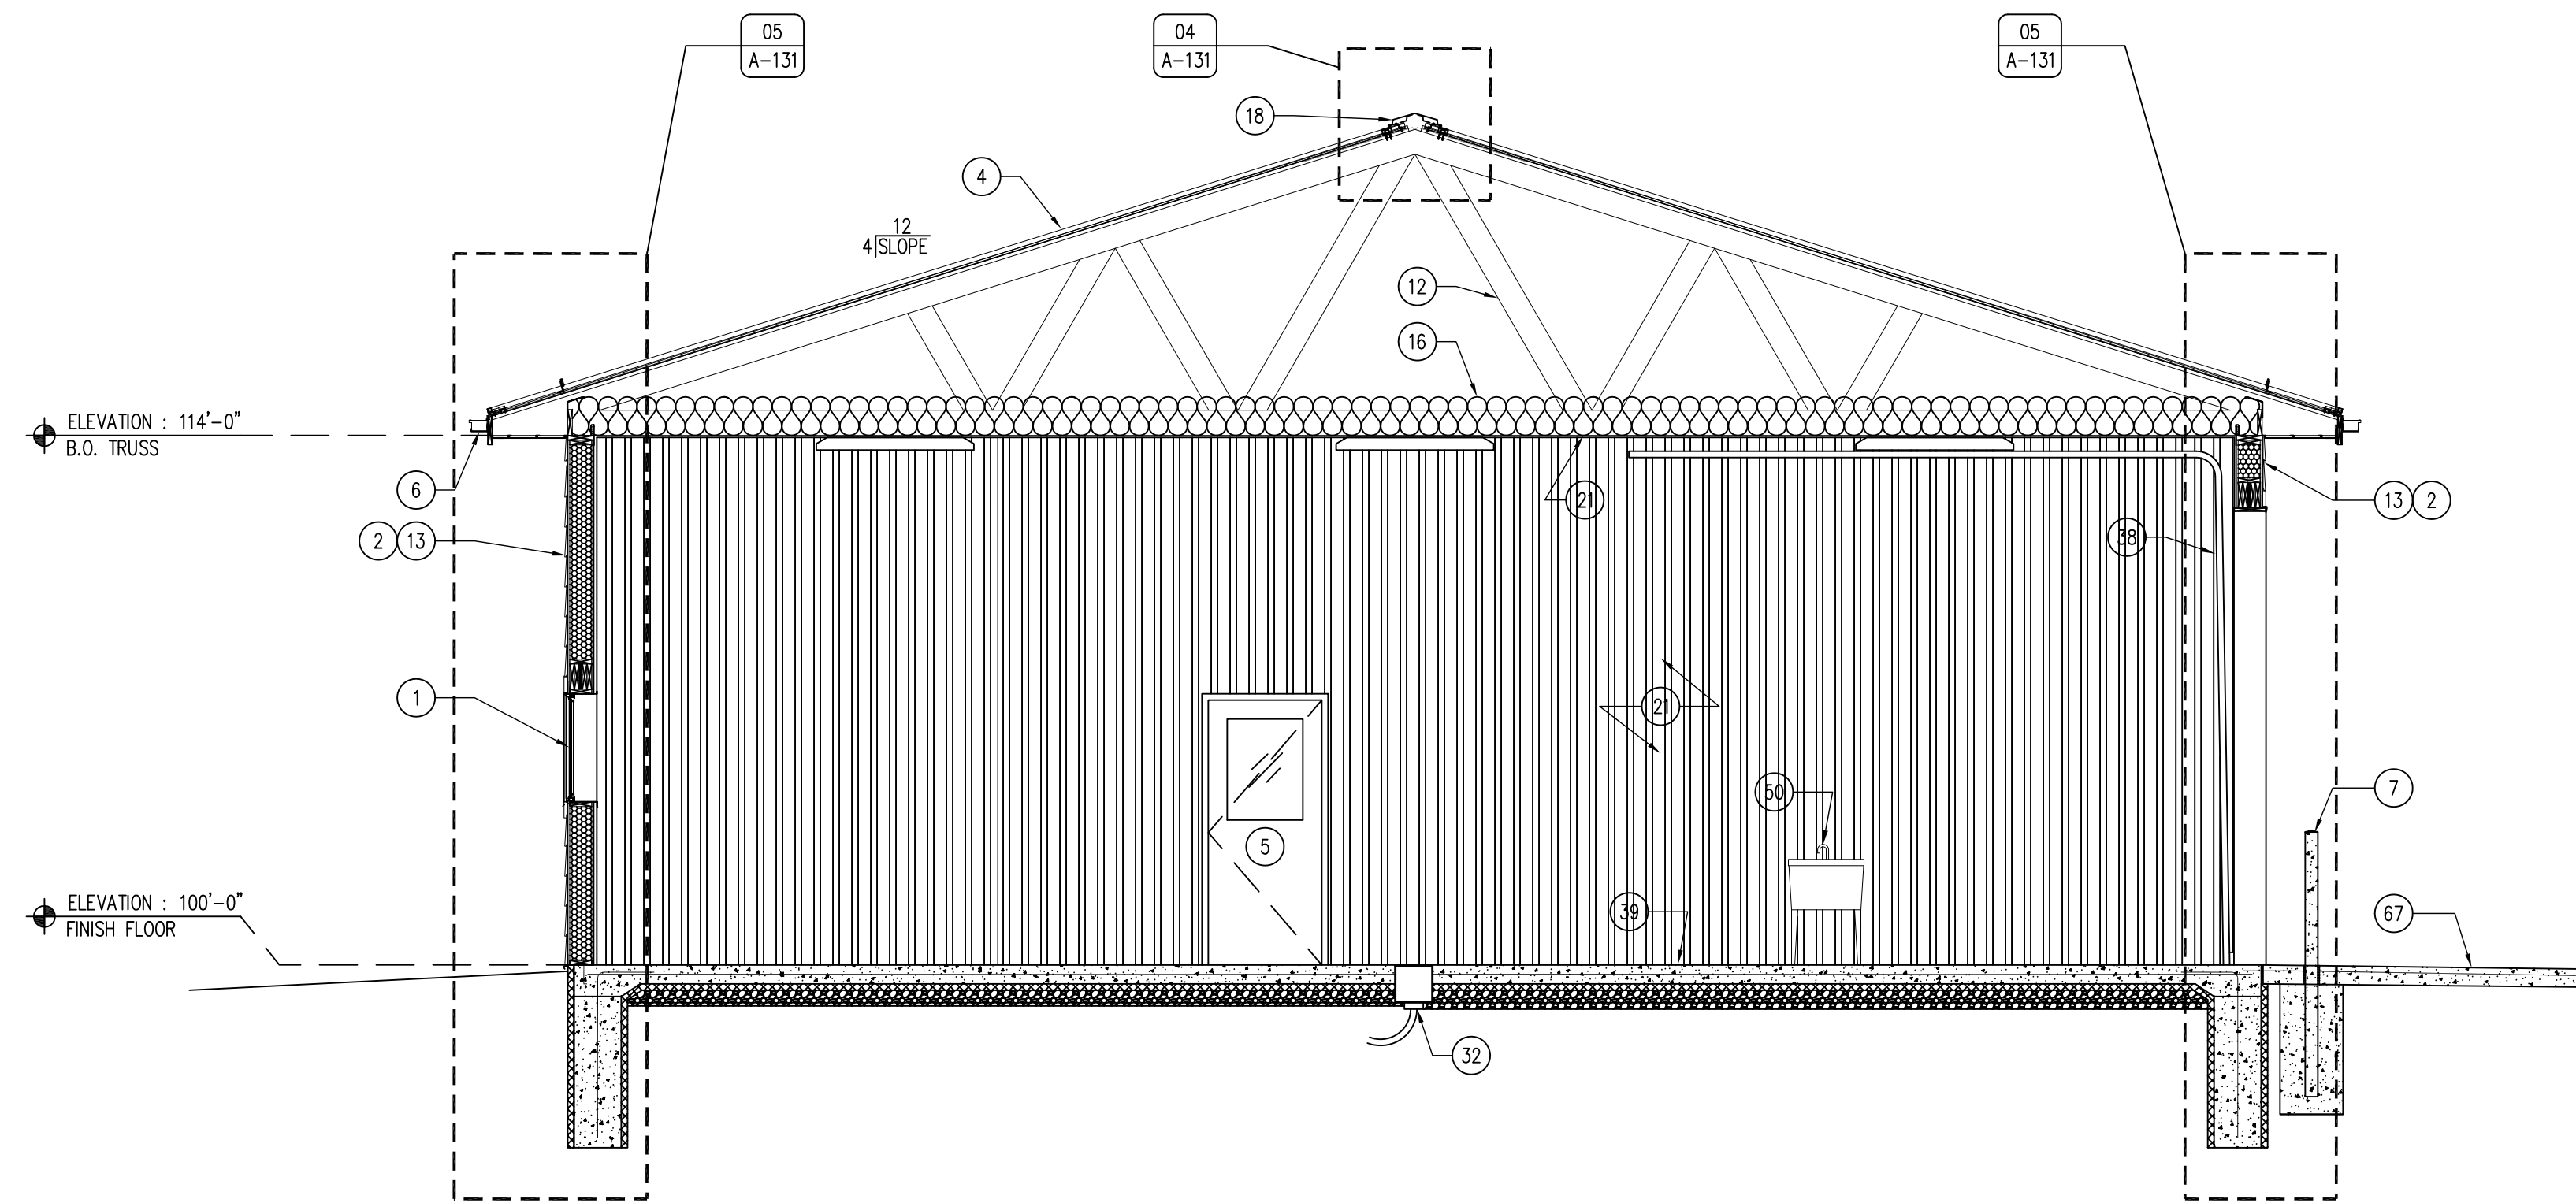

01 EXTERIOR ELEVATION  
SCALE: 1/4" = 1'-0"

#### KEYNOTES

- WINDOW AS SCHEDULED, REFER TO SHEET A-600.
- 8 3/4" JAMES HARDIE PLANK LAP SIDING, SELECT CEDARMILL, COLOR TO BE TIMBER BARK.
- METAL VENTED FLUSH-SOFFIT AND FASCIA PANEL, COLOR TO MATCH ROOF.
- PAC-CLAD SNAP-CLAD METAL ROOF, COLOR TO BE DARK BRONZE.
- DOOR AS SCHEDULED, REFER TO SHEET A-600.
- SEAMLESS METAL GUTTER AND DOWNSPOUT SYSTEM WITH LEAF GUARD TO MATCH ROOF.
- TRAFFIC BOLLARD WITH PLASTIC COVER SLEEVE, REFER TO 02/A-202.
- SNOW AND ICE GUARD BAR, PLACE OVER ENTIRE EAVE OF ROOF, BOTH SIDES.
- 2X BLOCKING AS REQUIRED.
- INSULATION Baffle.
- TRUSS HANGER CLIP (SPECIFIED BY BUILDING MANUFACTURER).
- TRUSS (SPECIFIED BY BUILDING MANUFACTURER), FOR DEMONSTRATION PURPOSES ONLY.
- STRUCTURAL INSULATED PANEL (SIP) WALL, BY BUILDING MANUFACTURER.
- VAPOR BARRIER, PER MANUFACTURER'S RECOMMENDATIONS.
- TOP PLATE WITH SEALANT ON ALL JOINTS, PER BUILDING MANUFACTURER'S RECOMMENDATIONS.
- R-42 CERTAINTED FIBER-GLASS BATT ROOF INSULATION.
- 3/4" PLYWOOD ROOF DECK SHEATHING WITH WATER AND ICE SHIELD OVER ENTIRE ROOF.
- PAC-CLAD RIDGE VENT AND CAP, MATCH COLOR OF ROOF.
- ROOF CLIPS, PER MANUFACTURER'S RECOMMENDATIONS.
- CONTINUOUS TRENCH FOOTING FOUNDATION, REFER TO DETAIL 02/A-130.
- 29 GAUGE STEEL LINER PANEL THROUGHOUT ENTIRE HEATED BAY AREA - WHITE.
- 2" SUB-SLAB RIGID INSULATION UNDER ENTIRE SLAB AND AROUND PERIMETER OF FOUNDATION.
- TAPE AND SEAL ALL JOINTS.
- 1/2" EXPANSION JOINT WITH SEALANT.
- TREATED SIP SILL PLATE, PER MANUFACTURER'S RECOMMENDATIONS.
- 3/8" TYPE X GYPSUM BOARD DECK. INSTALL DIRECTLY TO TRUSSES THROUGHOUT OFFICE AREA.
- 5.5" JAMES HARDIE 4/4 RUSTIC TRIM BOARDS, PRIMED AND PAINTED DARK BRONZE AROUND WINDOWS AND DOORS, COLOR TO MATCH SIDING ON BUILDING CORNERS.
- 6" SOUND BATT INSULATION.
- 4" SOUND BATT INSULATION.
- ADA ACCESSIBLE DOOR THRESHOLD.
- 24 X 24 ARMSTRONG ULTIMA REGULAR ACOUSTIC CEILING TILES, REFER TO SHEET A-600.
- PARTITION WALL AS SCHEDULED, REFER TO SHEET A-002.
- TRENCH DRAIN, REFER TO PLUMBING DRAWINGS.
- 6" R-19 BATT INSULATION.
- 2X FASCIA, WRAP IN BREAK METAL TO MATCH ROOF.
- METAL VALLEY FLASHING BY ROOFING MANUFACTURER.
- METAL SILL FLASHING BY BUILDING MANUFACTURER.
- METAL HEAD-WALL FLASHING BY ROOFING MANUFACTURER.
- OVERHEAD GARAGE DOOR, REFER TO SHEET A-600.

- 6" CONCRETE SLAB WITH CONTINUOUS #4 REBAR 24" O.C. BOTH DIRECTIONS, OVER 2" SUB-SLAB RIGID INSULATION, TAPED AND SEALED, WITH 4" SUBBASE OVER POLYETHYLENE VAPOR BARRIER.
- #5 DOWEL, EMBED INTO SLAB 24" MINIMUM.
- WALL FINISH AS SCHEDULED, REFER TO SHEET A-600.
- METAL FLASHING, MATCH ROOF COLOR.
- BACKER ROD AND SEALANT.
- #5 DOWEL-ROD "J" HOOK, EMBED 36" INTO FOOTING, 18" INTO SLAB.
- 6X6 ROUGH-SAWN DOUGLAS FIR COLUMN, STAIN WITH TWO COATS TWP 103.
- HEAVY TIMBER, ROUGH-SAWN DOUGLAS FIR TRUSS, STAIN TWO COATS TWP 103 WITH OVERSIZED METAL BRACKETS AS SHOWN, POWDER COAT BLACK.
- 3/4" X 4" HARD MAPLE TRIM, REFER TO SHEET A-600.
- 3X DOUGLAS FIR T&G DECKING, TWO COATS OF CLEAR POLYURETHANE.
- CEILING AS SCHEDULED, REFER TO SHEET A-110.
- UTILITY SINK, REFER TO PLUMBING DRAWINGS.
- RUBBER BASE, REFER TO SHEET A-600.
- CELLULAR PVC PROTECTION BOARD.
- STONE WATER-TABLE, STONE TO BE ROUND-SIDE OUT, SPLIT-FACE, GRANITE BOULDERS - THIN VENEER, BY EDEN STONE. MORTAR TO BE ASTM C270, COLOR T80.
- 4" HONED INDIANA LIMESTONE WATER-TABLE DRIP EDGE CAP-STONE, BUFF COLORED.
- STONE COLUMN BASE, STONE TO MATCH WALL STONE.

- 4" HONED INDIANA LIMESTONE COLUMN CAP, BUFF COLORED, WITH DRIP EDGE.
- CAST IN PLACE CONCRETE COLUMN FOUNDATION WITH #4 REBAR 12" O.C. ALL DIRECTIONS.
- 2X6 CEDAR FASCIA TRIM EDGE, STAIN TWO COATS TWP 103.
- SILL GASKET.
- 3/8" OVERSIZED MILD-STEEL TRUSS BRACKET, POWDER COAT BLACK. ALL HARDWARE TO BE 3/4" GALVANIZED WITH LOCK WASHERS.
- STEEL COLUMN BASE PLATE, 3/8" MILD-STEEL POWDER COATED BLACK. ANCHOR BOLTS TO BE UNDER COLUMNS, PILOT HOLE CAP AND BASE PLATE, THEN EPOXY SET ANCHOR BOLTS INTO CONCRETE BASE, LEVEL. EMBED MINIMUM 18".
- CONCRETE WALK WITH SUBBASE, REFER TO CIVIL DRAWINGS.
- SILL ANCHOR, PER BUILDING MANUFACTURER'S RECOMMENDATIONS.
- WATER AND ICE SHIELD OVER ENTIRE ROOF DECKING PER MANUFACTURER'S RECOMMENDATIONS.
- 2X OUTRIGGER EAVE, PER BUILDING MANUFACTURER.
- METAL RAKE EDGE FLASHING BY ROOFING MANUFACTURER.
- 6" CONCRETE APRON SLAB WITH CONTINUOUS #4 REBAR 24" O.C. BOTH DIRECTIONS WITH 4" SUBBASE.
- STOOP FOOTING, EXTEND 48", #5 DOWELS INTO SLAB 12" O.C., 18" EMBEDMENT MINIMUM.

#### GENERAL NOTES

- REFER TO FINISH, DOOR & WINDOW SCHEDULE, SHEET A-600.
- REFER TO REFLECTED CEILING PLAN FOR CEILING HEIGHTS, SHEET A-110.
- REFER TO INDEX SHEET FOR WALL TYPES, SHEET A-002.
- FIELD VERIFY ALL DIMENSIONS PRIOR TO CONSTRUCTION, SHEET A-101.
- FIELD VERIFY ALL EQUIPMENT LOCATIONS FOR ELECTRICAL OUTLET LOCATIONS, REFER TO ELECTRICAL PLAN.
- CONTRACTOR SHALL HAVE THIS BUILDING, PRIOR TO CONSTRUCTION, PRE-ENGINEERED BY BUILDING SUPPLIER.

#### BUILDING SECTIONS

NEW OFFICE & STORAGE BUILDING FOR:

GREEN VALLEY STATE PARK

1480 130TH STREET

UNION COUNTY, IOWA

CONSULTANT:

IOWA DEPARTMENT OF  
NATURAL RESOURCES

ENGINEERING SERVICES - WALLACE BUILDING  
502 E. 9TH ST., DES MOINES, IA 50319-0034  
P: 515.725.8200  
F: 515.725.8202



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SHEET NO:

A-131



07 NOT USED  
SCALE: 1/4" = 1'-0"

06 NOT USED  
SCALE: 1/4" = 1'-0"

05 NOT USED  
SCALE: 1/4" = 1'-0"

04 RESTROOM ELEVATION  
SCALE: 1/2" = 1'-0"

03 RESTROOM ELEVATION  
SCALE: 1/2" = 1'-0"

02 RESTROOM ELEVATION  
SCALE: 1/2" = 1'-0"

01 ENLARGED FLOOR PLAN  
SCALE: 1 1/2" = 1'-0"

TOILET ACCESSORY SCHEDULE

- ALL MODEL NUMBERS BASED ON BOBRICK "CONTURA SERIES" WASHROOM EQUIPMENT UNLESS OTHERWISE NOTED.
- (1-1) RECESSED PAPER TOWEL DISPENSER/WASTE RECEPTACLE  
B-4369
  - (1-2) Surface-mounted Multi-Roll Toilet Tissue Dispenser  
B-4388
  - (1-3) Angle-Framed Mirror - MOUNT BOTTOM EDGE OF MIRROR 40" AFF  
B-290 3636
  - (1-4) Recessed Soap Dispenser  
B-4063
  - (1-5) Single COAT Hook - CENTER ON DOOR  
B-6717
  - (1-6) Concealed Mounting with Snap Flange Grab Bars  
B-6806 x 36
  - (1-7) Concealed Mounting with Snap Flange Grab Bars  
B-6806 x 42

KEYNOTES

- CEILING AS SCHEDULED, REFER TO REFLECTED CEILING PLAN SHEET A-110.
- DOOR AS SCHEDULED, REFER TO SHEET A-600.
- NOT USED.
- FINISH FLOOR AS SCHEDULED, REFER TO FINISH SCHEDULE SHEET A-600.
- NOT USED.
- 3/4" PLYWOOD CABINET WITH HARDWOOD VENEER (WD-1) ON CENCAELED HINGES, PROVIDE DECORATIVE HARDWARE WIRE PULLS (OIL RUBBED BRONZE).
- ADA COMPLIANT TOILET AS SCHEDULED, REFER TO PLUMBING DRAWINGS.
- ADA COMPLIANT INTEGRAL LAVATORY AND SOLID SURFACE COUNTER (SS-1) AS SHOWN. REFER TO PLUMBING DRAWINGS.
- ADA COMPLIANT SHOWER SURROUND WITH TRANSLUCENT DOOR AS SCHEDULED. REFER TO PLUMBING DRAWINGS.
- RUBBER WALL BASE AS SCHEDULED, REFER TO FINISH SCHEDULE SHEET A-600.
- WALL FINISH AS SCHEDULED, REFER TO FINISH SCHEDULE SHEET A-600.
- FLOOR DRAIN, REFER TO PLUMBING DRAWINGS.

GENERAL NOTES

- REFER TO FINISH, DOOR & WINDOW SCHEDULE, SHEET A-600.
- REFER TO REFLECTED CEILING PLAN FOR CEILING HEIGHTS, SHEET A-110.
- REFER TO INDEX SHEET FOR WALL TYPES, SHEET A-002.
- FIELD VERIFY ALL DIMENSIONS PRIOR TO CONSTRUCTION, SHEET A-101.
- FIELD VERIFY ALL EQUIPMENT LOCATIONS FOR ELECTRICAL OUTLET LOCATIONS, REFER TO ELECTRICAL PLAN.
- CONTRACTOR SHALL HAVE THIS BUILDING, PRIOR TO CONSTRUCTION, PRE-ENGINEERED BY BUILDING SUPPLIER.
- ALL PLYWOOD PRODUCTS TO HAVE NO ADDED UREA-FORMALDEHYDE (NAUF).
- ALL PLYWOOD CABINET AND DRAWER SURFACES TO HAVE VOC FREE CLEAR SATIN FINISH.

ENLARGED PLANS AND ELEVATIONS

NEW OFFICE & STORAGE BUILDING FOR:

GREEN VALLEY STATE PARK

1480 130TH STREET

UNION COUNTY, IOWA

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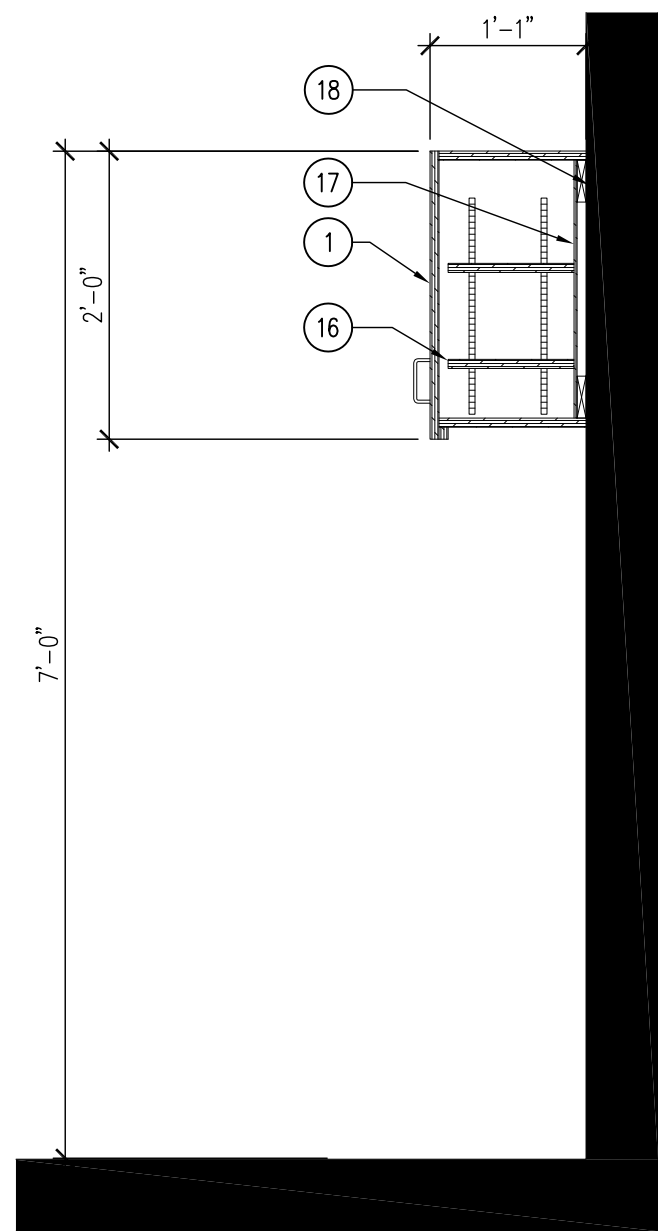
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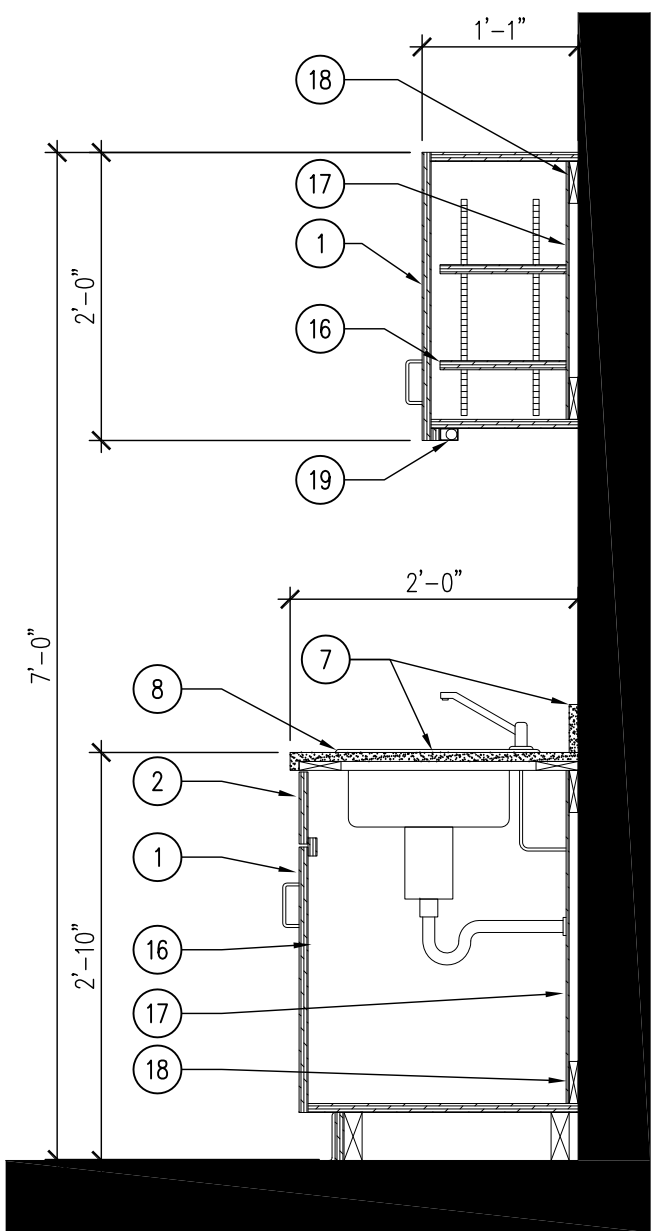
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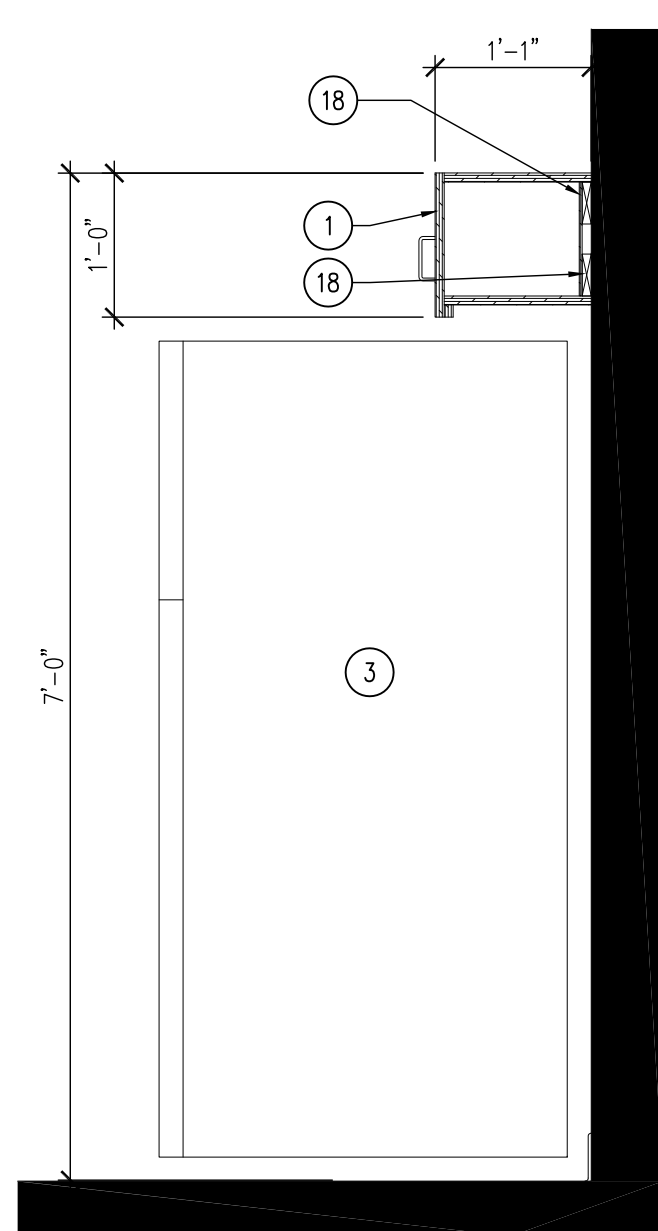





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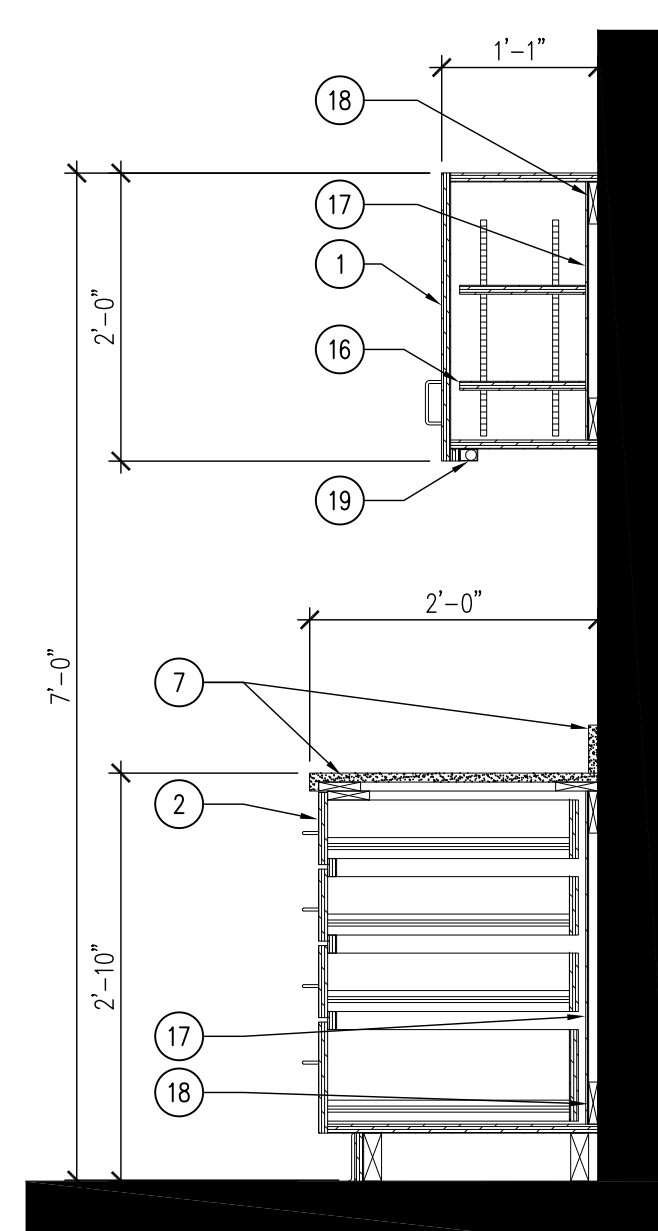
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06 MILLWORK SECTION  
SCALE: 3/4" = 1'-0"




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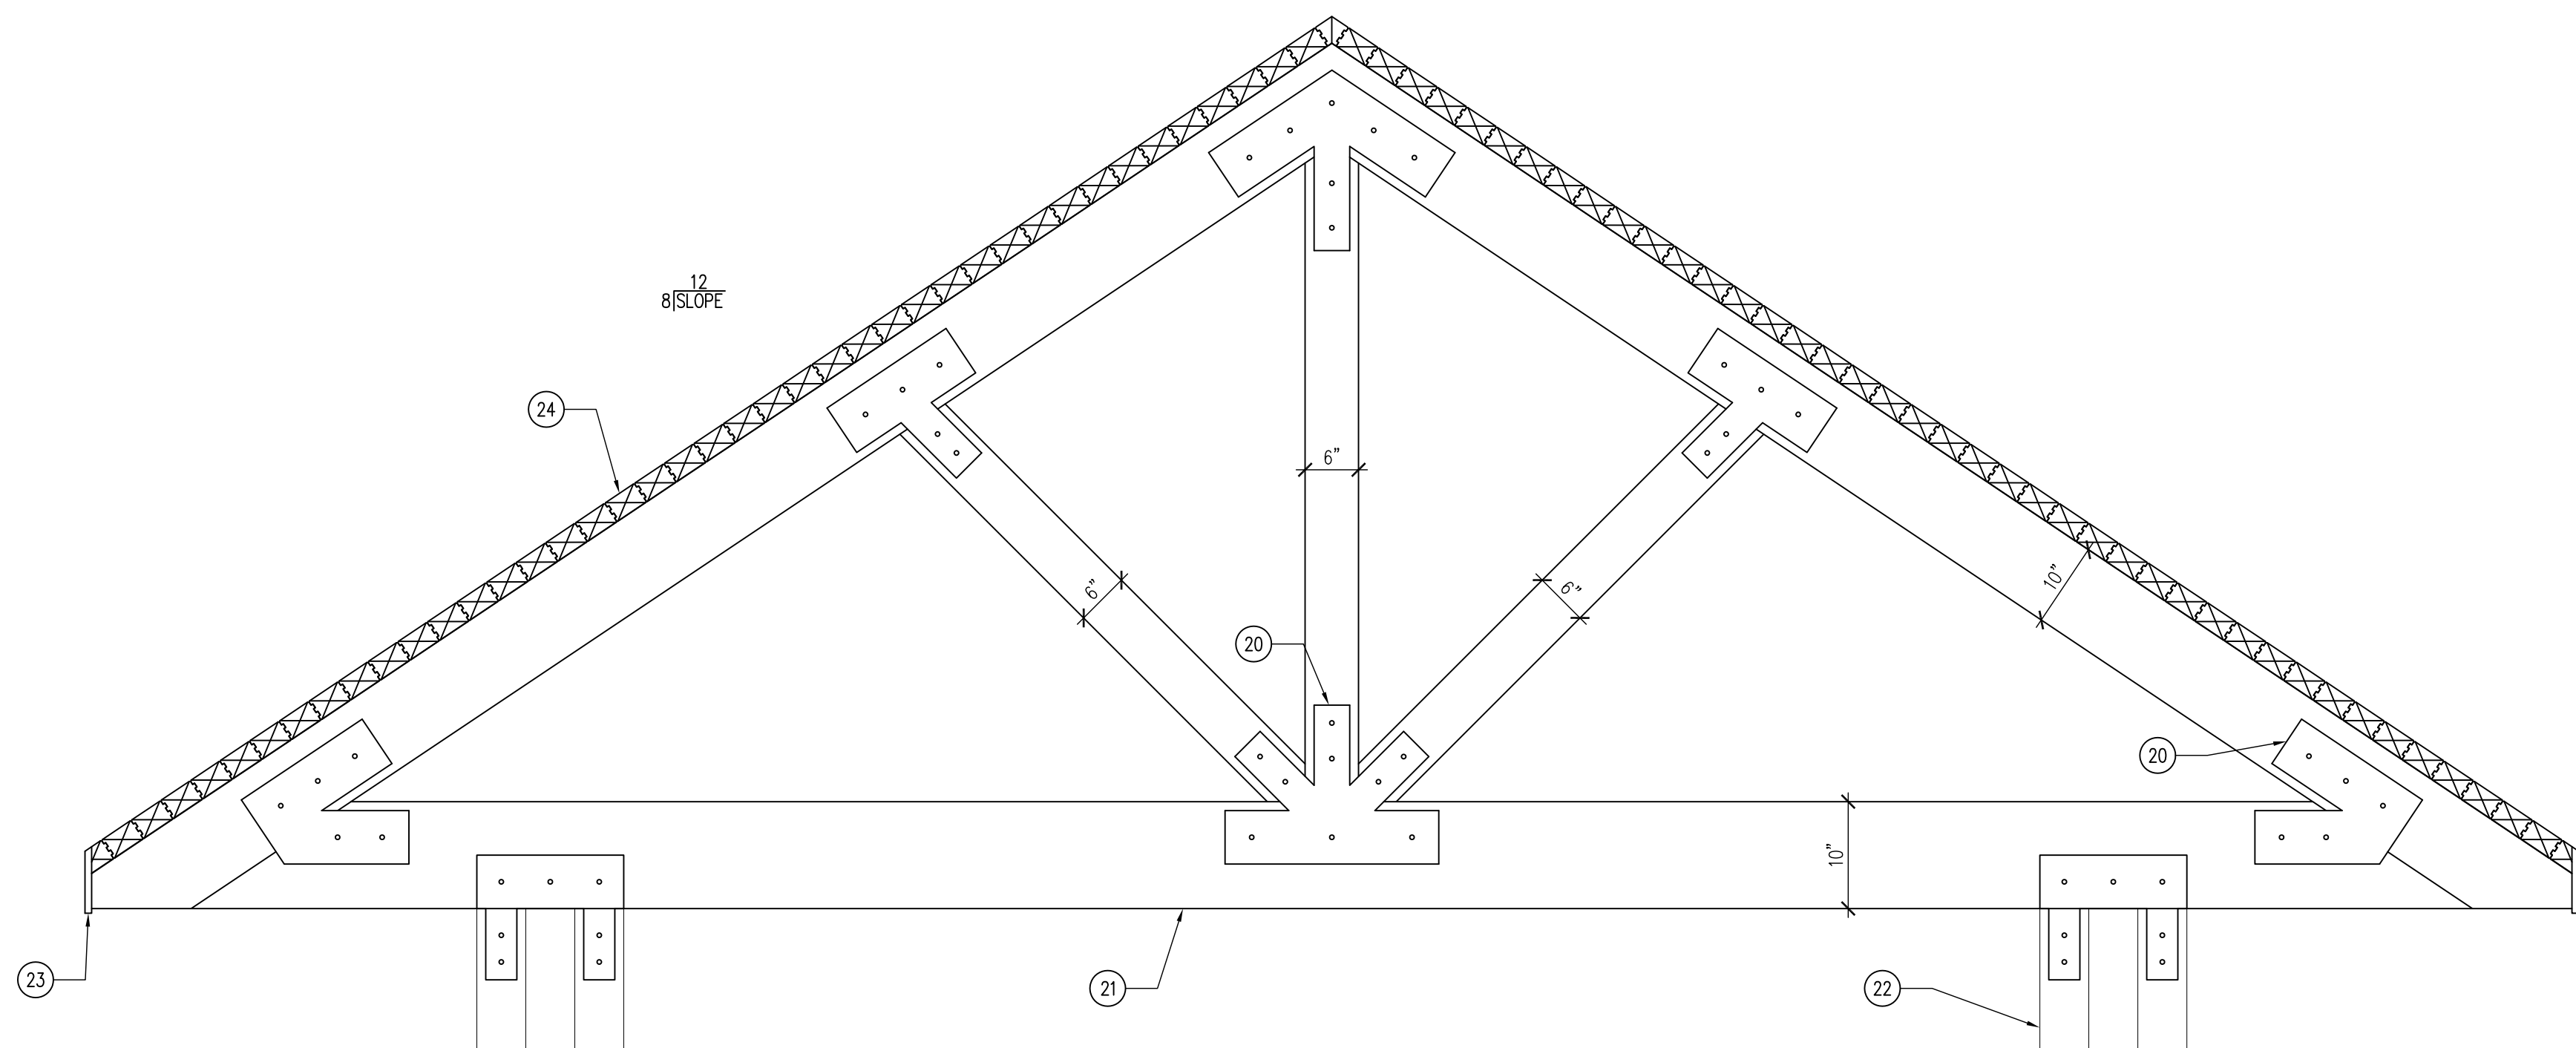


04 MILLWORK SECTION  
SCALE: 3/4" = 1'-0"

03 NOT USED  
SCALE: 1/2" = 1'-0"

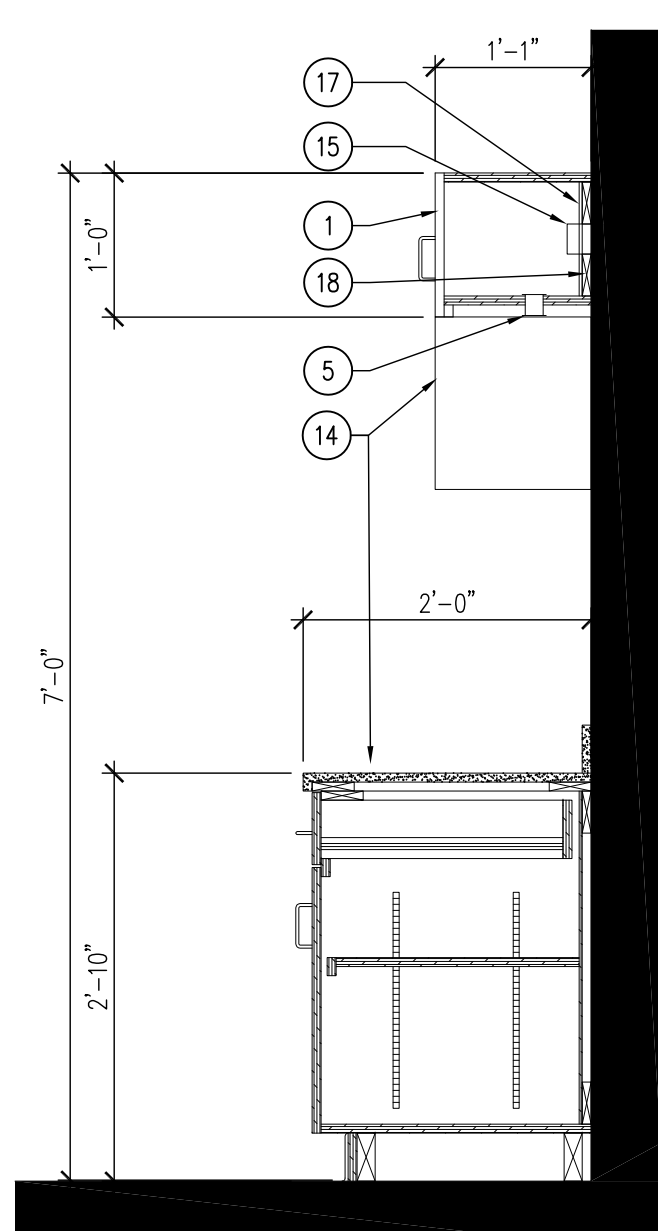

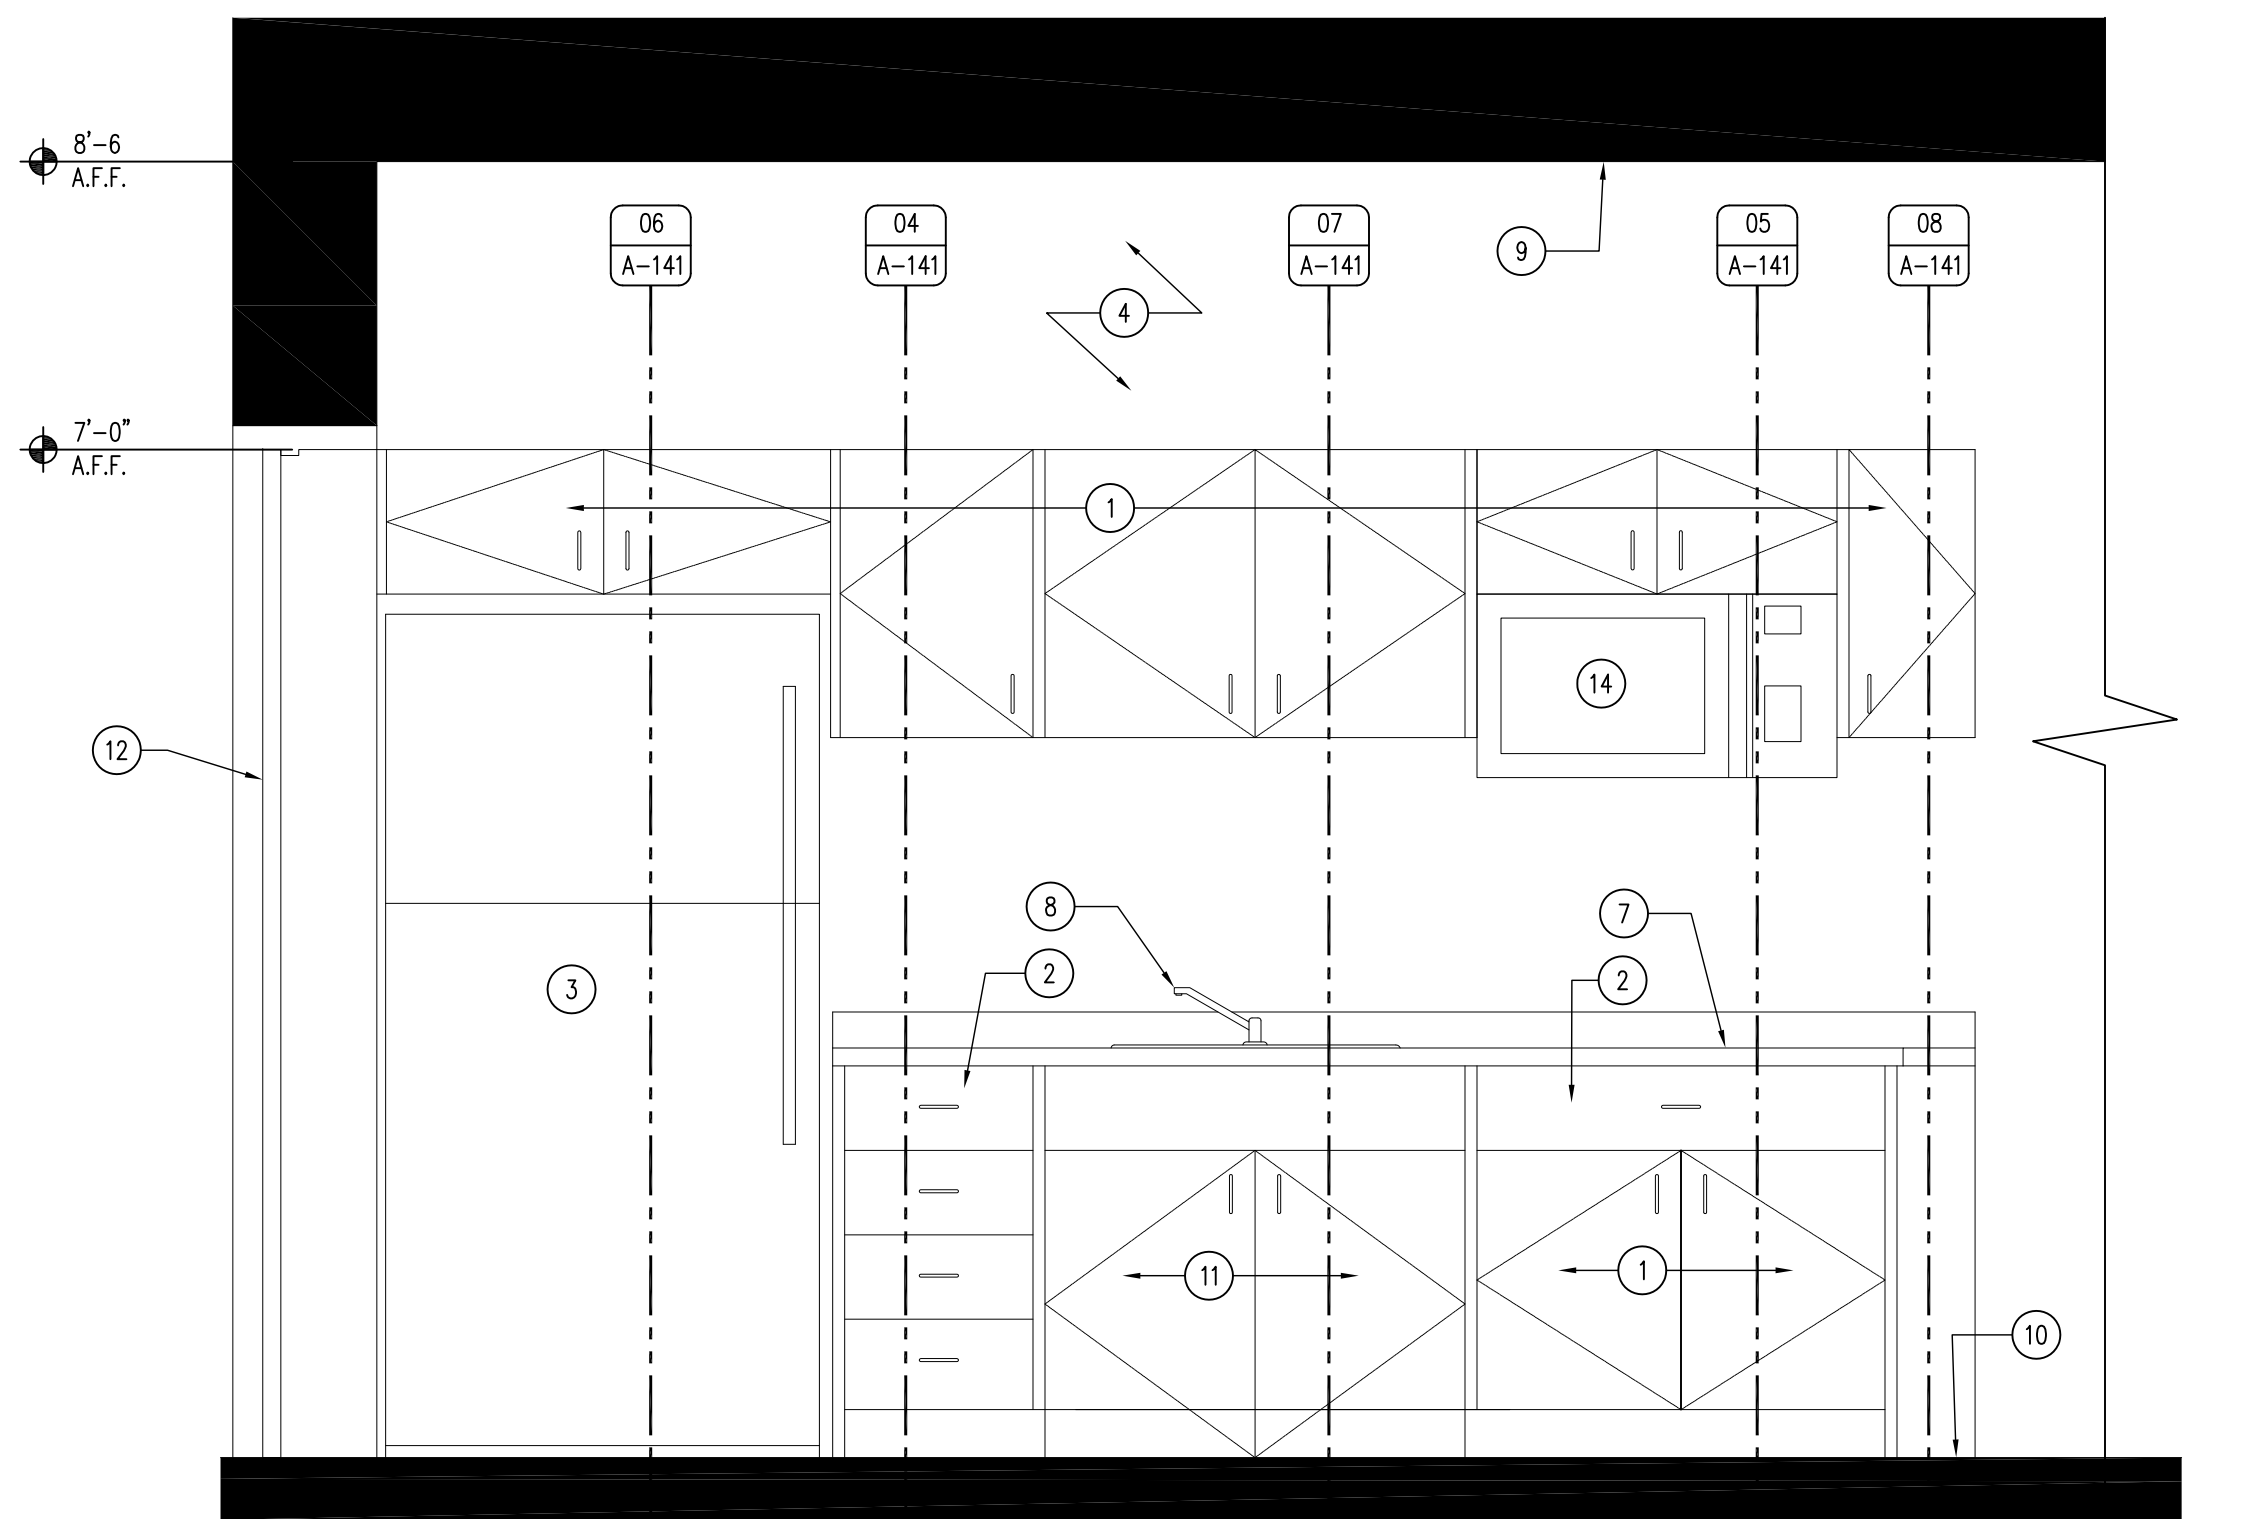02 INTERIOR ELEVATION  
SCALE: 3/4" = 1'-0"



01 ENLARGED TRUSS ELEVATION  
SCALE: 3/4" = 1'-0"

#### KEYNOTES

- 3/4" PLYWOOD DOOR ON CONCEALED HINGES WITH WOOD VENEER (WD-1). PROVIDE DECORATIVE HARDWARE WIRE PULLS (OIL RUBBED BRONZE). REFER TO FINISH SCHEDULE SHEET A-600.
- 3/4" PLYWOOD DRAWER WITH UNDERMOUNT SLIDES WITH WOOD VENEER (WD-1). PROVIDE DECORATIVE HARDWARE WIRE PULLS (OIL RUBBED BRONZE). REFER TO FINISH SCHEDULE SHEET A-600.
- REFRIGERATOR BY OWNER.
- WALL FINISH AS SCHEDULED, REFER TO SHEET A-600.
- GROMMET HOLE WITH PLASTIC GROMMET, SIZE ACCORDING TO MICROWAVE MANUFACTURER'S RECOMMENDATIONS.
- 3/4" PLYWOOD VALENCE WITH WOOD VENEER (WD-1). REFER TO FINISH SCHEDULE SHEET A-600.
- 3/4" SOLID SURFACE TOP (SS-1). REFER TO FINISH SCHEDULE SHEET A-600.
- TWO-BASIN STAINLESS STEEL UNDER-MOUNT SINK. REFER TO PLUMBING DRAWINGS.
- CEILING FINISH AS SCHEDULED. REFER TO REFLECTED CEILING PLAN SHEET A-110.
- FLOOR AS SCHEDULED. REFER TO FINISH SCHEDULE SHEET A-600.
- ADA COMPLIANT UNDER-SINK DOORS ON CONCEALED HINGES WITH WOOD VENEER (WD-1). PROVIDE DECORATIVE HARDWARE WIRE PULLS, REFER TO FINISH SCHEDULE SHEET A-600.
- DOOR AS SCHEDULED, REFER TO DOOR SCHEDULE SHEET A-600.
- NOT USED.
- MICROWAVE AND FAN EXHAUST COMBO SET. REFER TO ELECTRICAL DRAWINGS.
- ELECTRICAL OUTLET, REFER TO ELECTRICAL DRAWINGS.

- 3/4" PLYWOOD SHELF WITH PLASTIC LAMINATE (PL-1) AND HARDWOOD EDGE BANDING, PROVIDE ADJUSTABLE HARDWARE.
- 3/4" PLYWOOD BACKER BOARD WITH PLASTIC LAMINATE (PL-1).
- 2X WOOD BLOCKING AS REQUIRED.
- UNDER-CABINET LIGHT, REFER TO ELECTRICAL DRAWINGS.
- 3/8" STEEL CONNECTOR PLATE, EACH SIDE, AS SHOWN, POWDER COAT BLACK, WITH 3/4" GALVANIZED CARRIAGE BOLTS WITH LOCK-WASHERS AND NUTS.
- 6X ROUGH-SAWN DOUGLAS FIR TRUSS, WITH TWO COATS TWP STAIN (103 DARK OAK). REFER TO DIMENSIONS.
- 6X6 ROUGH SAWN DOUGLAS FIR COLUMNS, TWO COATS TWP STAIN (103 DARK OAK).
- 2X FASCIA TO MATCH ROOF FASCIA, WRAP IN METAL TO MATCH ROOF.
- 3X DOUGLAS FIR TAG ROOF DECKING, TWO COATS CLEAR POLYURETHANE BOTTOM SIDE (DO NOT STAIN). INSTALL WATER & ICE SHIELD ACROSS ENTIRE ROOF PRIOR TO INSTALL METAL ROOF.

#### GENERAL NOTES

- REFER TO FINISH, DOOR & WINDOW SCHEDULE, SHEET A-600.
- REFER TO REFLECTED CEILING PLAN FOR CEILING HEIGHTS, SHEET A-110.
- REFER TO INDEX SHEET FOR WALL TYPES, SHEET A-002.
- FIELD VERIFY ALL DIMENSIONS PRIOR TO CONSTRUCTION, SHEET A-101.
- FIELD VERIFY ALL EQUIPMENT LOCATIONS FOR ELECTRICAL OUTLET LOCATIONS, REFER TO ELECTRICAL PLAN.
- CONTRACTOR SHALL HAVE THIS BUILDING, PRIOR TO CONSTRUCTION, PRE-ENGINEERED BY BUILDING SUPPLIER.
- ALL PLYWOOD PRODUCTS TO HAVE NO ADDED UREA-FORMALDEHYDE (NAUF).
- ALL PLYWOOD CABINET AND DRAWER SURFACES TO HAVE VOC FREE CLEAR SATIN FINISH.

#### INTERIOR ELEVATIONS & MILLWORK SECTIONS

NEW OFFICE & STORAGE BUILDING FOR:

### GREEN VALLEY STATE PARK

1480 130TH STREET

UNION COUNTY, IOWA

CONSULTANT:

#### IOWA DEPARTMENT OF NATURAL RESOURCES

ENGINEERING SERVICES - WALLACE BUILDING  
502 E. 9TH ST., DES MOINES, IA 50319-0034  
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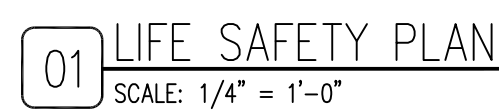
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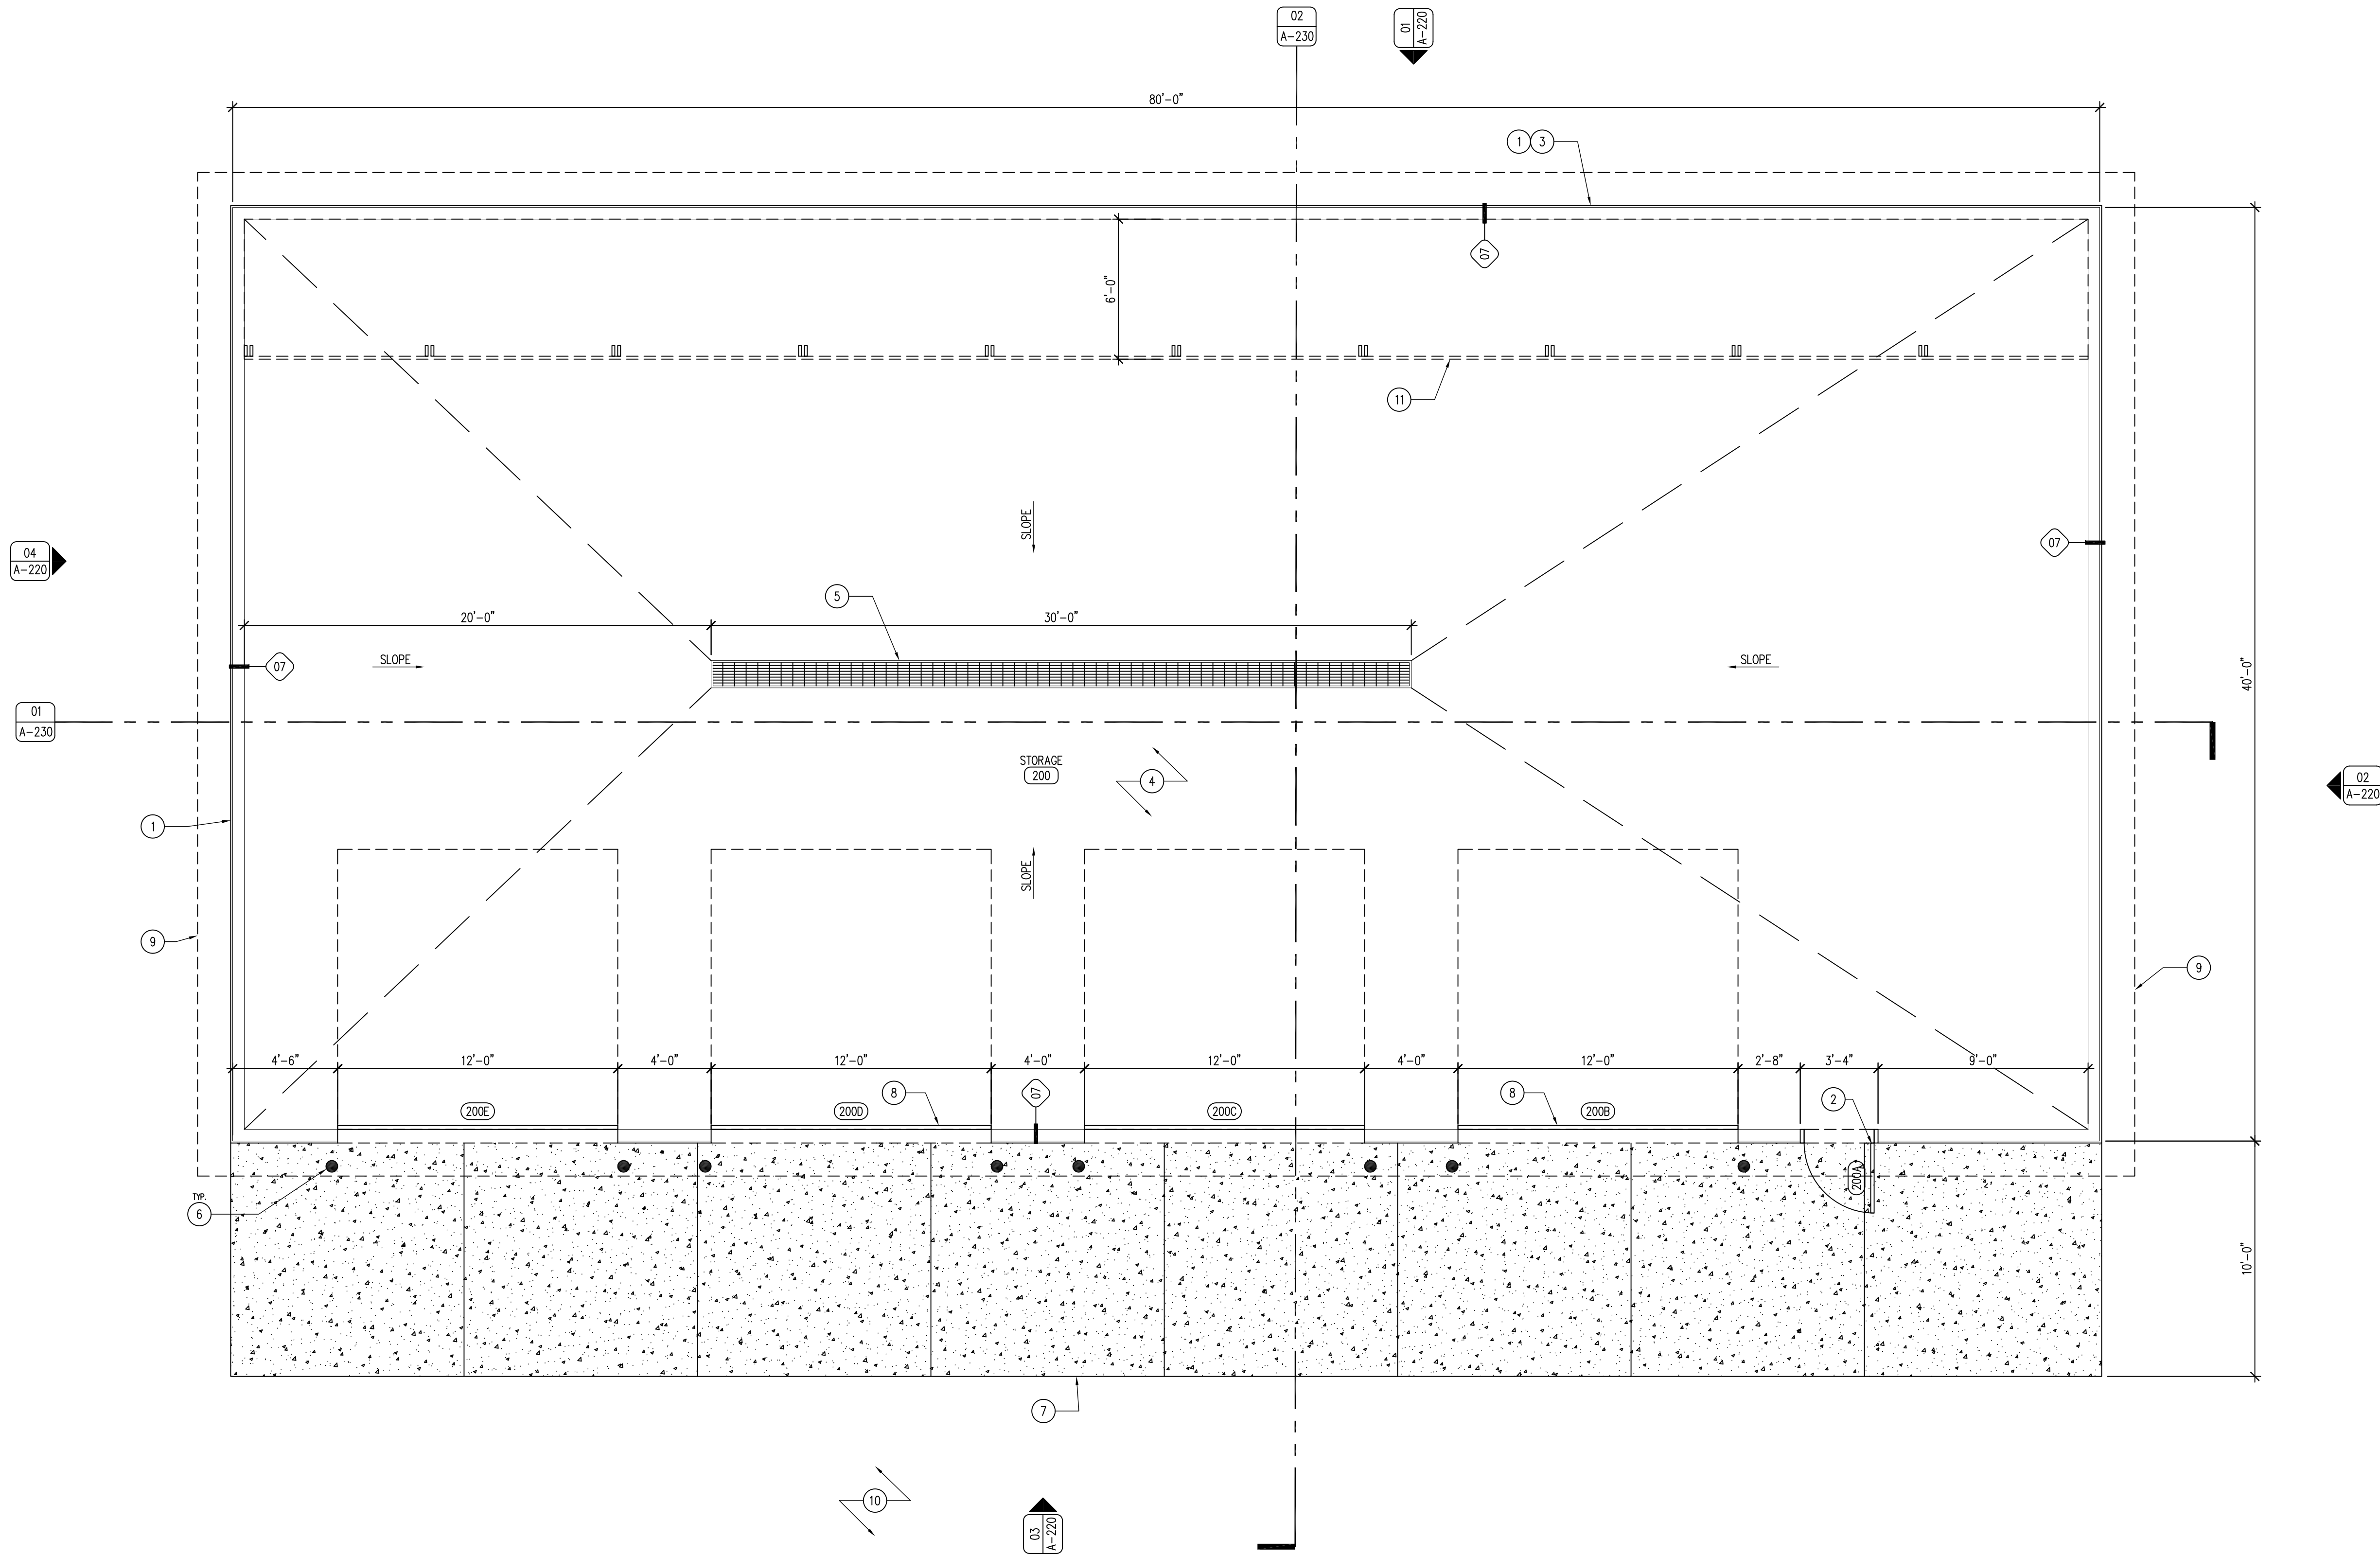


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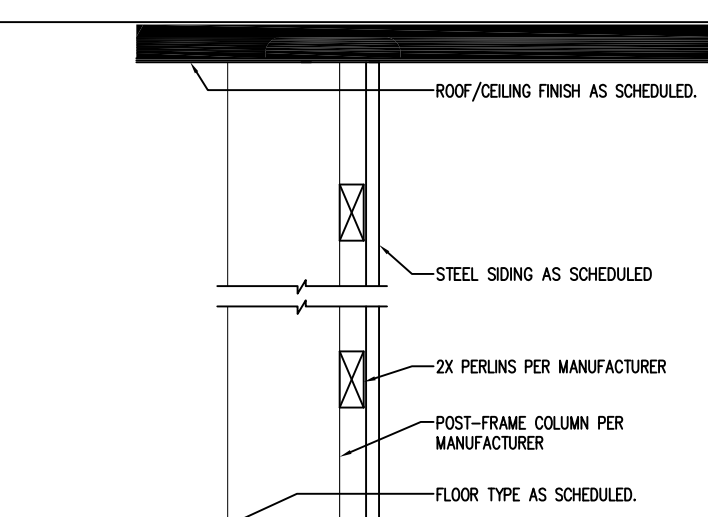




01 REFERENCE FLOOR PLAN  
SCALE: 1/4" = 1'-0"



WALL TYPE



07 NON-RATED/LOAD BEARING  
POST-FRAME STRUCTURE

KEYNOTES

1. POST-FRAME BUILDING WITH 26 GAUGE METAL SALES PRO-PANEL II, COLOR TBD, SUBMIT SAMPLES.
2. DOOR AS SCHEDULED, REFER TO SHEET A-600.
3. REAR OF BUILDING TO RECEIVE 48" POLYCARBONATE WINDOW ACROSS ENTIRE LENGTH OF BUILDING.
4. 6" CONCRETE BUILDING SLAB OVER 4" SUBBASE, #4 REBAR 24" O.C. BOTH DIRECTIONS.
5. STEEL TRENCH DRAIN WITH HEAVY-DUTY STEEL GRATE, REFER TO PLUMBING DRAWINGS.
6. STEEL TRAFFIC BOLLARD WITH PLASTIC COVER SLEEVE, REFER TO DETAIL 02/A-202.
7. 6" CONCRETE APRON OVER 4" SUBBASE, #4 REBAR 24" O.C. BOTH DIRECTIONS.
8. OVERHEAD GARAGE DOOR, REFER TO DOOR SCHEDULE SHEET A-600.
9. ROOF LINE ABOVE.
10. CRUSHED LIMESTONE EQUIPMENT YARD, REFER TO CIVIL PLANS.
11. 6'-0" DEEP STORAGE LOFT, HUNG FROM TRUSSES ABOVE AND SUPPORTED BY SIDEWALL POLES. DESIGNED BY BUILDING MANUFACTURER TO SUPPORT 100 PSF. HEAD CLEARANCE TO BE MINIMUM 7'-6" A.F.F., REMOVABLE SAFETY CHAIN TO BE INSTALLED AT 2'-0" ABOVE DECK ACROSS ENTIRE LENGTH OF LOFT.

GENERAL NOTES

- A. REFER TO FINISH & DOOR SCHEDULE, SHEET A-600.
- B. REFER TO INDEX SHEET FOR WALL TYPES, A-002.
- C. REFER TO MECHANICAL, ELECTRICAL, PLUMBING SHEETS FOR MORE INFORMATION.
- D. FIELD VERIFY ALL DIMENSIONS PRIOR TO CONSTRUCTION.
- E. THIS BUILDING SHALL BE PRE-ENGINEERED BY BUILDING SUPPLIER.


REFERENCE FLOOR PLAN

NEW OFFICE & STORAGE BUILDING FOR:

GREEN VALLEY STATE PARK

UNION COUNTY, IOWA  
1480 130TH STREET

CONSULTANT:

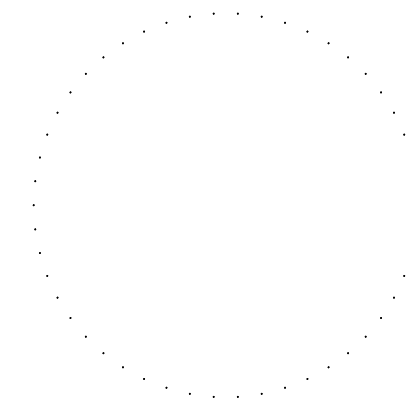

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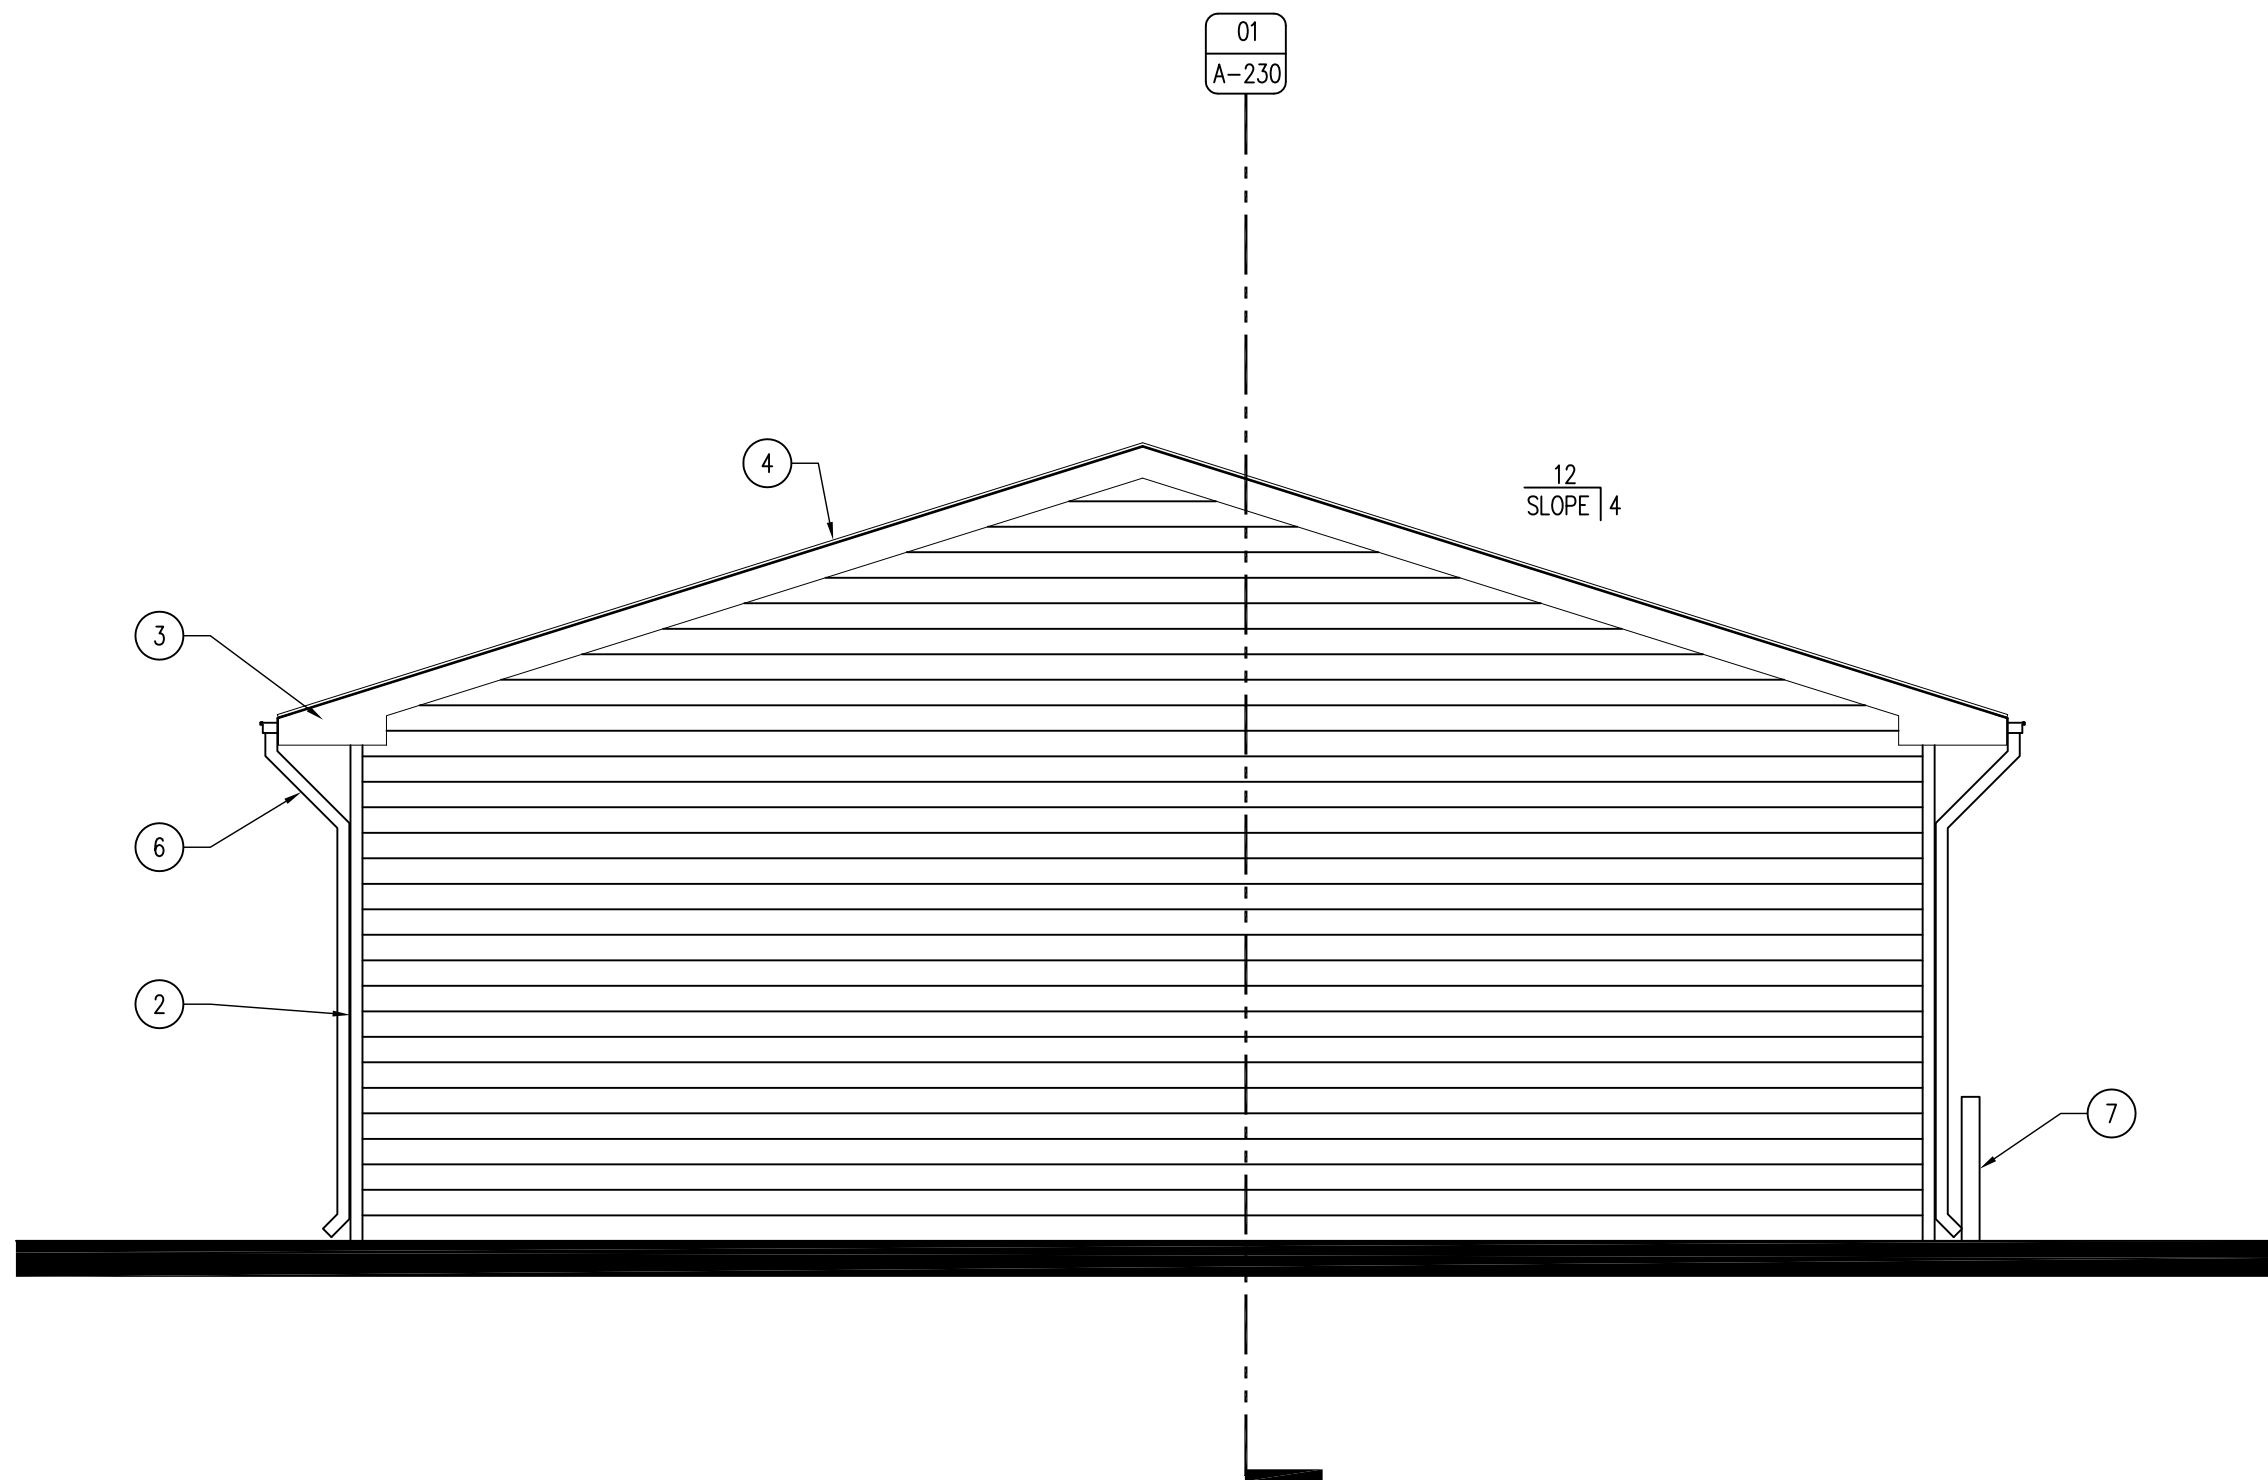
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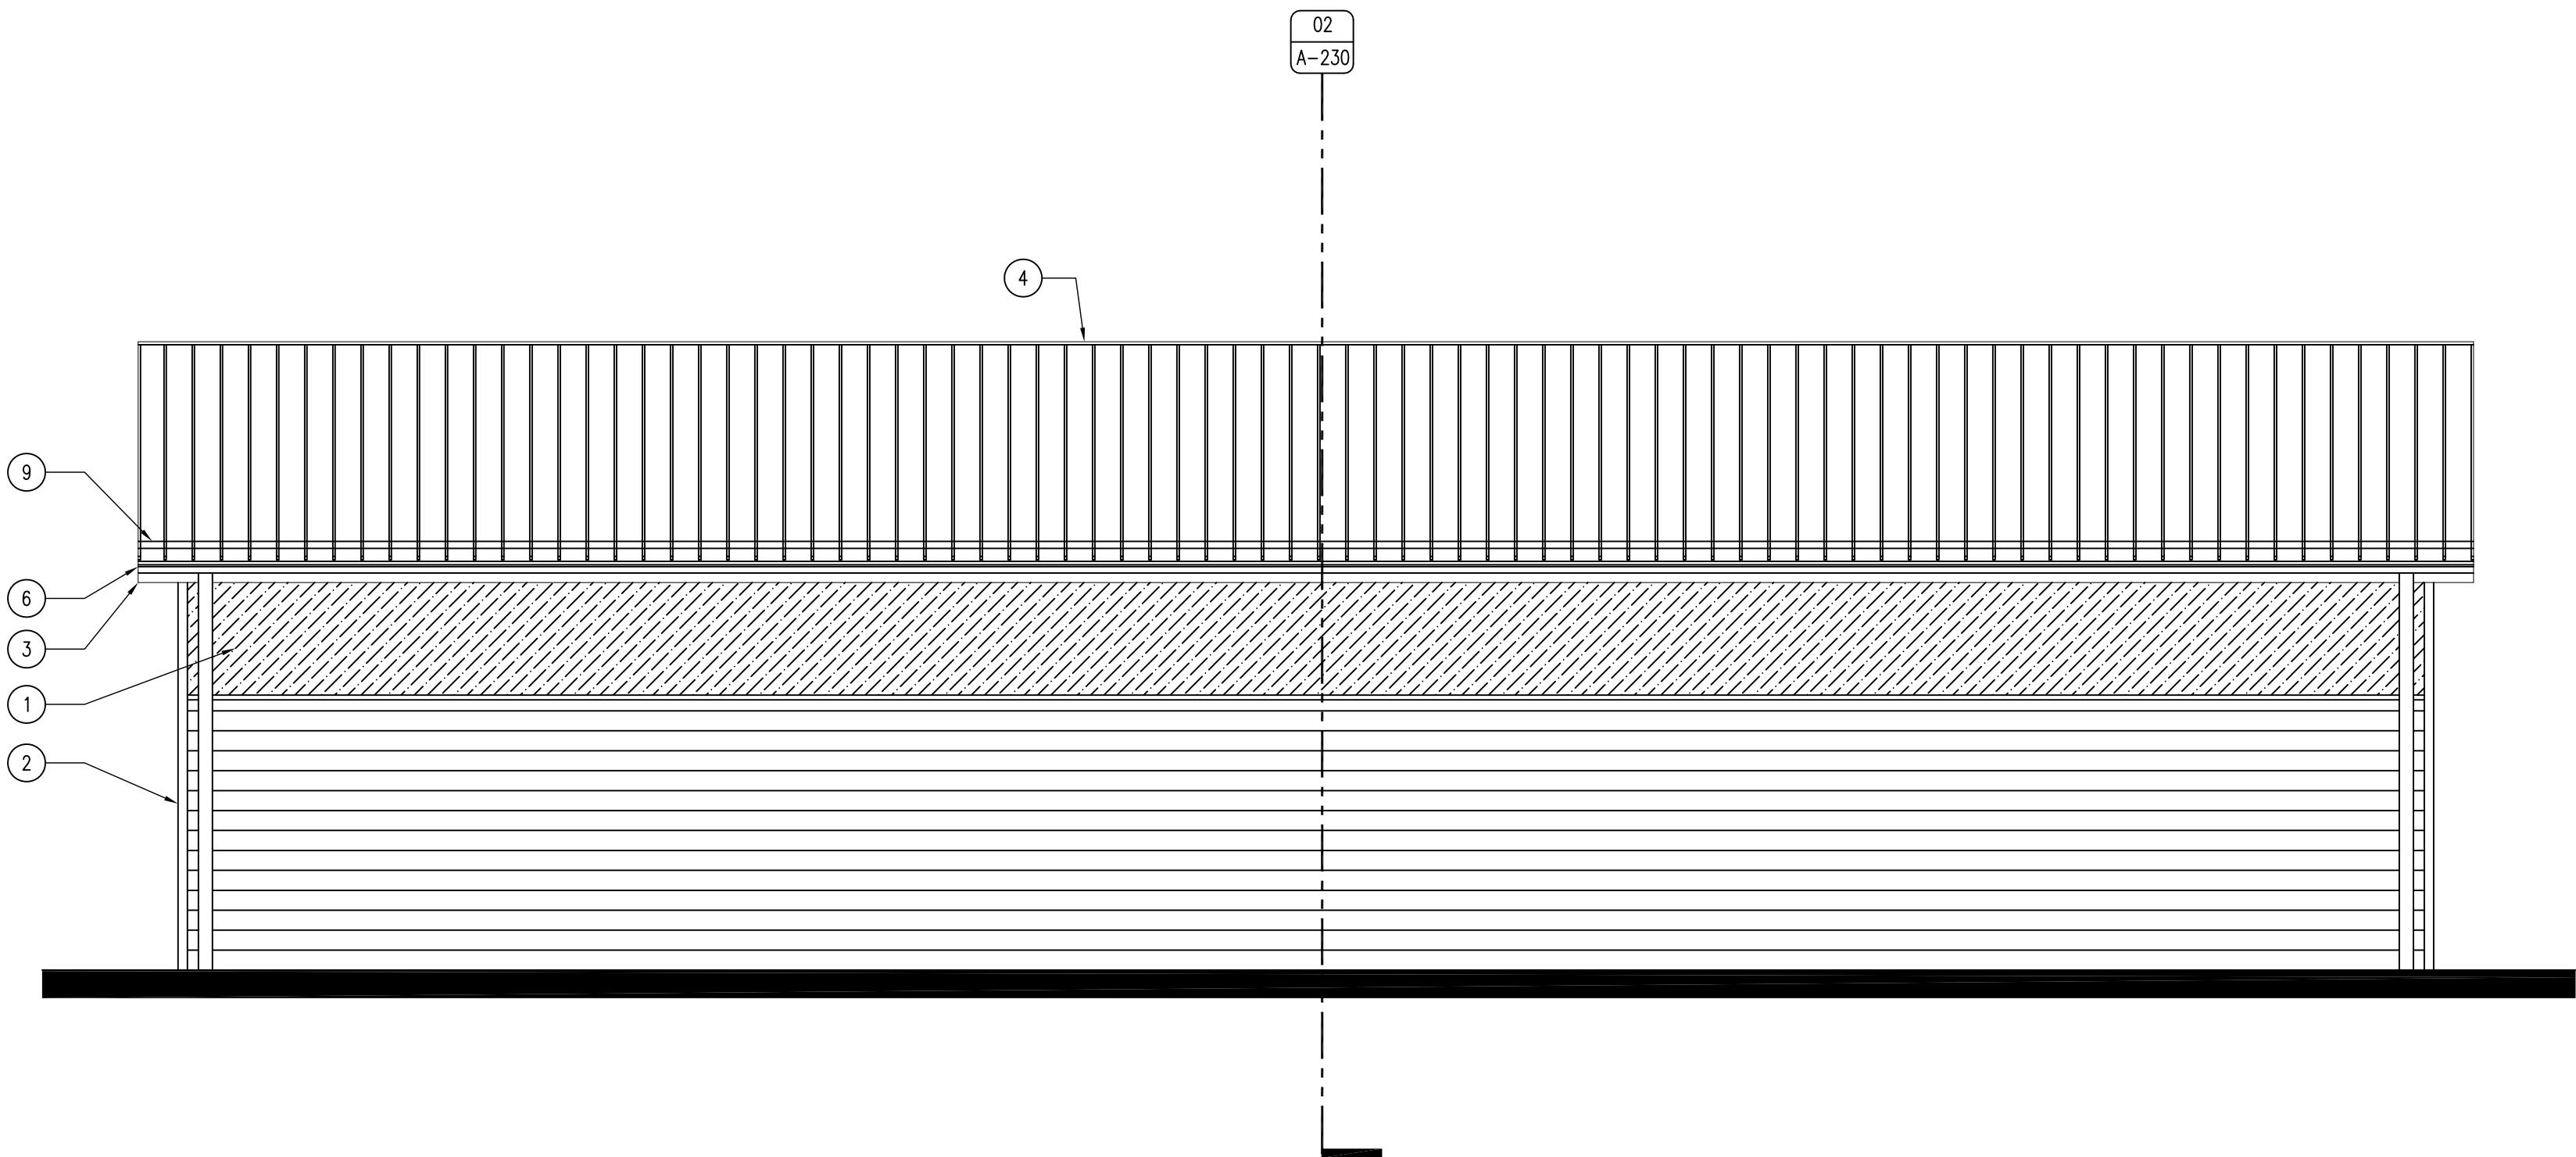
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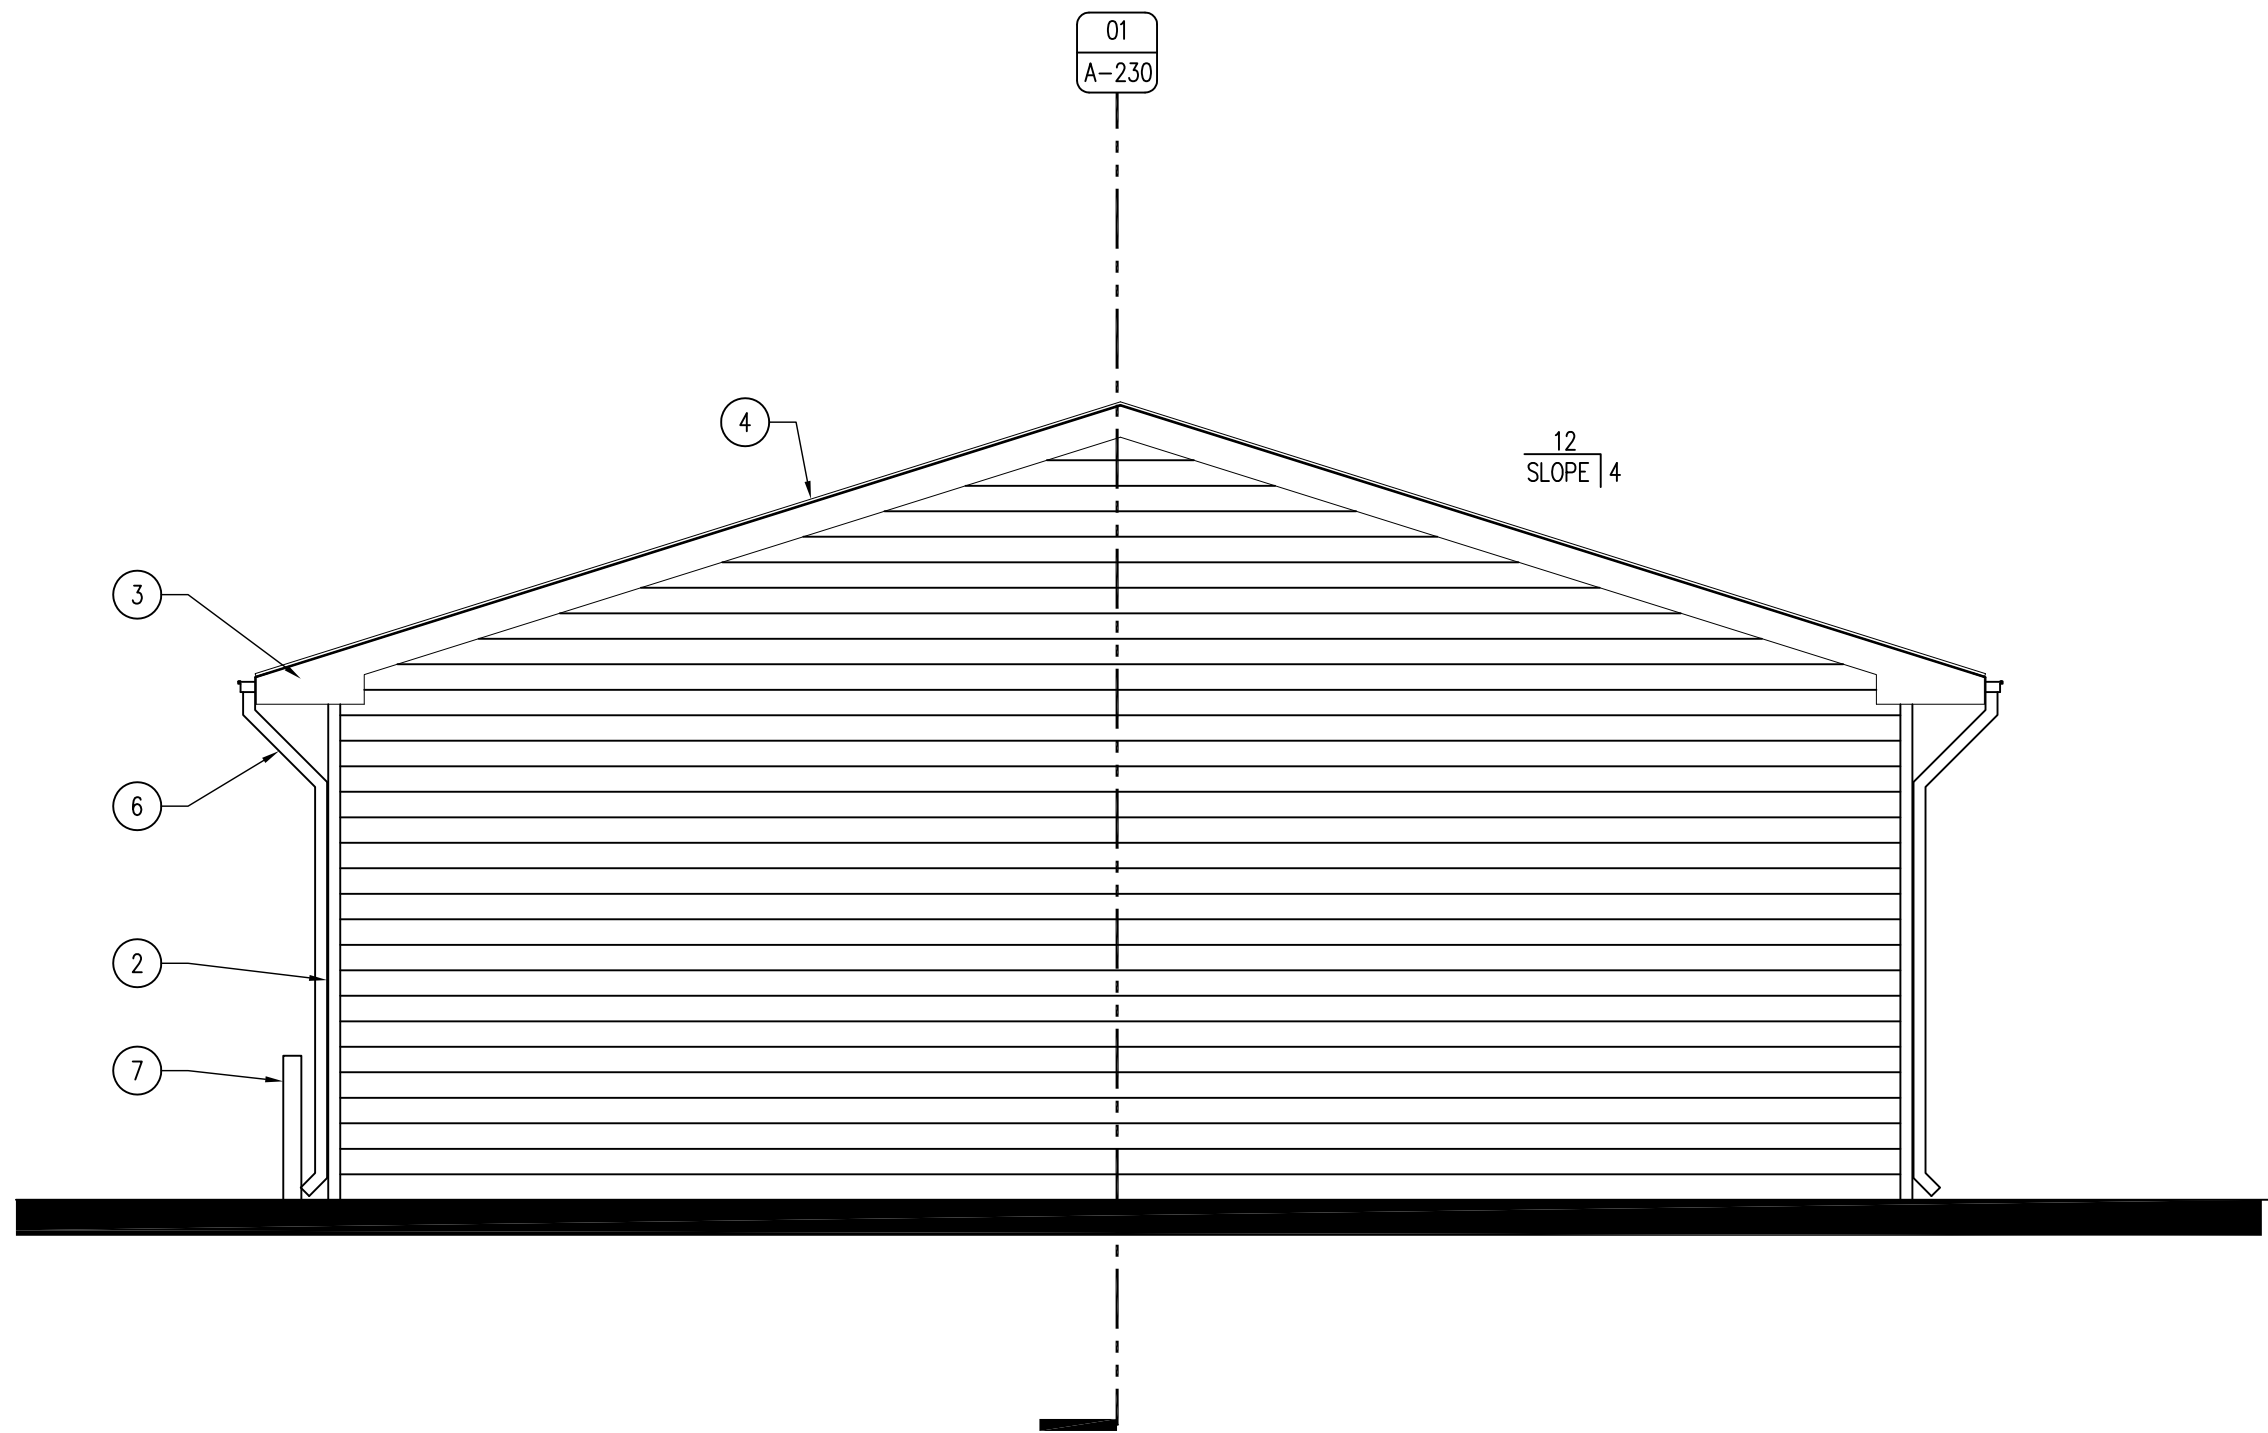





04 EXTERIOR ELEVATION – SOUTH  
SCALE: 3/16" = 1'-0"



03 EXTERIOR ELEVATION – WEST  
SCALE: 3/16" = 1'-0"



02 EXTERIOR ELEVATION – NORTH  
SCALE: 3/16" = 1'-0"

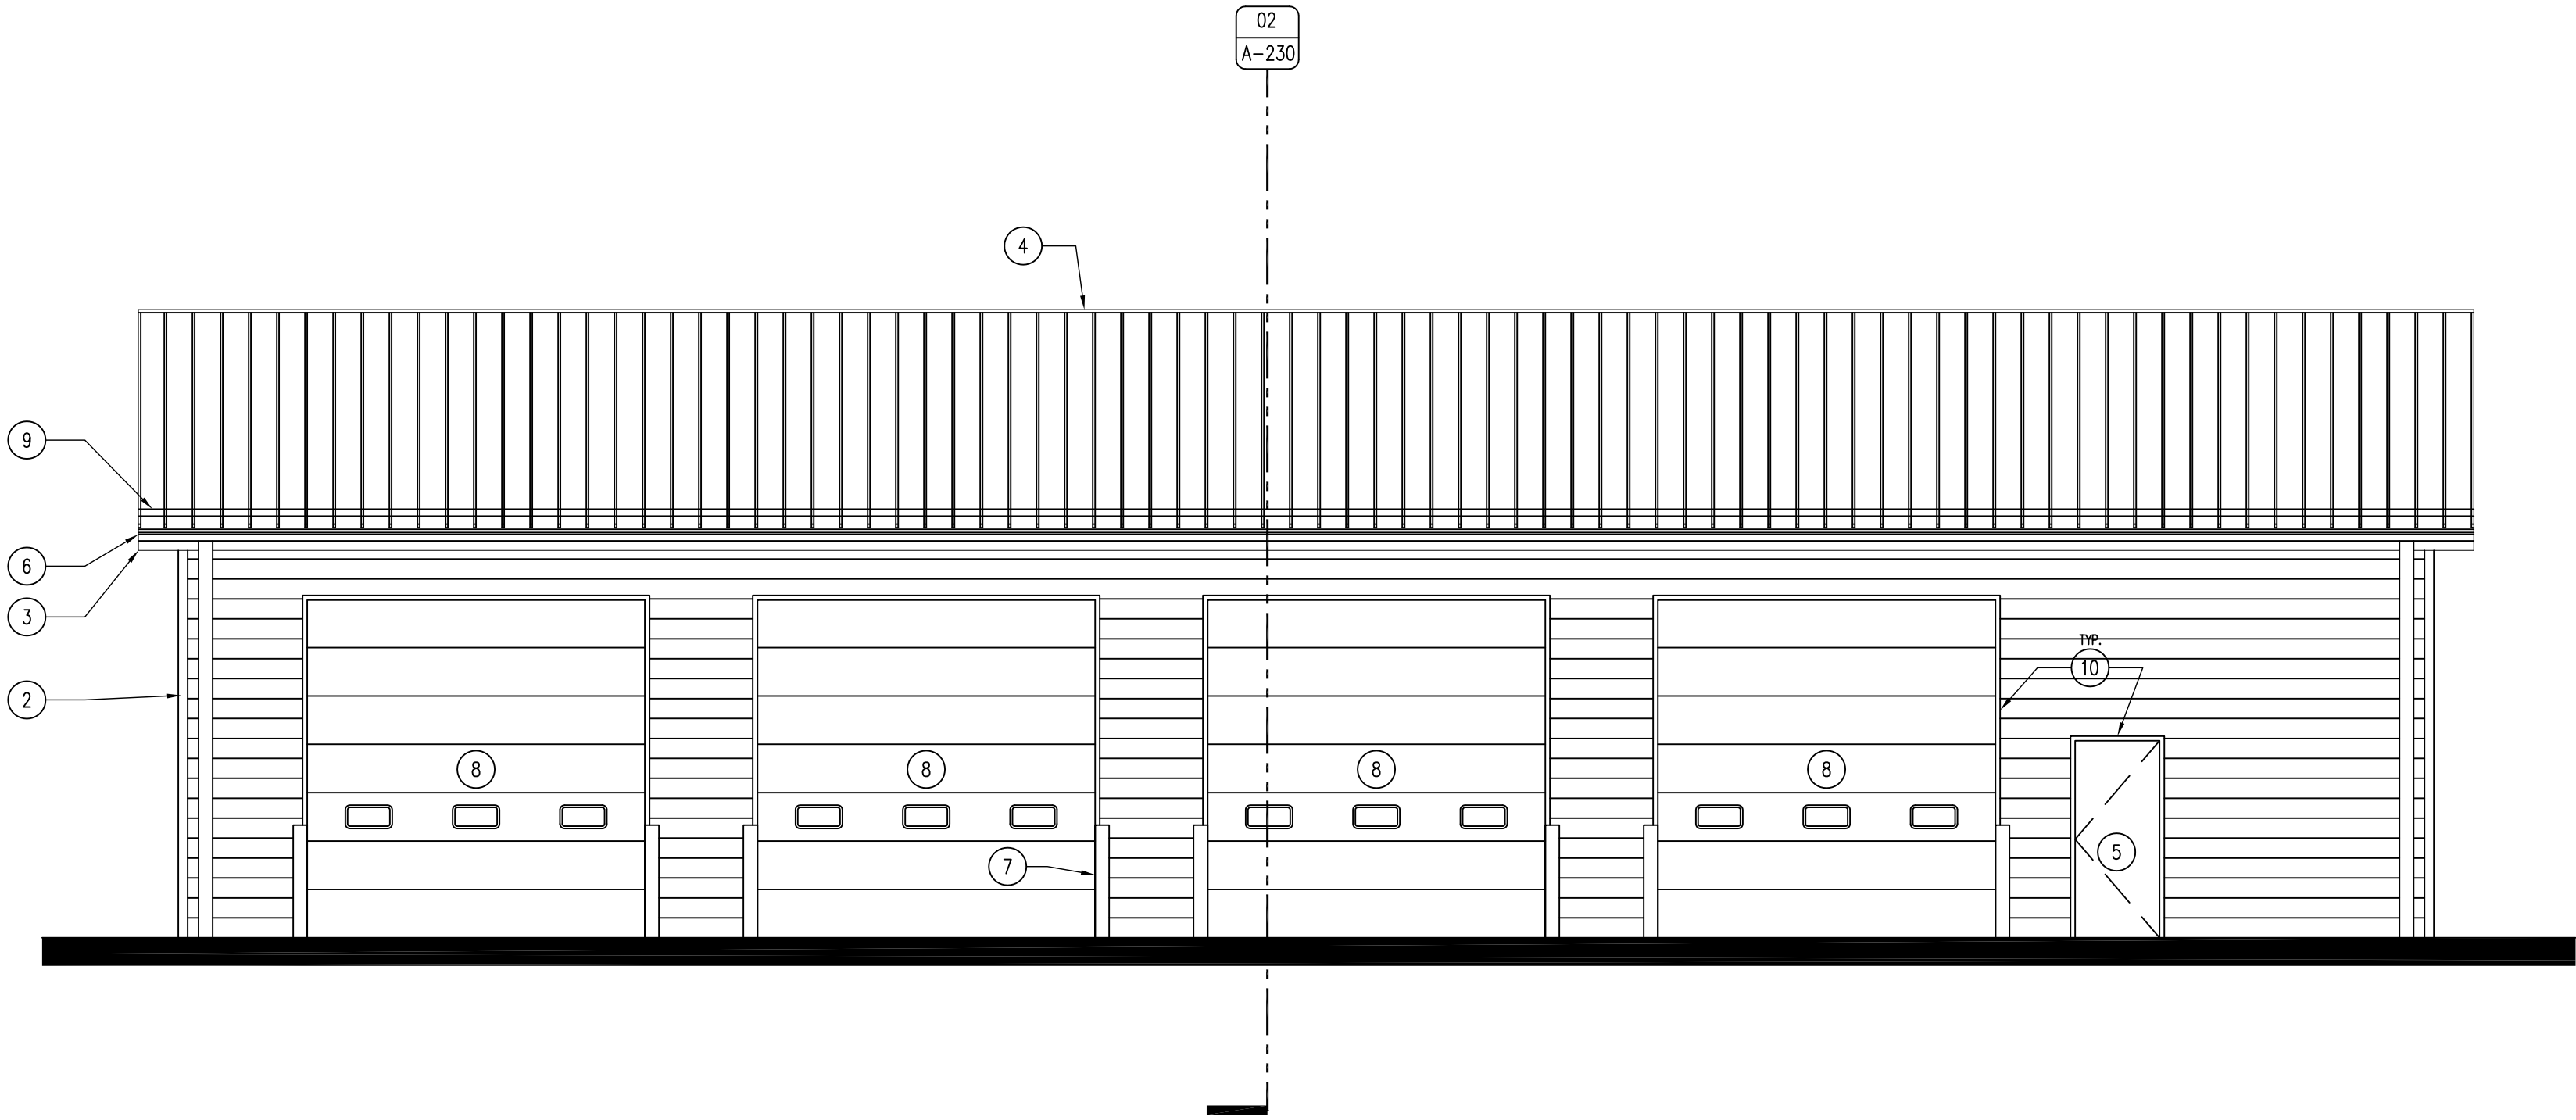

01 EXTERIOR ELEVATION – EAST  
SCALE: 3/16" = 1'-0"

KEYNOTES

1. POLYCARBONATE WINDOW LIGHT, 48" TALL X ENTIRE LENGTH OF BUILDING, BY BUILDING MANUFACTURER.
2. POST-FRAME BUILDING WITH 26 GAUGE METAL SALES PRO-PANEL II SIDING, COLOR TBD, SUBMIT SAMPLES.
3. SOFFIT AND FASCIA METAL PANEL, COLOR TO MATCH ROOF.
4. 24 GAUGE PAC-CLAD SNAP-CLAD METAL ROOF WITH STRIATIONS, COLOR TO BE DARK BRONZE.
5. DOOR AS SCHEDULED, REFER TO SHEET A-600.
6. METAL GUTTER AND DOWNSPOUT SYSTEM TO MATCH ROOF, FASCIA AND SOFFIT.
7. STEEL TRAFFIC BOLLARD WITH PLASTIC COVER SLEEVE, REFER TO DETAIL 02/A-202.
8. INSULATED OVERHEAD GARAGE DOOR WITH THREE SAFETY LIGHTS, REFER TO DOOR SCHEDULE SHEET A-600.
9. METAL SNOW GUARD BARS OF BOTH EAVES, ENTIRE LENGTH OF BUILDING, COLOR TO MATCH ROOF.

GENERAL NOTES

- A. REFER TO FINISH & DOOR SCHEDULE, SHEET A-600.
- B. REFER TO INDEX SHEET FOR WALL TYPES, A-002.
- C. REFER TO MECHANICAL, ELECTRICAL, PLUMBING SHEETS FOR MORE INFORMATION.
- D. FIELD VERIFY ALL DIMENSIONS PRIOR TO CONSTRUCTION.
- E. THIS BUILDING SHALL BE PRE-ENGINEERED BY BUILDING SUPPLIER.

CONSULTANT:

**IOWA DEPARTMENT OF  
NATURAL RESOURCES**  
ENGINEERING SERVICES - WALLACE BUILDING  
502 E. 9TH ST., DES MOINES, IA 50319-0034  
P: 515.725.8200  
F: 515.725.8202



EXTERIOR ELEVATIONS

NEW OFFICE & STORAGE BUILDING FOR:

**GREEN VALLEY STATE PARK**

UNION COUNTY, IOWA

1480 130TH STREET

NO. BY DATE REVISION


DRAWN BY: PROJECT NUMBER:  
15-04-88-01

CHK'D BY: DATE:  
07.29.2015


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**A-220**




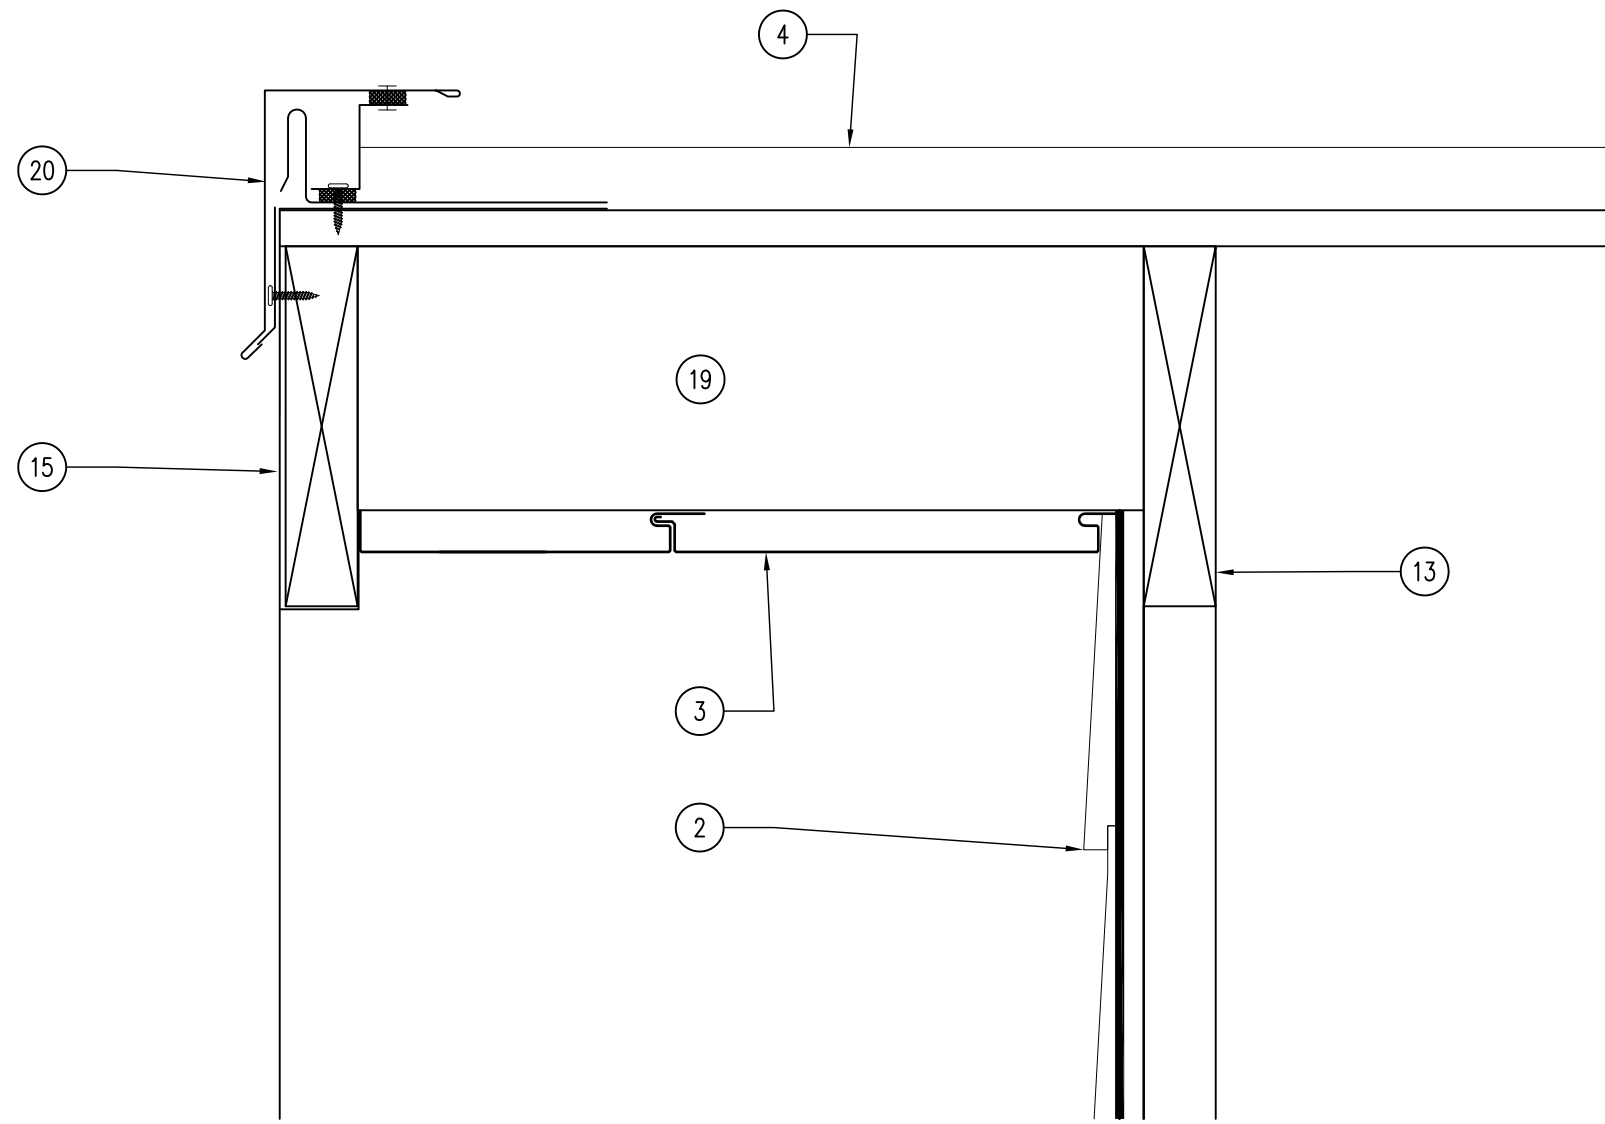


05 DETAIL — ROOF GABLE  
SCALE: 3" = 1'-0"

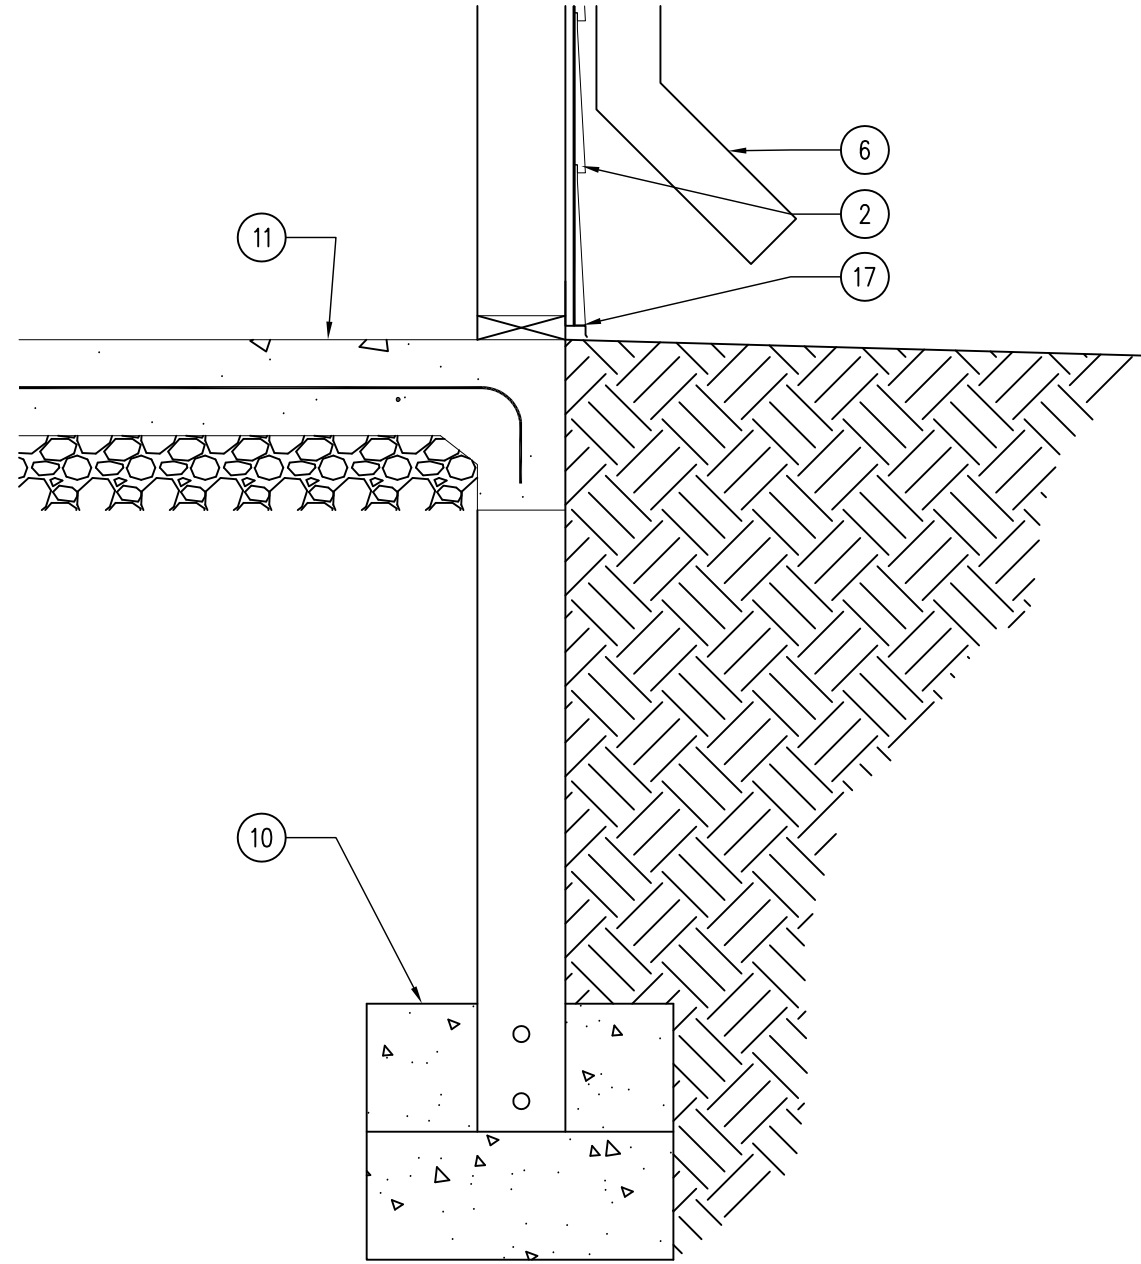


04 DETAIL — POST FRAME BUILDING FOOTING  
SCALE: 1" = 1'-0"

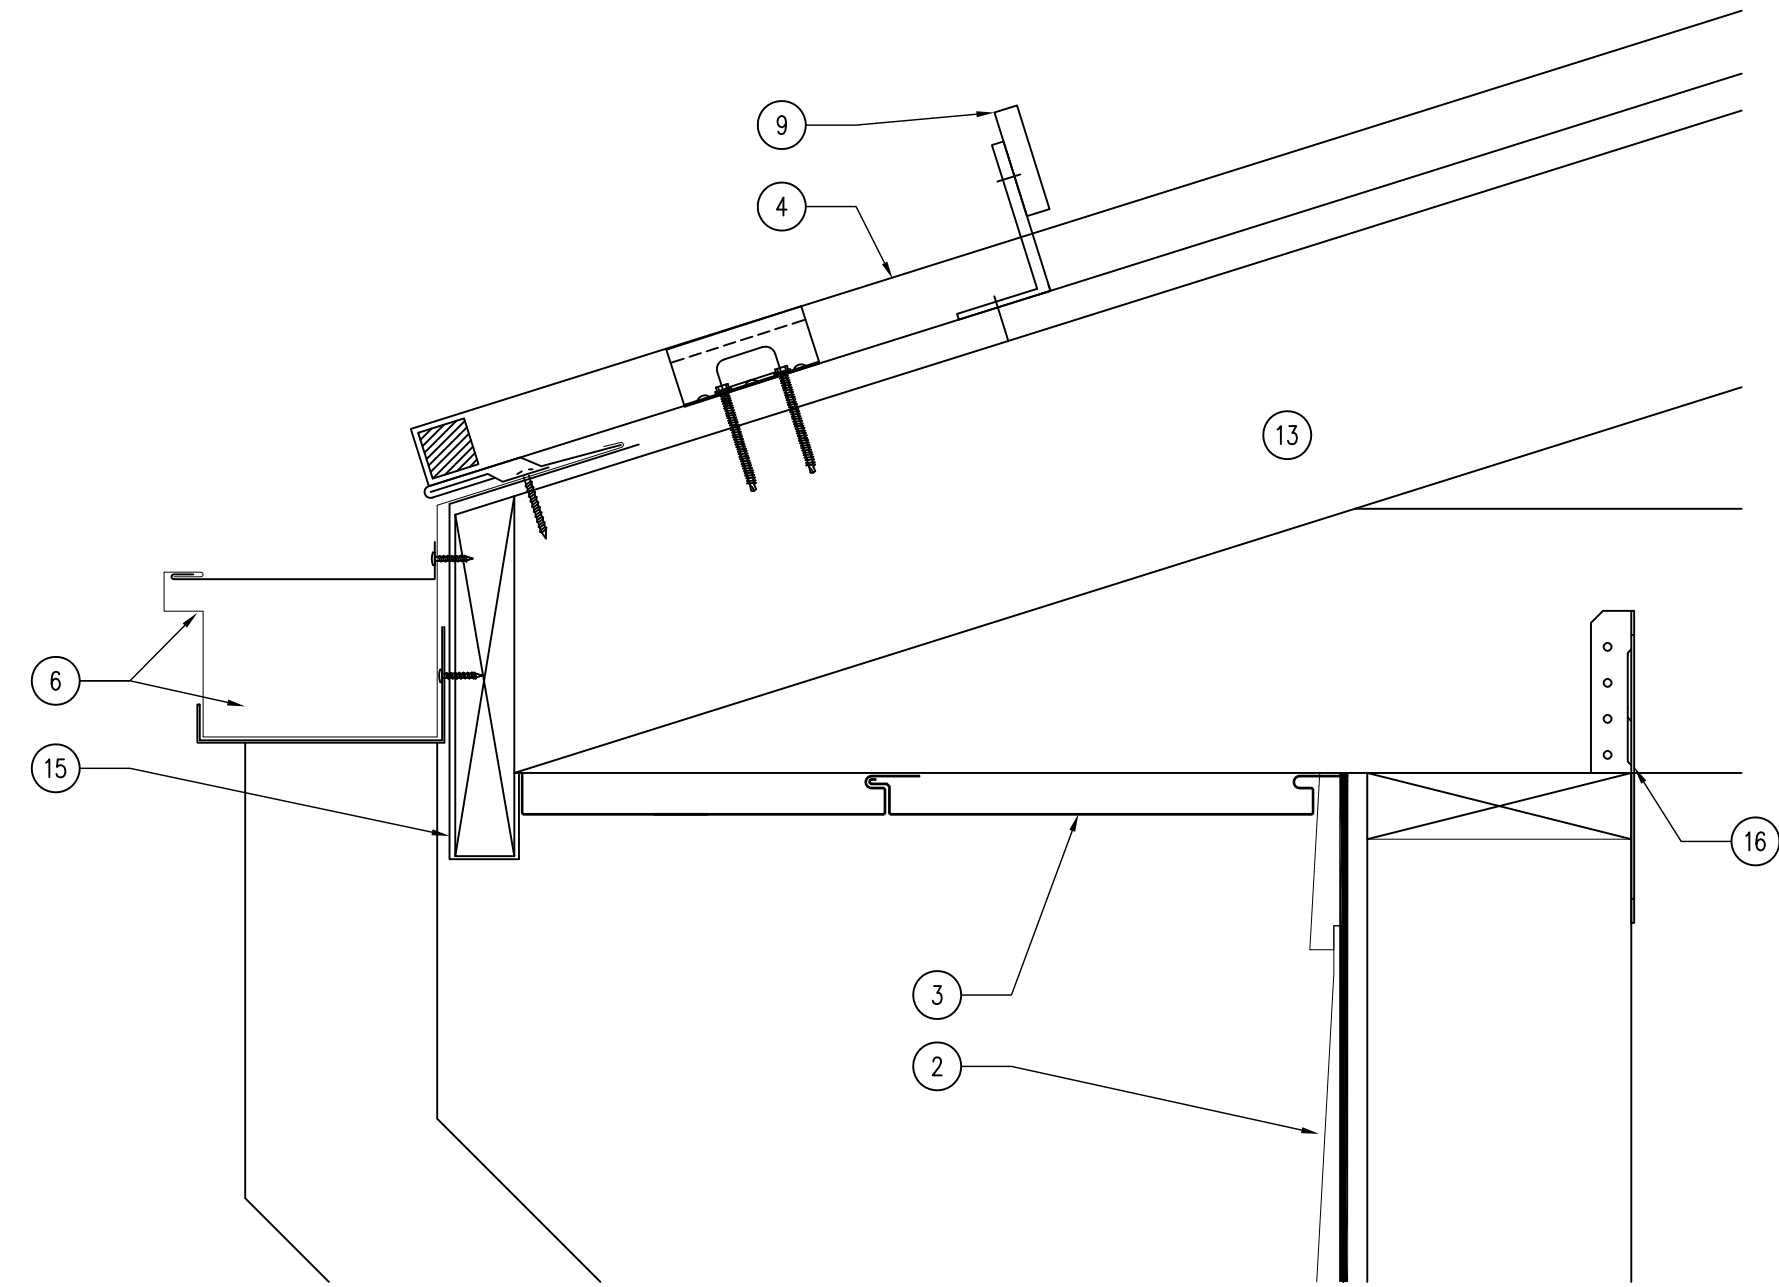

03 DETAIL — ROOF EAVE  
SCALE: 3" = 1'-0"

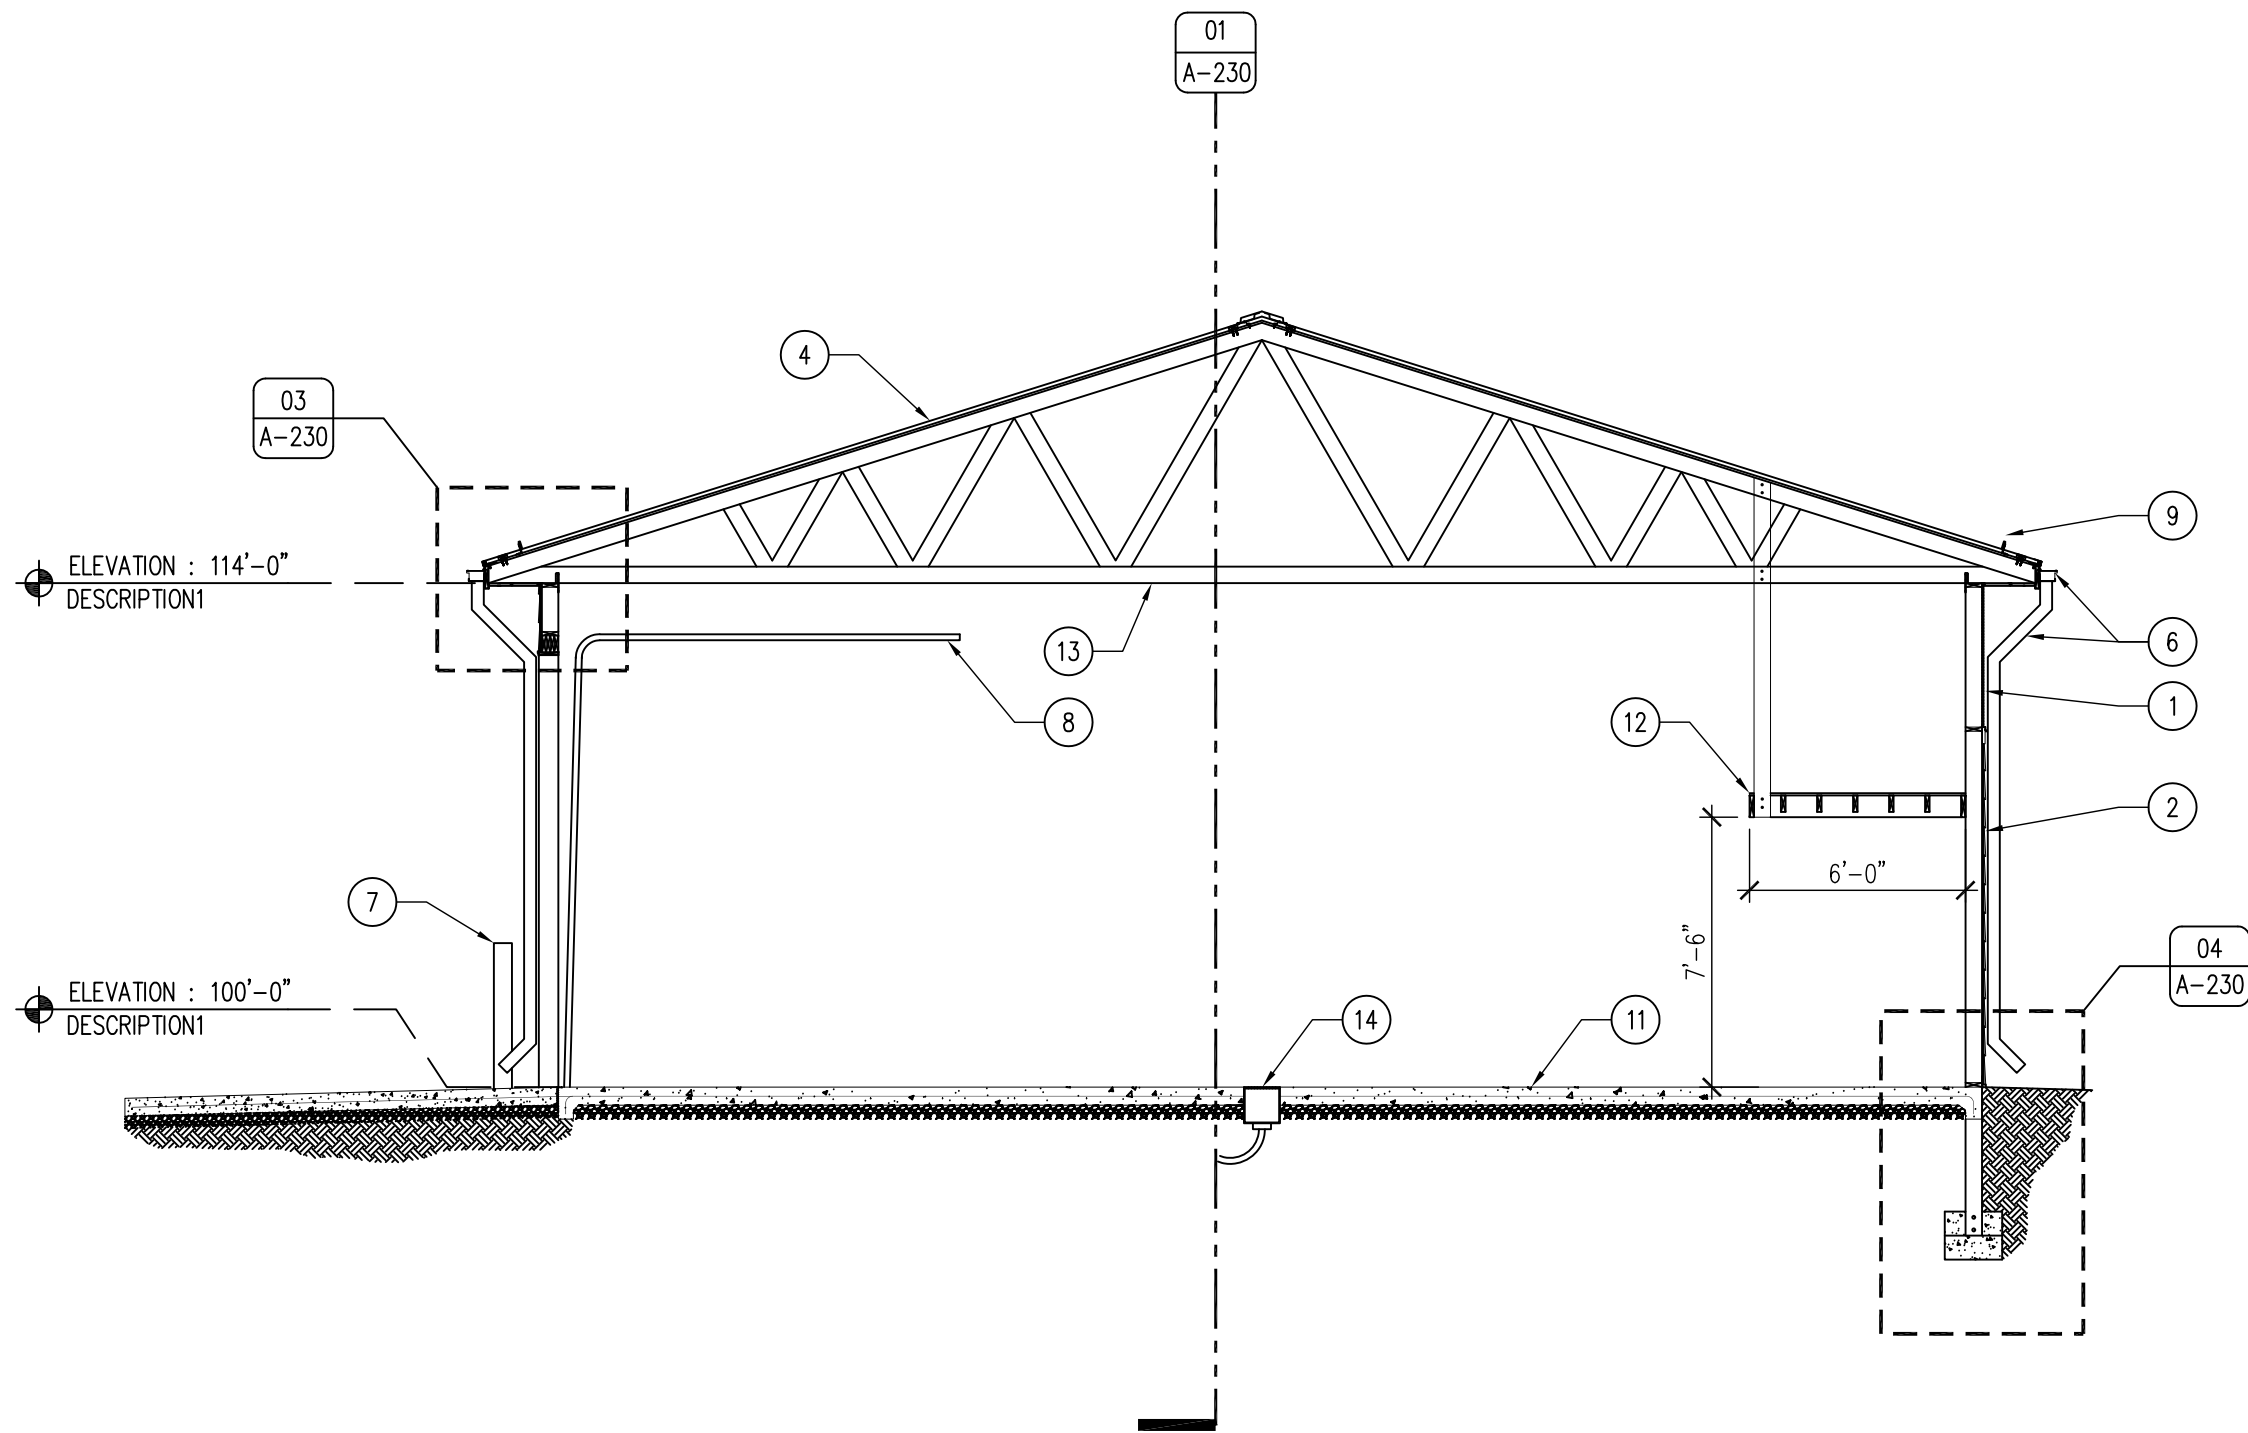

02 BUILDING SECTION  
SCALE: 3/16" = 1'-0"

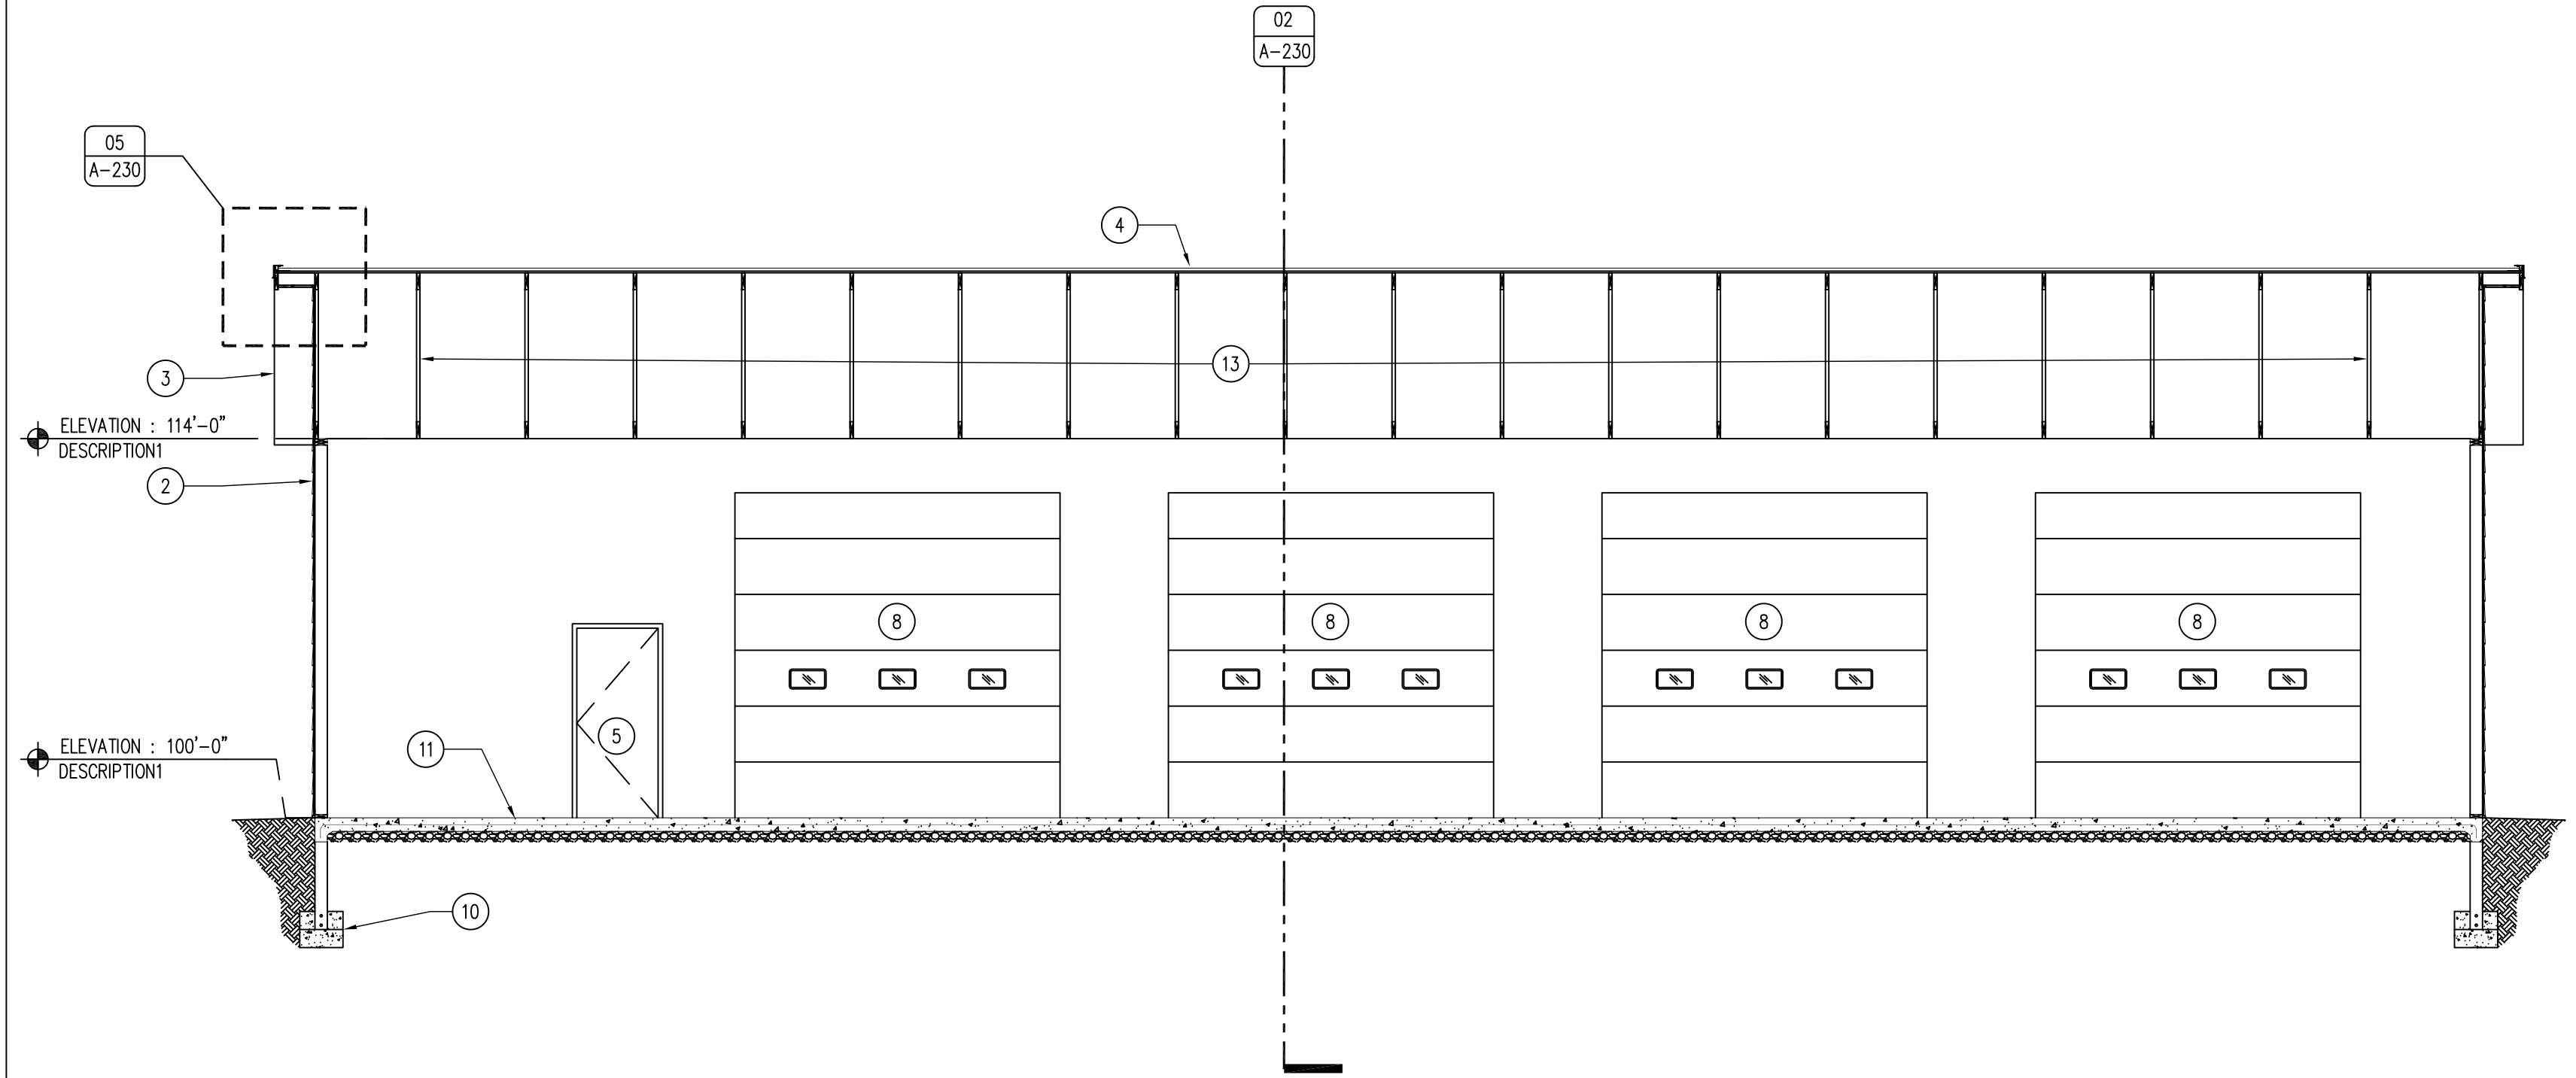

01 BUILDING SECTION  
SCALE: 3/16" = 1'-0"

#### KEYNOTES

- POLYCARBONATE WINDOW LIGHT, 48" TALL X ENTIRE LENGTH OF BUILDING, BY BUILDING MANUFACTURER.
- POST-FRAME BUILDING WITH 26 GAUGE METAL SALES PRO-PANEL II SIDING, COLOR TBD, SUBMIT SAMPLES.
- SOFFIT AND FASCIA METAL PANEL, COLOR TO MATCH ROOF.
- 24 GAUGE PAC-CLAD SNAP-CLAD METAL ROOF WITH STRIATIONS OVER 2X PURLINS BY BUILDING MANUFACTURER. COLOR TO BE DARK BRONZE.
- DOOR AS SCHEDULED, REFER TO SHEET A-600.
- REAR OF BUILDING TO RECEIVE 48" POLYCARBONATE WINDOW ACROSS ENTIRE LENGTH OF BUILDING.
- STEEL TRAFFIC BOLLARD WITH PLASTIC COVER SLEEVE, REFER TO DETAIL 02/A-202.
- INSULATED OVERHEAD GARAGE DOOR WITH THREE SAFETY LIGHTS, REFER TO DOOR SCHEDULE SHEET A-600.
- METAL SNOW GUARD BARS OF BOTH EAVES, ENTIRE LENGTH OF BUILDING, COLOR TO MATCH ROOF.
- POST-FRAME FOOTING, PER BUILDING MANUFACTURER.
- 6" CONCRETE BUILDING SLAB WITH 4" SUBBASE, #4 REBAR 24" O.C. BOTH DIRECTIONS, TURN DOWN SLAB PER BUILDING MANUFACTURER'S RECOMMENDATIONS.
- 6'-0" DEEP X LENGTH OF BUILDING, SUSPENDED LOFT, TO BE DESIGNED BY BUILDING MANUFACTURER TO HOLD 100 PSF.
- BUILDING TRUSS PER BUILDING MANUFACTURER, SPACING FOR DEMONSTRATION ONLY.
- TRENCH DRAIN, REFER TO PLUMBING DRAWINGS.
- 2X FASCIA WITH DARK BRONZE METAL FLASHING WRAP.
- SIMPSON TRUSS CLIP.
- Drip-EDGE, COLOR TO MATCH ADJACENT MATERIAL.
- NOT USED.
- 2X OUTRIGGER, EXTEND 18" FOR OVERHANG, PER BUILDING MANUFACTURER.
- ROOF RAKE TRIM, PER ROOF MANUFACTURER.

#### GENERAL NOTES

- REFER TO FINISH & DOOR SCHEDULE, SHEET A-600.
- REFER TO INDEX SHEET FOR WALL TYPES, A-002.
- REFER TO MECHANICAL, ELECTRICAL, PLUMBING SHEETS FOR MORE INFORMATION.
- FIELD VERIFY ALL DIMENSIONS PRIOR TO CONSTRUCTION.
- THIS BUILDING SHALL BE PRE-ENGINEERED BY BUILDING SUPPLIER.

CONSULTANT:

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#### BUILDING SECTIONS

NEW OFFICE & STORAGE BUILDING FOR:

**GREEN VALLEY STATE PARK**

UNION COUNTY, IOWA  
1480 130TH STREET

NO. BY DATE REVISION

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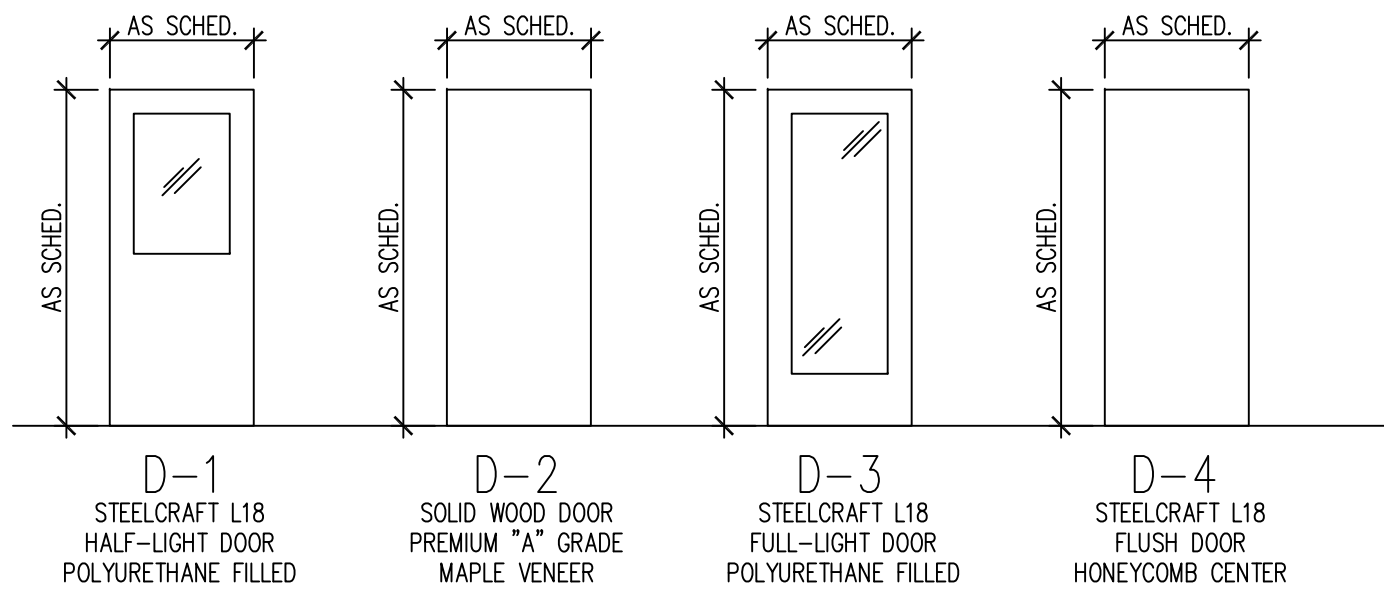
07.29.2015

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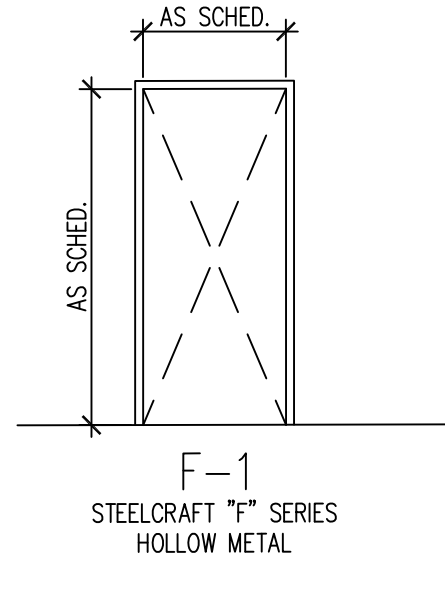
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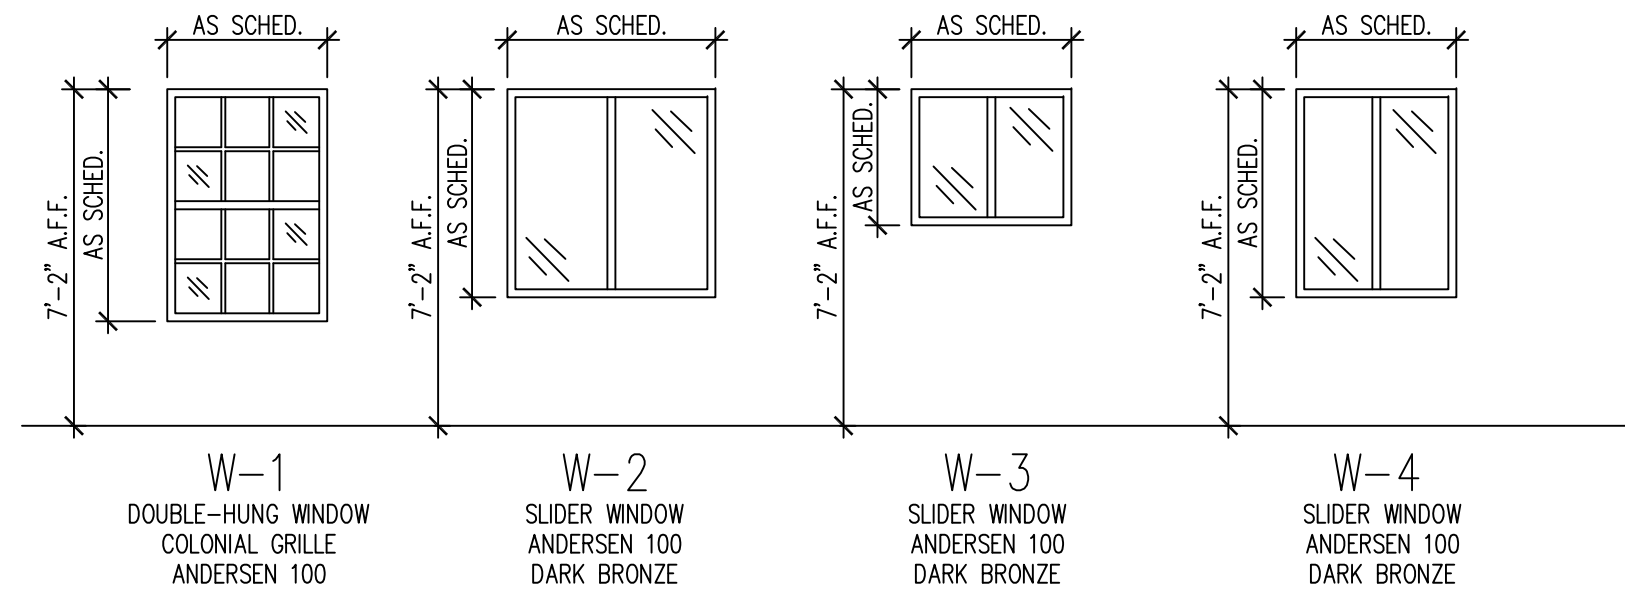
## DOOR TYPES



## FRAME TYPES



## WINDOW TYPES



## FINISH SCHEDULE

ROOM #	ROOM NAME	FLOORING	BASE	NORTH WALL FINISH	EAST WALL FINISH	SOUTH WALL FINISH	WEST WALL FINISH	CEILING	NOTES
100	VESTIBULE	CONC-2	WB-1	PNT-1	PNT-1	PNT-1	PNT-2	GYP-1	-
101	OPEN OFFICE	CPT-1	WB-1	PNT-1	PNT-1	PNT-1	PNT-2	ACT-1	-
102	CORRIDOR	CONC-2	WB-1	PNT-1	PNT-1	PNT-1	PNT-2	ACT-1	-
104	RESTROOM	CONC-2	RB-1	PNT-1	PNT-1	PNT-1	PNT-2	GYP-1	-
105	CLOSET	CONC-2	WB-1	PNT-1	PNT-1	PNT-1	PNT-1	GYP-1	-
106	MEETING ROOM	CONC-2	WB-1	PNT-1	PNT-1	PNT-1	PNT-2	ACT-1	-
107	MECHANICAL	CONC-1	RB-1	PNT-1	PNT-1	PNT-1	PNT-1	OPEN	-
108	HEATED BAYS	CONC-1	-	ST-1	ST-1	ST-1	ST-1	ST-1	29 GAUGE STEEL LINER PANEL WALLS & CEILING
200	STORAGE	CONC-1	-	-	-	-	-	OPEN	-

## FINISH SCHEDULE

HARDWARE SET NO. 1 - DOORS: 100A			
3 EA. HINGES	FB8179 4 1/2 X 4 1/2		
1 EA. STORE LOCKSET	N660P (ATHENS)		
1 EA. FLOOR STOP	FS 444		
3 EA. PERIMETER SEALS	BLACK GASKET		
1 EA. THRESHOLD SEAL	BLACK BROOM TYPE		
1 EA. ADA THRESHOLD PLATE	LON 4111		
1 EA. CLOSER			
HARDWARE SET NO. 2 - DOORS: 104			
3 EA. HINGES	FB8179 4 1/2 X 4 1/2		
1 EA. PRIVACY LOCKSET	N40DS (ATHENS)		
1 EA. FLOOR STOP	FS444		
3 EA. SILENCERS	SR66 (BLACK)		
HARDWARE SET NO. 3 - DOORS: 107, 105			
3 EA. HINGES	FB8179 4 1/2 X 4 1/2		
1 EA. STOREROOM LOCKSET	N80PD (ATHENS)		
1 EA. FLOOR STOP	FS444		
3 EA. SILENCERS	SR66 (BLACK)		
HARDWARE SET NO. 4 - DOORS: 102			
3 EA. HINGES	FB8179 4 1/2 X 4 1/2		
1 EA. PASSAGE	ND10 (ATHENS)		
1 EA. FLOOR STOP	FS 444		
3 EA. SILENCERS	SR66 (BLACK)		
HARDWARE SET NO. 5 - DOORS: 100B, 101, 106, 108A, 200A			
3 EA. HINGES	FB8179 4 1/2 X 4 1/2		
1 EA. ENTRANCE LOCKSET	N50PD (ATHENS)		
1 EA. FLOOR STOP	FS 444		
3 EA. PERIMETER SEALS	BLACK GASKET		
1 EA. THRESHOLD SEAL	BLACK BROOM TYPE		
1 EA. ADA THRESHOLD PLATE	LON 4111		
1 EA. CLOSER			

## FINISH SCHEDULE

FINISH MARK	MATERIAL	MANUFACTURER INFO		DIMENSION	COLOR	FINISH	COMMENTS
		COMPANY NAME	PRODUCT NUMBER				
FLOOR FINISH							
CONC-1	SEALED CONCRETE	-	-	-	-	-	-
CONC-2	STAIN, SEAL & WAXED CONCRETE	SCOFIELD	LITHOCHROME CHEMSTAIN	-	DARK WALNUT CS-14	HIGH GLOSS	2X WAXED
CPT-1	NYLON CARPET TILE	SHAW	59523-23750	2'X2'	DRIFTWOOD	REED	GRAPHIC NATURE COLLECTION
RB-1	RUBBER BASE	JOHNSONITE	-	4"	TBD	-	GARAGE, MECH. & BATHROOM AREAS
WB-1	HARD MAPLE BASE	-	-	4"	CLEAR	POLY	-
CEILING FINISH							
ACT-1	ACOUSTICAL CLG TILE	ARMSTRONG	1911 TEGULAR	24"X 24"	WHITE	ULTIMA	PRELUDE XL 15/16" SUSP. SYSTEM
GYP-1	GYPSUM CEILING	-	-	-	WHITE	PNT-1	-
ST-1	STEEL LINER PANEL	-	-	29 GAUGE	WHITE	MANUF.	STORM PANEL
INTERIOR FINISH							
PNT-1	INTERIOR PAINT	SHERWIN WILLIAMS	DURATION	-	SW6106 - KILIM BEIGE	PEARL	COMMON
PNT-2	INTERIOR PAINT	SHERWIN WILLIAMS	DURATION	-	SW6108 - LATTE	PEARL	ACCENT
RW-1	ESSENTIAL BOARD	REWALL	-	1/2"	-	ORANGE PEEL	FINISH WITH HEAVY ORANGE PEEL
ST-1	STEEL LINER PANEL	-	-	29 GAUGE	WHITE	MANUF.	HEATED BAYS
MILLWORK / WOOD FINISH							
WD-1	MAPLE VENEER PLYWOOD	-	-	-	TBD	CLEAR	ALL WOOD/MILLWORK - SUBMIT SAMPLES
WD-2	3/4" SOLID HARD MAPLE	-	-	3/4" X 4"	CLEAR	CLEAR	ALL WOOD/MILLWORK - SUBMIT SAMPLES
SS-1	CORIAN	DUPONT	-	-	LAVA ROCK	MANUF.	ALL WOOD/MILLWORK - SUBMIT SAMPLES
PL-1	PLASTIC LAMINATE	-	-	-	TBD	MANUF.	ALL WOOD/MILLWORK - SUBMIT SAMPLES
EXTERIOR FINISH							
SR-1	STANDING SEAM METAL ROOF	PAC-CLAD	SNAP-LOC	24 GA	DARK BRONZE	MANUF.	-
CB-1	CEMENT BOARD SIDING	JAMES HARDIE	CEDARMILL COLORPLUS	8.25"	TIMBER BARK	MANUF.	-
SD-1	STEEL SIDING	METAL SALES MANUFACTURING CO.	PRO-PANEL II	26 GA	TBD	MANUF.	SUBMIT SAMPLES

## KEYNOTES

- REWALL BOARD.
- 6" STRUCTURAL METAL STUD.
- DOOR AS SCHEDULED.
- CONTINUOUS SEALANT AND BACKER ROD
- MTL. BOX STUD HEADER
- ADA COMPLIANT, THRESHOLD.
- WOOD BLOCKING AS REQUIRED.
- R-15 MINIMUM BATT INSULATION.
- DOOR FRAME, AS SCHEDULED.
- 3 5/8" METAL STUD.
- SOUND BATT INSULATION.
- SIP WALL SYSTEM AS SCHEDULED.
- 2X PER MANUF. RECOMMENDATION.
- SIP HEADER, PER MANUF. RECOMMENDATION.
- BOX STUD HEADER.
- WINDOW AS SCHEDULED.
- HARD MAPLE TRIM / SILL, WD-1.
- CEMENT BOARD SIDING, AS SCHEDULED.
- CEMENT BOARD TRIM, AS SCHEDULED.
- BRUSH TYPE GASKET FOR EXTERIOR DOORS.
- CONCRETE SLAB.
- QUARTZ COUNTER TOP, Q2-1, ANGLE BRACE AS REQUIRED.
- METAL FLASHING W/ SEALANT, AS REQUIRED.
- CONTINUOUS VAPOR BARRIER.
- WATER RESISTANT PLYWOOD SHEATHING.
- STEEL SIDING AS SCHEDULED.
- POST-FRAME BUILDING BY MANUFACTURER.

## GENERAL NOTES

- WOOD DOORS TO BE CUSTOM GRADE "A" MAPLE WOOD VENEER SOLID CORE. FINISH TO BE APPROVED. ALL HARDWARE MODEL NUMBERS BASED ON SCHLAGE "ND-SERIES" LOCKSETS AND "VES" HARDWARE.
- HARDWARE FINISH TO BE : "OIL RUBBED BRONZE (613)". UNLESS NOTED OTHERWISE.
- WINDOW BASIS OF DESIGN, ANDERSEN 100 SERIES. REFER TO MANUFACTURER'S INSTRUCTIONS.
- CHECK ALL QUANTITIES, DIMENSIONS AND FINISHES BEFORE ORDERING.

## DOOR SCHEDULE

DOOR NUMBER	DOOR			TYPE	GLASS	FINISH	FRAME				FIRE RATING LABEL	HARDWARE		COMMENTS	
	DIMENSION						DETAILS			TYPE		FINISH	SET #		KEYSIDE ROOM NUMBER
	WIDTH	HEIGHT	THICK.				HEAD	JAMB	THRESHOLD						
100A	3'-0"	7'-0"	1 3/4"	D-3	MANUF.	MANUF.	07/A-600	04/A-600	01/A-600	F-1	MANUF.	1	NA	EXT. STEELCRAFT "L" SERIES – FULL LIGHT	
100B	3'-0"	7'-0"	1 3/4"	D-3	MANUF.	MANUF.	07/A-600	04/A-600	01/A-600	F-1	MANUF.	5	100	EXT. STEELCRAFT "L" SERIES – FULL LIGHT	
101	3'-0"	7'-0"	1 3/4"	D-2	MANUF.	CLEAR	10/A-600	11/A-600	–	F-1	MANUF.	5	102	PREMIUM GRADE "A" MAPLE	
102	3'-0"	7'-0"	1 3/4"	D-1	MANUF.	MANUF.	07/A-600	04/A-600	01/A-600	F-1	MANUF.	4	NA	EXT. STEELCRAFT "L" SERIES – HALF LIGHT	
104	3'-0"	7'-0"	1 3/4"	D-2	MANUF.	CLEAR	10/A-600	11/A-600	–	F-1	MANUF.	2	102	PREMIUM GRADE "A" MAPLE	
105	10'-0"	7'-0"	1 3/4"	D-2	MANUF.	CLEAR	–	–	–	F-1	MANUF.	3	106	PREMIUM GRADE "A" MAPLE	
106	3'-0"	7'-0"	1 3/4"	D-1	MANUF.	CLEAR	10/A-600	11/A-600	–	F-1	MANUF.	5	NA	EXT. STEELCRAFT "L" SERIES – HALF LIGHT	
107	3'-0"	7'-0"	1 3/4"	D-2	MANUF.	MANUF.	07/A-600	04/A-600	01/A-600	F-1	MANUF.	3	106	PREMIUM GRADE "A" MAPLE	
108A	3'-0"	7'-0"	1 3/4"	D-1	MANUF.	MANUF.	07/A-600	04/A-600	01/A-600	F-1	MANUF.	5	NA	EXT. STEELCRAFT "L" SERIES – HALF LIGHT	
108B	12'-0"	12'-0"	–	–	MANUF.	MANUF.	–	–	–	–	–	–	–	R-6 GARAGE DOORS W/ SAFETY WINDOWS	
108C	12'-0"	12'-0"	–	–	MANUF.	MANUF.	–	–	–	–	–	–	–	R-6 GARAGE DOORS W/ SAFETY WINDOWS	
108D	12'-0"	12'-0"	–	–	MANUF.	MANUF.	–	–	–	–	–	–	–	R-6 GARAGE DOORS W/ SAFETY WINDOWS	
200A	3'-0"	7'-0"	1 3/4"	D-4	MANUF.	MANUF.	08/A-600	05/A-600	SIM. – 01/A-600	F-1	MANUF.	5	NA	EXT. STEELCRAFT "L" SERIES – FLUSH DOOR	
200B	12'-0"	12'-0"	–	–	MANUF.	MANUF.	–	–	–	–	–	–	–	R-6 GARAGE DOORS W/ SAFETY WINDOWS	
200C	12'-0"	12'-0"	–	–	MANUF.	MANUF.	–	–	–	–	–	–	–	R-6 GARAGE DOORS W/ SAFETY WINDOWS	
200D	12'-0"	12'-0"	–	–	MANUF.	MANUF.	–	–	–	–	–	–	–	R-6 GARAGE DOORS W/ SAFETY WINDOWS	
200E	12'-0"	12'-0"	–	–	MANUF.	MANUF.	–	–	–	–	–	–	–	R-6 GARAGE DOORS W/ SAFETY WINDOWS	

## WINDOW SCHEDULE

WINDOW						FRAME					QUANTITY	COMMENTS
WINDOW TYPE	DIMENSION		TYPE	GLASS	FINISH	DETAILS			TYPE	FINISH		
	WIDTH	HEIGHT				HEAD	JAMB	SILL				
W-1	36"	54"	1	MANUF.	MANUF.	09/A-600	06/A-600	03/A-600	-	DARK BRONZE	2	ANDERSEN 100 - DOUBLE HUNG WITH COLONIAL GRILLE
W-2	48"	48"	1	MANUF.	MANUF.	09/A-600	06/A-600	12/A-600	-	DARK BRONZE	1	ANDERSEN 100 - SLIDER WINDOWS
W-3	36"	30"	1	MANUF.	MANUF.	09/A-600	06/A-600	03/A-600	-	DARK BRONZE	7	ANDERSEN 100 - SLIDER WINDOWS
W-4	36"	48"	1	MANUF.	MANUF.	09/A-600	06/A-600	03/A-600	-	DARK BRONZE	6	ANDERSEN 100 - SLIDER WINDOWS

## TRANSACTION WINDOW

SCALE: 1 1/2" = 1'-0"

## DOOR DETAIL - JAMB

SCALE: 1 1/2" = 1'-0"

## DOOR DETAIL - HEADER

SCALE: 1 1/2" = 1'-0"

## WINDOW DETAIL - HEADER

SCALE: 3" = 1'-0"

## DOOR DETAIL - HEADER

SCALE: 3" = 1'-0"

## DOOR DETAIL - HEADER

SCALE: 3" = 1'-0"

## WINDOW DETAIL - JAMB

SCALE: 3" = 1'-0"

## DOOR DETAIL - JAMB

SCALE: 3" = 1'-0"

## DOOR DETAIL - JAMB

SCALE: 3" = 1'-0"

## WINDOW DETAIL - SILL

SCALE: 3" = 1'-0"

## MILLWORK PROFILE

SCALE: 6" = 1'-0"

## DOOR DETAIL - THRESHOLD

SCALE: 3" = 1'-0"

CONSULTANT

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NATURAL RESOURCESENGINEERING SERVICES - WALLACE BUILDING  
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FINISH, DOOR &amp; WINDOW SCHEDULES

NEW OFFICE &amp; STORAGE BUILDING FOR:

GREEN VALLEY STATE PARK

UNION COUNTY, IOWA

1480 130TH STREET

NO. BY DATE REVISION

DRAWN BY: PROJECT NUMBER:  
15-04-88-01CHK'D BY: DATE:  
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SHEET NO:

A-600



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NOTE: NOT ALL SYMBOLS APPLY TO THIS PROJECT.

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NOTE: NOT ALL ABBREVIATIONS APPLY TO THIS PROJECT.

INCORPORATE INTO INSTALLATION MECHANICAL SPECIFICATIONS, DRAWINGS, STATE AND LOCAL CODES, AND OTHER APPLICABLE REQUIREMENTS.

ON COMPLETION OF THE INSTALLATION MECHANICAL CONTRACTOR SHALL COOPERATE

PIPING SHALL NOT BLOCK CLEARANCES TO MECHANICAL EQUIPMENT. INSTALLING

DRAWING PLANS, SCHEMATICS, AND DIAGRAMS INDICATE GENERAL LOCATION AND

ALL DUCT DIMENSIONS LISTED ARE INTERIOR FREE AREA DUCT DIMENSIONS AND DO NOT

DRAWING PLANS, SCHEMATICS, AND DIAGRAMS INDICATE GENERAL LOCATION AND


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CB

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100

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- GENERAL NOTES
1. REFER TO M0.0 FOR GENERAL NOTES.
  2. REFER TO 1/M2.0 FOR DUCTWORK DETAIL.

RADIANT FLOOR HEATING SYSTEM IN THIS AREA.  
(2 ZONES - SHOP & OFFICE)

45 DEG. WEATHERHOOD FOR  
EXHAUST FAN PROVIDED BY FAN  
MFR.

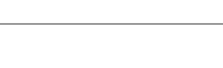REFER TO 7/M2.0 FOR PROPELLER  
EXHAUST FAN DETAIL. MOUNT AS HIGH AS  
POSSIBLE BELOW CEILING.

MOD PROVIDED WITH FAN.  
FAN TO BE CONTROLLED BY  
WALL SWITCH PROVIDED  
WITH UNIT.

PROVIDE U.C.  
UNDER DOOR

RADIANT SYSTEM 2

RADIANT SYSTEM 1

PROVIDE U.C.  
UNDER DOOR

MOD

REFER TO 8/M2.0 FOR INTAKE LOUVER  
DETAIL.  
36"W X 30"H INTAKE LOUVER.  
BOTTOM OF LOUVER AT APPROX. 8' A.F.F.  
COORDINATE EXACT LOCATION WITH  
ARCHITECT.

CUH  
1

CD-1  
6/75

CD-1  
8/205

CD-1  
8/200

RG-2  
6X6

RG-1

RCP  
1

EF  
1

REF

REF

12x12

6X6

6X6

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6X6

6X6

SIZE/ROUTE REF  
LINES PER MFR  
RECOMMENDATIONS.  
(TYP.)

IN LIEU OF MECHANICAL VENTILATION, NATURAL VENTILATION  
BY OPERABLE WINDOWS WAS USED BASED ON SECTION 402  
OF IMC 2012 FOR THE BUILDING.


SG-1  
6X6/50

3" O.A./COMB. AIR UP TO  
ROOF. REFER TO 3/M2.0  
FOR CONCENTRIC VENT  
DETAIL.

TERMINATE WITH MFR  
SUPPLIED RECTANGULAR WALL  
HOOD.

MOUNT CU ON CABIN EXTERIOR WALL.  
REFER TO DETAIL 9/M2.0

EXTERIOR WALL PENETRATIONS TO BE  
SEALED WATERTIGHT.

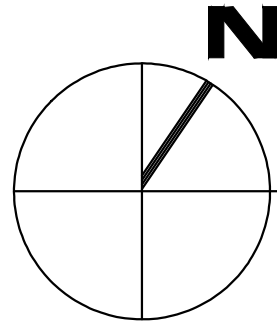

## OFFICE FLOOR PLAN - MECHANICAL

SCALE: 1/4" = 1'-0"

OFFICE FLOOR PLAN - MECHANICAL

NEW OFFICE & STORAGE BUILDING FOR:  
**GREEN VALLEY STATE PARK**

1480 130TH STREET  
UNION COUNTY, IOWA

NO. BY REVISION

DATE

DATE

DRAWN BY: PROJECT NUMBER:

CB 15-04-88-01

CHK'D BY: DATE:

JC 07.29.2015

SHEET No:

**M1.0**

CONSULTANT:


**KCL Engineering**  
218 12th St.  
West Des Moines, Iowa 50265  
info@kclengineering.com  
515.724.7938

**IOWA DEPARTMENT OF  
NATURAL RESOURCES**



ENGINEERING SERVICES - WALLACE BUILDING  
502 E. 9TH ST., DES MOINES, IA 50319-0034  
P: 515.725.8200  
F: 515.725.8202






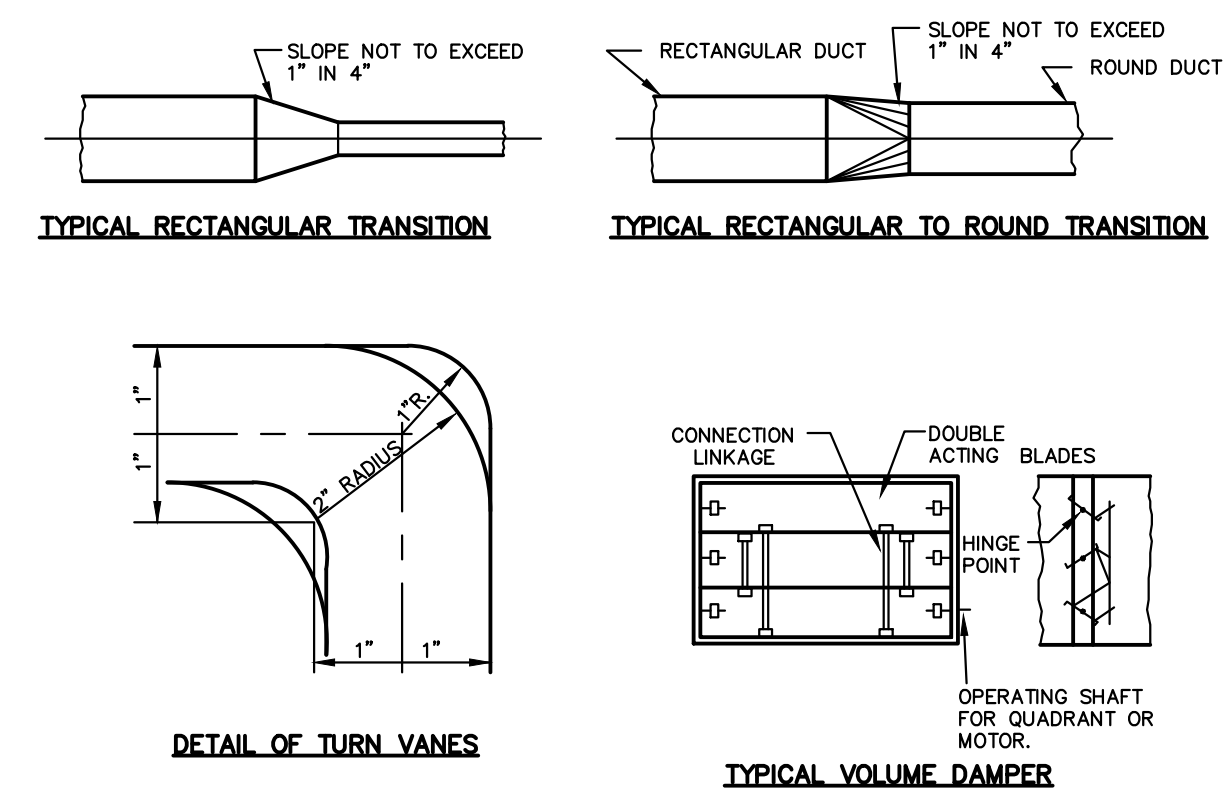


## 1 DETAILS OF THE LOW VELOCITY DUCT LAYOUT

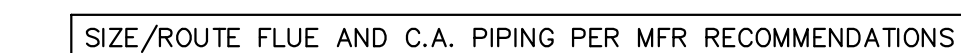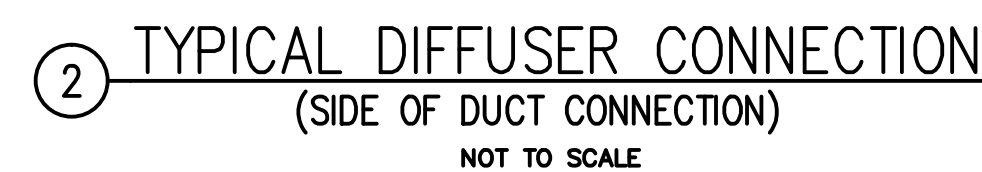

### 3 CONCENTRIC ROOF TERMINATION

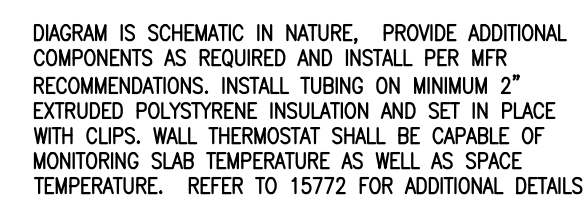

4 IN-FLOOR RADIANT MULTI-ZONE SYSTEM DETAIL  
NOT TO SCALE

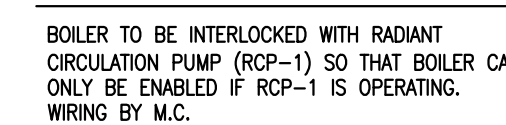


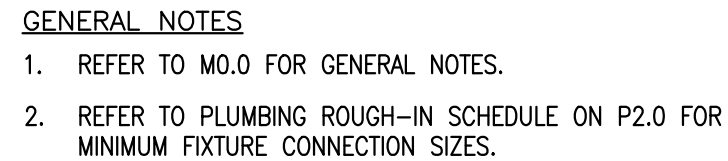
6 RADIANT HEATING PIPING DIAGRAM  
NOT TO SCALE











NO.	BY DATE	REVISION
DRAWN BY: CB		PROJECT NO: 15-04-8
CHK'D BY: JC		DATE: 07.29.2
SHEET No:		

**CONSULTANT:**


**KCL Engineering**

218 12 5th St.  
West Des Moines, Iowa 50265

info@kclengineering.com  
515.724.7938





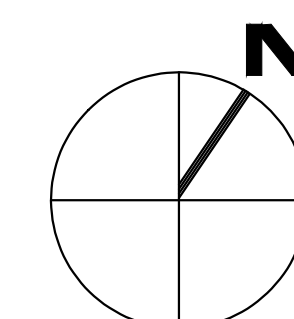

SCALE:  $1/4" = 1'-0"$

- CONSULTANT:

ENGINEERING SERVICES - WALLACE BUILDING  
502 E. 9TH ST., DES MOINES, IA 50319-0034  
P: 515.725.8200  
F: 515.725.8202



SHEET No:

P1.0



GENERAL NOTES

1. REFER TO M0.0 FOR GENERAL NOTES.

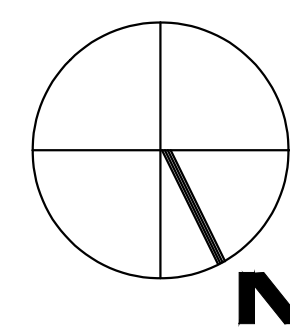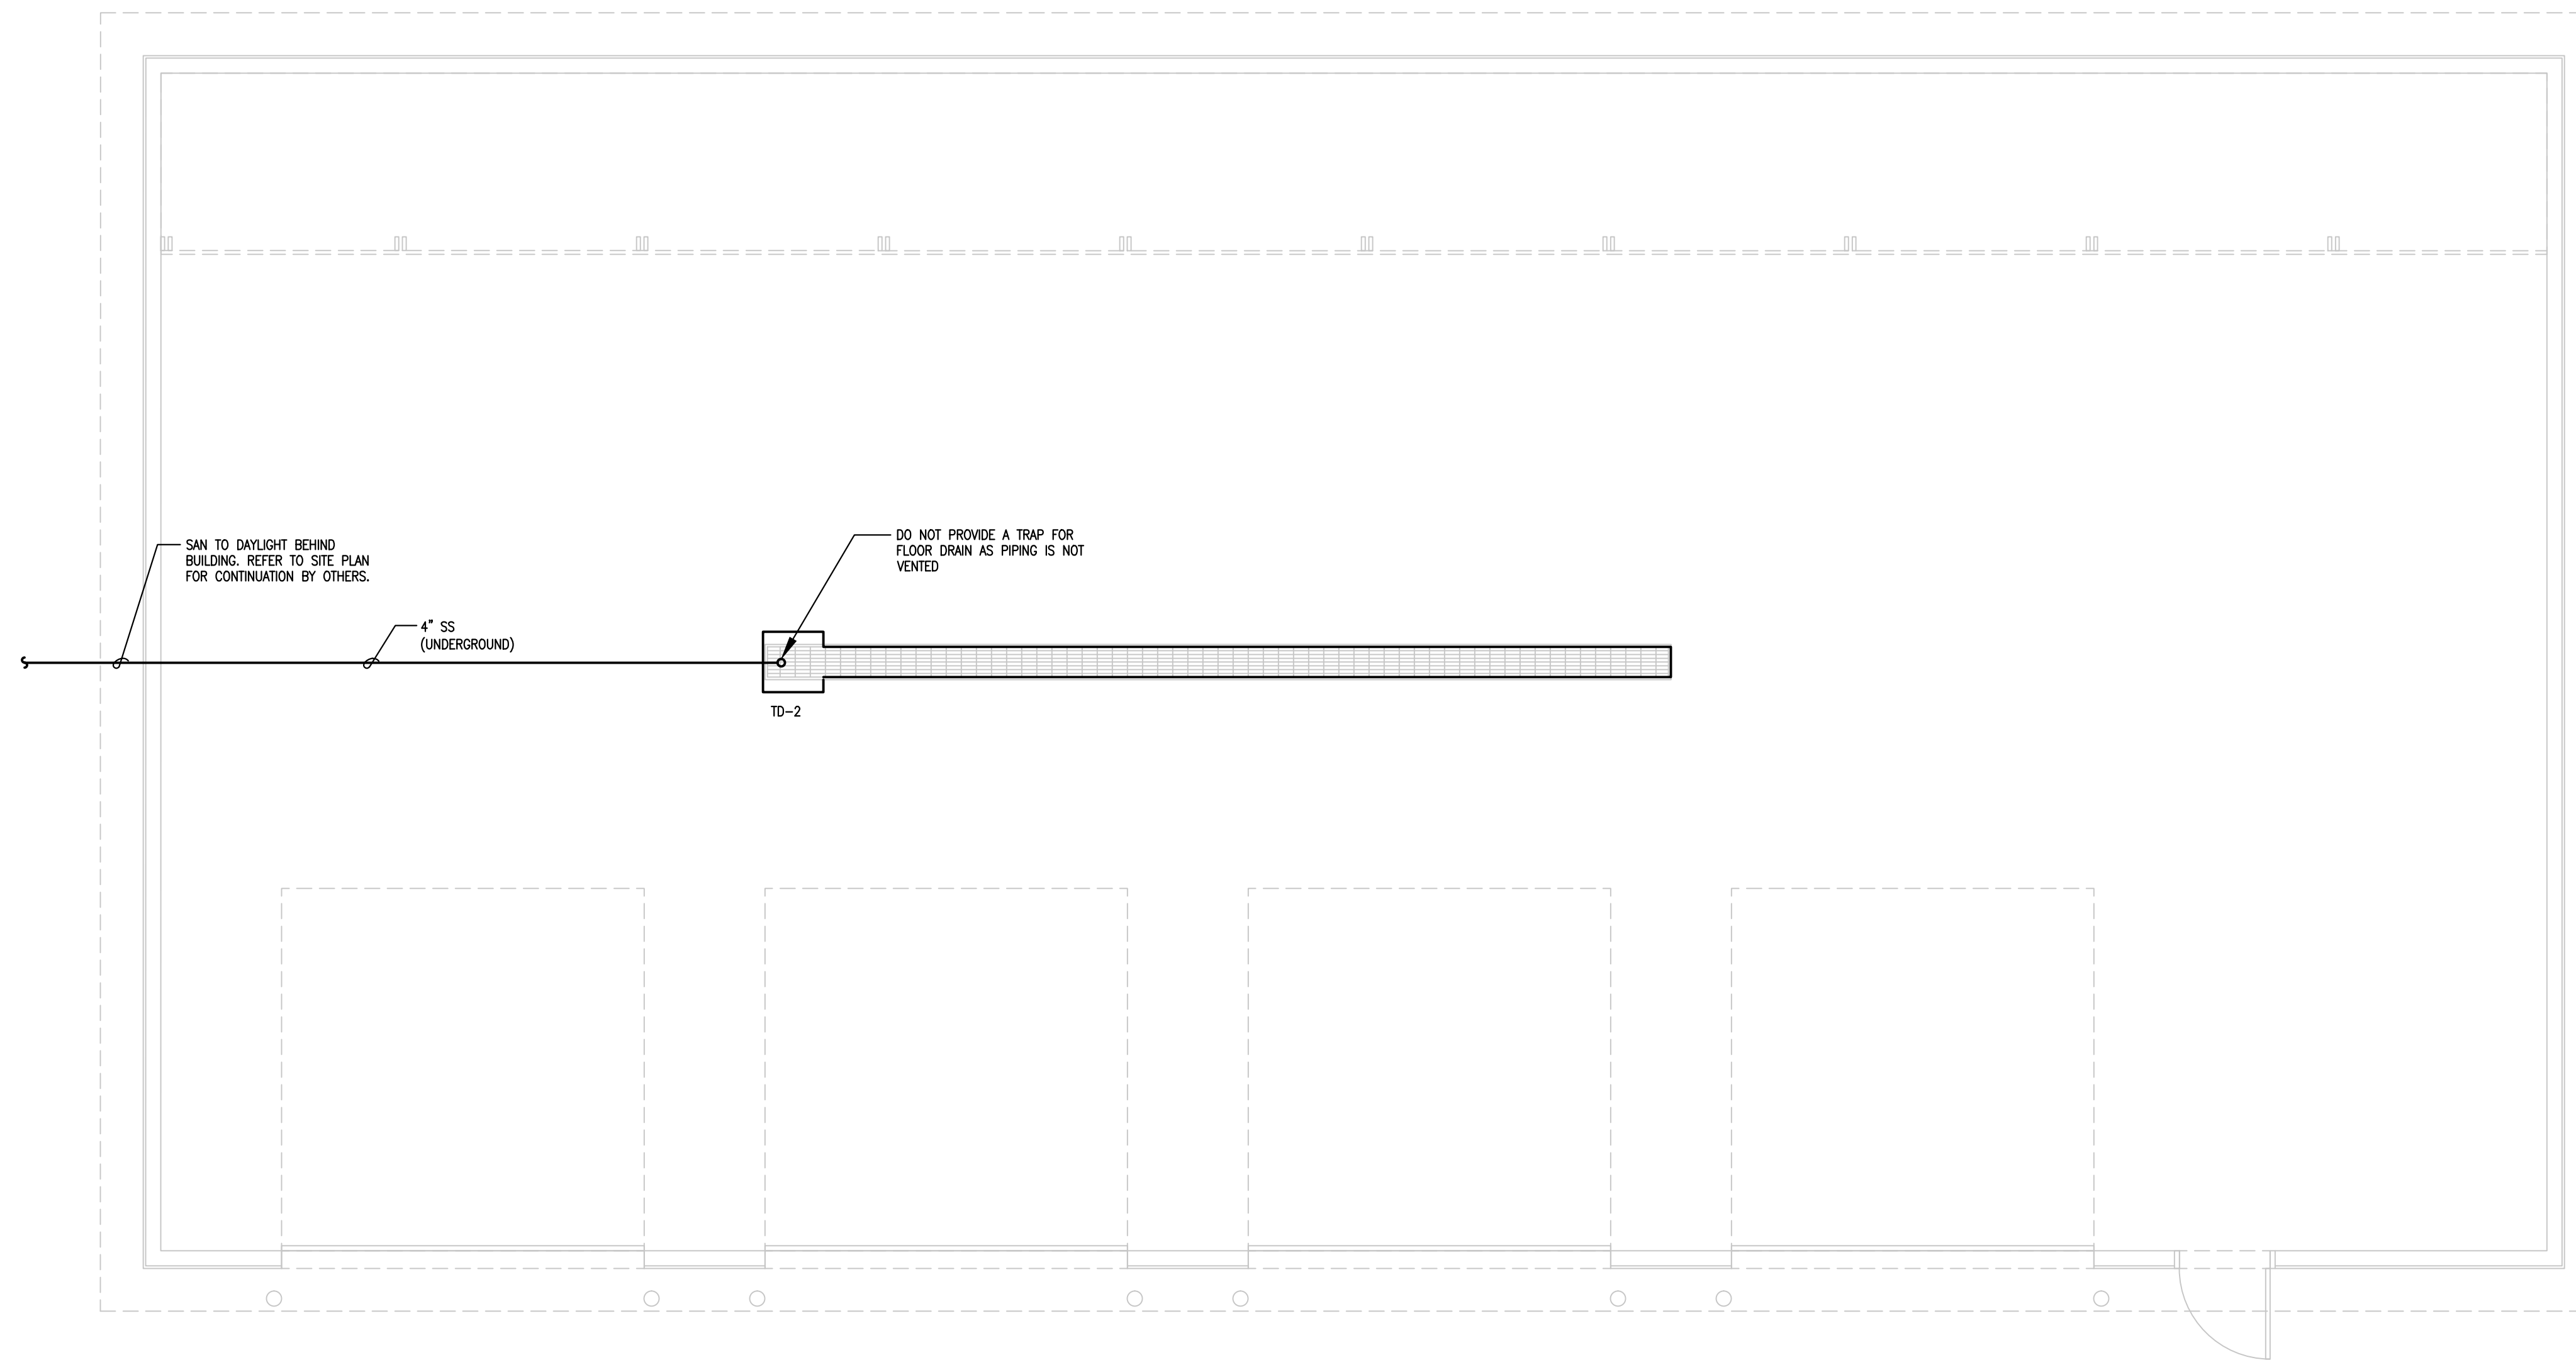

## STORAGE FLOOR PLAN - PLUMBING

SCALE:  $1/4'' = 1'-0''$

## STORAGE FLOOR PLAN - PLUMBING

NEW OFFICE & STORAGE BUILDING FOR:  
**GREEN VALLEY STATE PARK**

1480 130TH STREET  
UNION COUNTY, IOWA

## IOWA DEPARTMENT OF NATURAL RESOURCES

ENGINEERING SERVICES - WALLACE BUILDING  
502 E. 9TH ST., DES MOINES, IA 50319-0034  
P: 515.725.8200  
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CONSULTANT:

**KCL Engineering**  
218 12 5th St.  
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info@kclengineering.com  
515.724.7938

NO.	BY DATE	REVISION
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DRAWN BY:	PROJECT NUMBER:
CB	15-04-88-01

CHK'D BY:	DATE:
JC	07.29.2015

SHEET No:

NO: **P1.1**



PLUMBING FIXTURE SCHEDULE

REFERENCE	MFR	MODEL	DESCRIPTION	TRIM
BFP-1	WATTS	009/909	BACKFLOW PREVENTOR - REDUCED PRESSURE ZONE ASSEMBLY, BRONZE BODY CONSTRUCTION OR FDA APPROVED EPOXY COATED CAST IRON. INTERNAL PRESSURE RELIEF VALVE BETWEEN TWO CHECK VALVES. REPLACABLE SILICONE SEAT DISCS. PROVIDE WITH AIR GAP DRAIN FITTING. SERVICE OF ALL COMPONENTS SHALL BE THROUGH SINGLE ACCESS BRONZE COVER WITH STAINLESS BOLTS. COMPLY WITH AWWA AND ASSE.	PROVIDE FLOOD CONTROL SYSTEM, VALVE WITH SOLENOID AND ALL REQUIRED WIRING PER DETAIL 1/P2.0
FCO-1	ZURN	Z1400	ADJUSTABLE FLOOR CLEANOUT, CAST IRON BODY, TAPERED THREAD PLUG AND ROUND NICKEL BRONZE SCORIATED CAST IRON HEAVY-DUTY SECURED TOP, ADJUSTABLE TO FINISHED FLOOR. OUTLET SIZE AS NOTED ON DRAWINGS.	NA
FD-1	ZURN	ZB-415-6B-P-ZB	CAST IRON BODY FLOOR DRAIN, TYPE "B" 6" ROUND POLISHED NICKEL BRONZE STRAINER, DEEP SEAL TRAP. OUTLET SIZE AS NOTED ON DRAWINGS, MIN. 3".	NA
FD-2	ZURN	Z-415	CAST IRON BODY FLOOR DRAIN, TYPE "B" 8" ROUND POLISHED BRONZE STRAINER, DEEP SEAL TRAP. OUTLET SIZE AS NOTED ON DRAWINGS, MIN. 3".	NA
H-1	WOODFORD	MB67	FREEZELESS, WALL HYDRANT, BRASS VALVE BODY AND SEAT, STANDARD FINISH, NON-FERROUS METAL STEM, HIGH FLOW DOUBLE CHECK BACKFLOW PREVENTER, LOCKABLE COMPOSITE BOX W/COVER PLATE, 3/4" MALE HOSE THREAD, ASSE 1052 APPROVED AND IAPMO LISTED. INSTALL AT 18" ABOVE FINISH GRADE.	NA
H-2	WOODFORD	MODEL 24	WALL HYDRANT, BRASS VALVE BODY AND SEAT, STANDARD FINISH, NON-FERROUS METAL STEM, VACUUM BREAKER - ANTI-SIPHON, 3/4" MALE HOSE THREAD, ASSE 1011 APPROVED, CSA AND IAPMO LISTED. INSTALL AT 18" ABOVE FINISH GRADE.	NA
L-1	KOHLER	K-2210	UNDER COUNTER MOUNT VITREOUS CHINA LAVATORY, WITH OVERFLOW, PROVIDE WITH CLAMP ASSEMBLY, ADA COMPLIANT.	DELTA "21C" OR APPROVED EQUAL TWO HANDLE TYPE FAUCET, WITH METAL POP-UP AND TRAP, LEVER BLADE HANDLES. MAXIMUM FIXTURE FLOW TO BE 0.5 GPM. PROVIDE POWERS "LM495" POINT OF USE MIXING VALVE UNDER FIXTURE. MIXING VALVE MUST MEET ASSE 1070 AND IPC 2009 REQUIREMENTS. PROVIDE WITH 1/4 TURN, 3/8" BRASS STOPS. PROVIDE WITH TRUEBRO "LAV GUARD" CW/HW AND WASTE PIPE GUARDS AND ESCUTCHEONS.
OS-1	ROCKFORD	OST-5624-50	OIL/WATER SEPARATOR, ALL WELDED A36 1/4" STEEL, 25 GPM INTERMITTENT FLOW, 45 GALLON STATIC CAPACITY WITH 50 GALLON WASTE OIL STORAGE, 3" THREADED INLET/OUTLET AND 3" THREADED VENT CONNECTIONS (4), VISIBLE DOUBLE-WALL OUTSIDE TRAP SEAL, REMOVABLE FILTER SCREEN, NON-REMOVABLE SEPARATOR SCREENS, 3/8" NONSKID TREADPLATE COVER FOR VEHICLE TRAFFIC LOAD WITH HEAVY DUTY LEAKPROOF GASKET. PROVIDE WITH EXTENSION AS REQUIRED TO INSTALL UNIT FLUSH WITH GRADE.	NA
SH-1	KOHLER	K-12100	ADA ACRYLIC SHOWER MODULE, 36" L X 36" W AND 81" H, SHOWER DRAIN, FOLD UP SEAT, MOLDED-IN FLOOR PATTERN, INTEGRAL SOAP LEDGES AND "PIT" INSTALLATION OPTION, STAINLESS STEEL GRAB BARS. COORDINATE "PIT" INSTALLATION WITH FLOOR, PRIOR TO POURING SLAB.	POWERS "E710" OR APPROVED EQUAL THERMOSTATIC/PRESSURE SHOWER VALVE, 2.5 GPM FLOW, 1/2" IPS SUPPLY INLETS, CHECK STOPS AND INTEGRAL STRAINER. SYMMONS "H321-V" OR APPROVED EQUAL SHOWERHEAD, 2.5 GPM, 6" METAL HOSE AND 30" VERTICAL BAR, POLISHED CHROME, INTEGRAL VACUUM BREAKER. COORDINATE MOUNTING HEIGHTS WITH ARCHITECT.
SK-1	ELKAY	ELUHE3118	DOUBLE BOWL, UNDER COUNTER MOUNT, P-TRAP, BOWL. DIMENSIONS: 13.5" L X 16" W X 8" D, UNDERCOATED, BASKET STRAINER. VERIFY FINAL DIMENSIONS FROM ARCH ELEVATION AND MILWORK DRAWINGS.	DELTA "101LF-HDF" OR APPROVED EQUAL, BRASS CONSTRUCTION, CHROME-PLATED FINISH, SWING SPOUT FAUCET, 8" REACH, 1.5 GPM AERATOR, SINGLE LEVER HANDLE, SEPARATE SPRAY WASH, TWO HOLE SUPPLIES FAUCET. PROVIDE WITH 1/4 TURN, 3/8" BRASS STOPS.
SS-1	FIAT	L-1	WHITE MOLDED STONE HUNG LAUNDRY TUB, 18 1/2" L X 24" W X 13"D, DRAIN WITH STOPPER, 17 GAL. HOLDING CAPACITY, HEAVY GAUGE GALVANIZED STEEL BRACKET CAPABLE OF WITHSTANDING 600 LBS.	PROVIDE WITH CHROME PLATED BRASS DECK TYPE 4" CENTERSET FAUCET WITH 6 3/4" SERVING SPOUT THAT MOUNTS ON REAR DECK. PROVIDE FAUCET WITH HOSE ADAPTER AS REQUIRED FOR 3/4" MALE HOSE THREAD. PROVIDE WITH P-TRAP AND SUPPLY RISERS.
TD-1	ZURN	886-HD	TRAFFIC RATED TRENCH DRAIN CONSTRUCTED OF PRE-MANUFACTURED POLYETHYLENE TRENCH FORMING SYSTEM, 11.75" WIDE, 21" TOTAL LENGTH, PRE-SLOPED AT 1/8" PER FOOT, ROUNDED BOTTOM, INTERGAL DEFORMING GROOVES, STEEL SUPPORT RAILS AND ANCHORING STUDS, HEAVY DUTY CAST IRON GRATE H-20 RATED, INTERGAL 24 X 24 CATCH BASIN WITH EXTRA HEAVY DUTY GRATE AND REMOVABLE SEDIMENT BASKET.	NA
TD-2	ZURN	886-HD	TRAFFIC RATED TRENCH DRAIN CONSTRUCTED OF PRE-MANUFACTURED POLYETHYLENE TRENCH FORMING SYSTEM, 11.75" WIDE, 35" TOTAL LENGTH, PRE-SLOPED AT 1/8" PER FOOT, ROUNDED BOTTOM, INTERGAL DEFORMING GROOVES, STEEL SUPPORT RAILS AND ANCHORING STUDS, HEAVY DUTY CAST IRON GRATE H-20 RATED, INTERGAL 24 X 24 CATCH BASIN WITH EXTRA HEAVY DUTY GRATE AND REMOVABLE SEDIMENT BASKET.	NA
WC-1 (ADA)	KOHLER	K-3979	FLOOR MOUNTED, 1.6 GPF, WHITE VITREOUS CHINA, ELONGATED BOWL, TANK TYPE TOILET, POLISHED CHROME TRIP LEVER, ADA COMPLIANT HEIGHT.	PROVIDE WITH ELONGATED SEAT, COVER AND 3/8" NPT ANGLE SUPPLY WITH STOP.

NOTES:

1. REFER TO PLUMBING FIXTURE SCHEDULE FOR MINIMUM CONNECTION SIZES.

DOMESTIC CIRC. PUMP

REFERENCE	CP-1
MANUFACTURER	BELL&GOSSETT
MODEL #	PL-30
TYPE	INLINE
SERVES	DOM. WATER
GPM	1
MOTOR HP	0.08
FT HEAD	10
VOLTAGE/PH	115/1
NOTES	1,2

NOTES:

1. PUMP TO OPERATE PER TIMER PROVIDED/WIRED BY M.C.  
2. EC TO PROVIDE DISCONNECT.

ELECTRIC WATER HEATER

REFERENCE	WH-1
MANUFACTURER	AO SMITH
MODEL #	ECT-40
SERVES	BUILDING
GALLONS	40
ENERGY FACTOR	0.92
RECOVERY GPM 90F RISE	21
INPUT KW	4.50
VOLTAGE/PH	240 / 1
NOTES	1,2

NOTES:


1. UNIT TO BE CSA CERTIFIED AND ASME RATED T&P RELIEF VALVE  
2. UNIT TO MEET REQUIREMENTS OF ASHRAE 90.1

PLUMBING FIXTURES ROUGH-IN SCHEDULE


FIXTURE	CW	HW	VENT	WASTE	NOTES
LAVATORY	1/2"	1/2"	1 1/2"	1 1/2"	1,2
SINK	1/2"	1/2"	1 1/2"	1 1/2"	1,2
WATER CLOSET (TANK)	1/2"	-	2"	4"	1,2
SERVICE SINK	1/2"	1/2"	1 1/2"	3"	1,2
SHOWER	1/2"	1/2"	1 1/2"	3"	1,2
FLOOR DRAIN	-	-	2"	3"	1,2

NOTES:


1. ALL SIZES SHOWN ARE MINIMUM CONNECTION SIZES, REFER TO DRAWINGS FOR FINAL SIZES.  
2. ALL BELOW FLOOR WASTE SIZES ARE TO BE A MINIMUM OF 2".

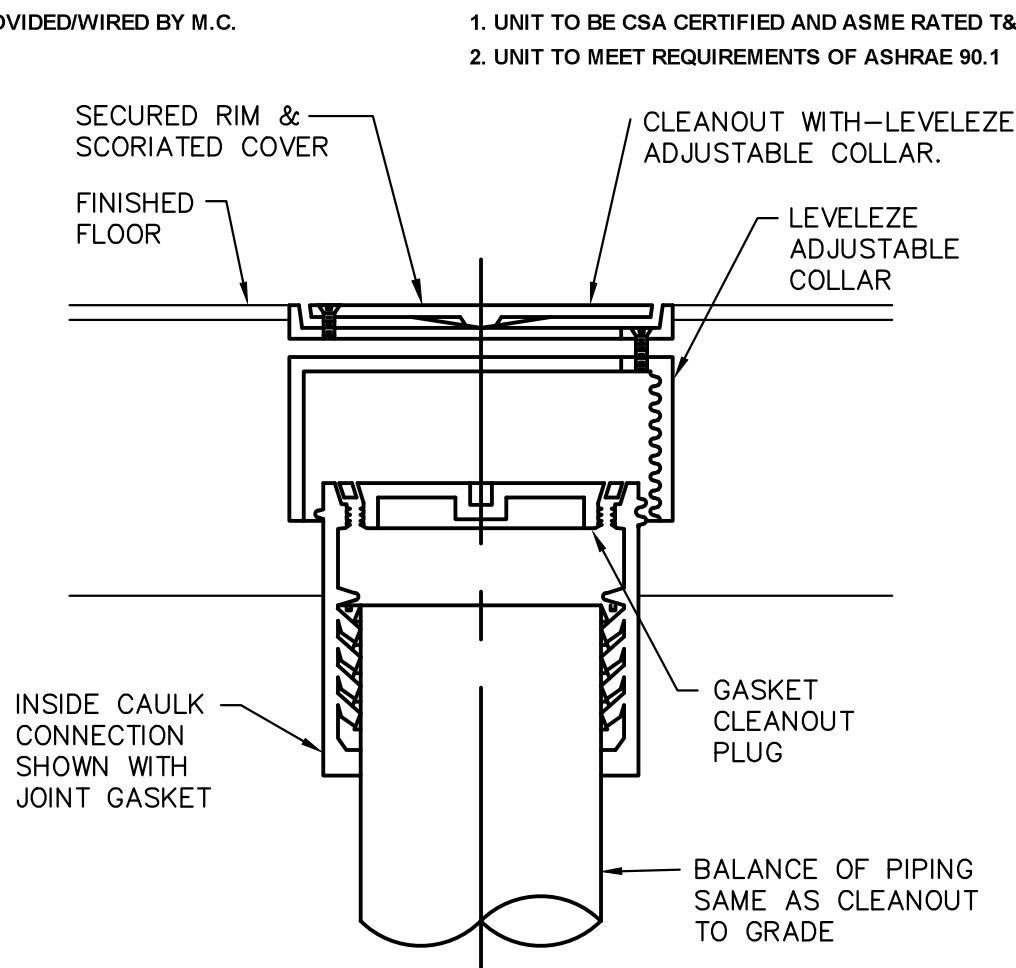


6 FLOOR CLEANOUT DETAIL  
NOT TO SCALE

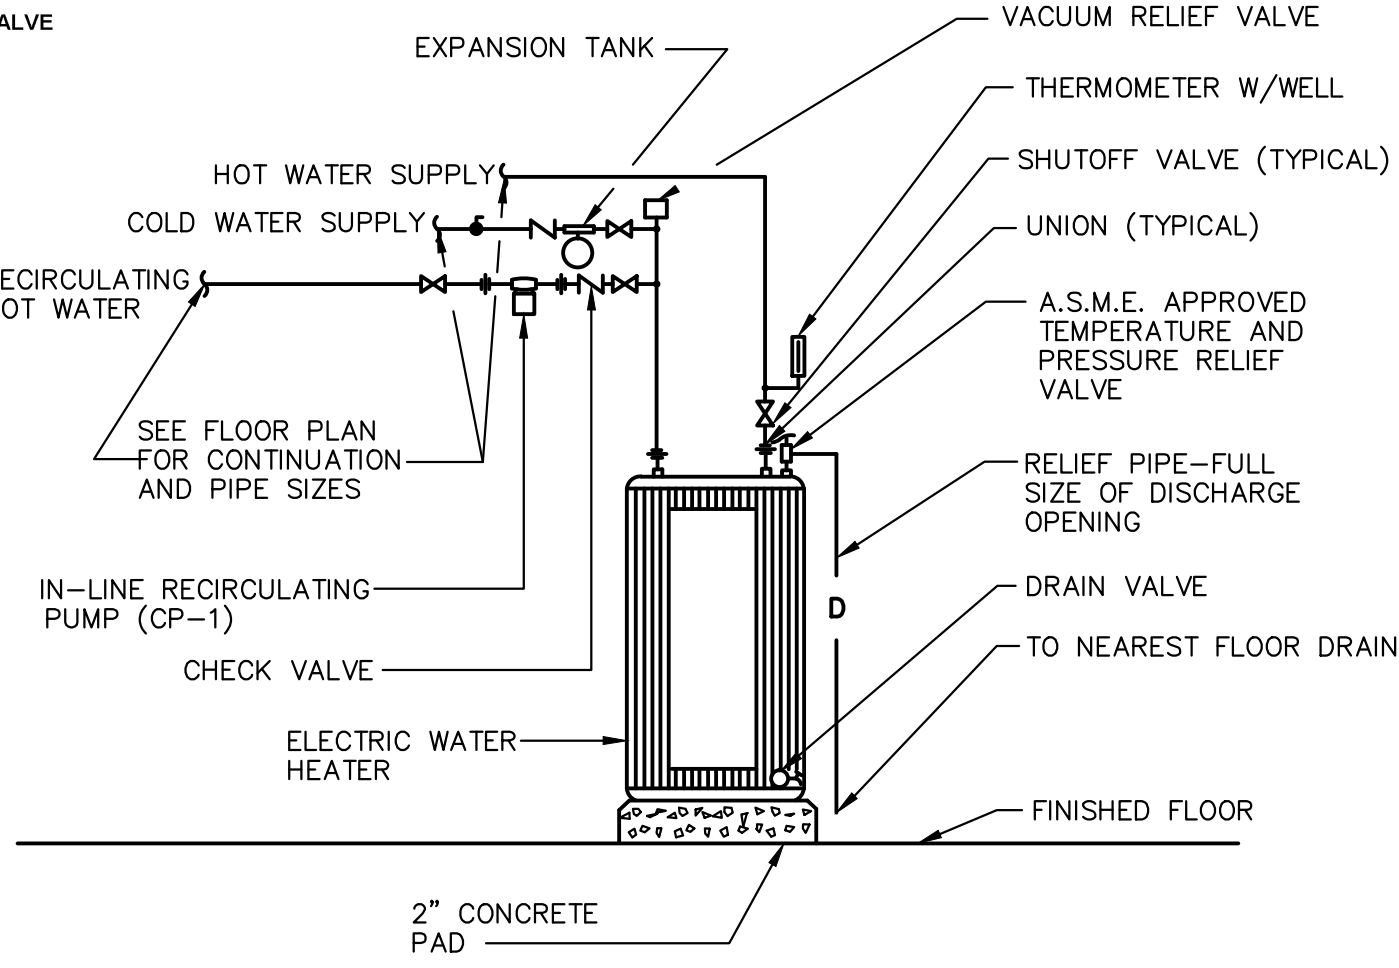


7 WATER HEATER DETAIL  
NOT TO SCALE

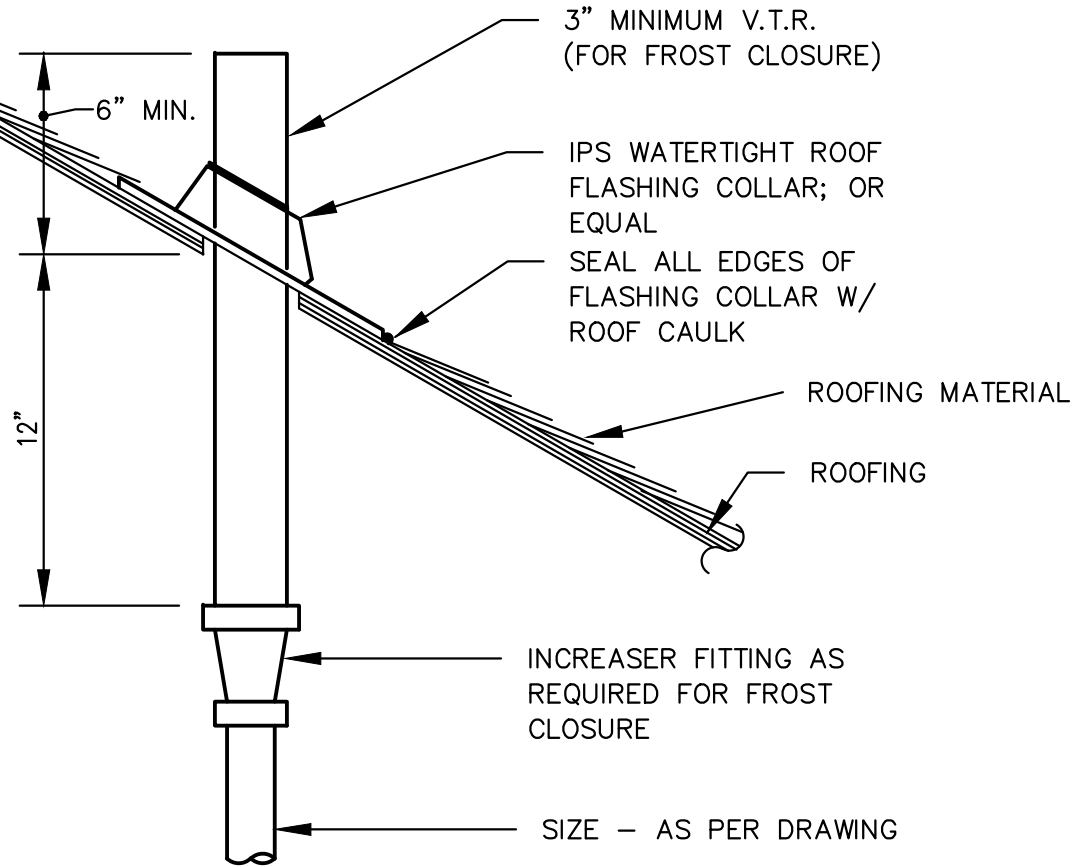


8 PLUMBING VENT THROUGH PITCHED ROOF DETAIL  
NOT TO SCALE

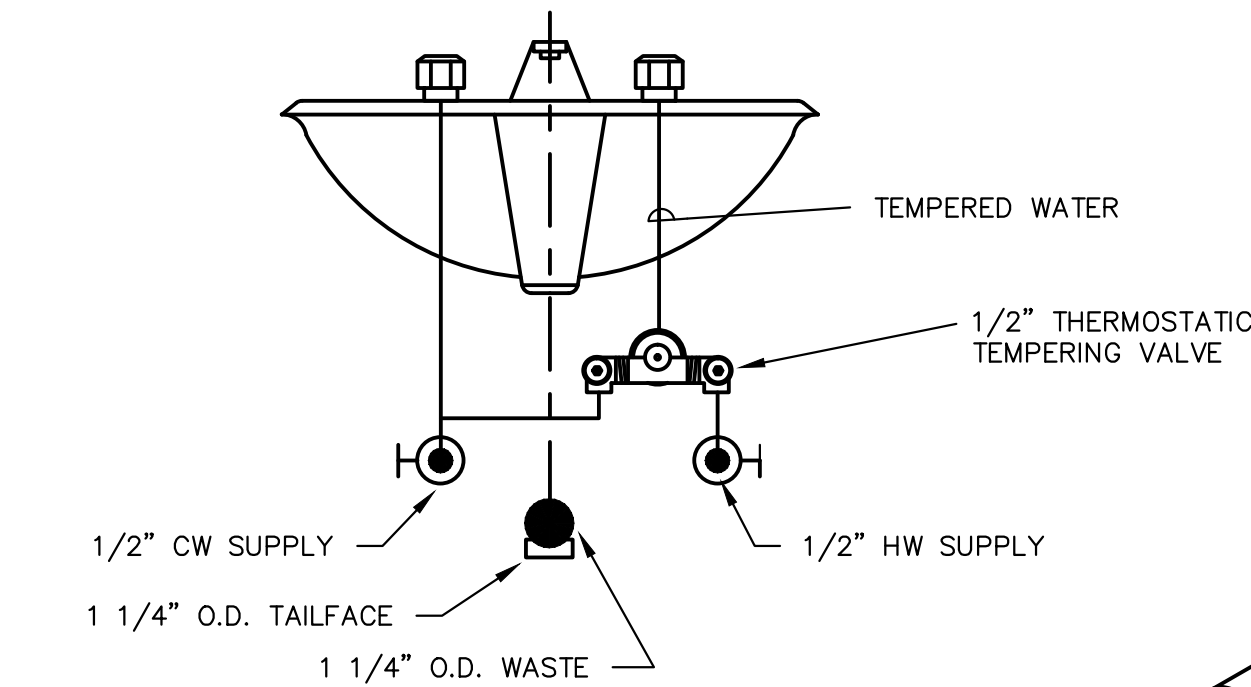


4 LOCAL MIXING VALVE DETAIL  
NOT TO SCALE

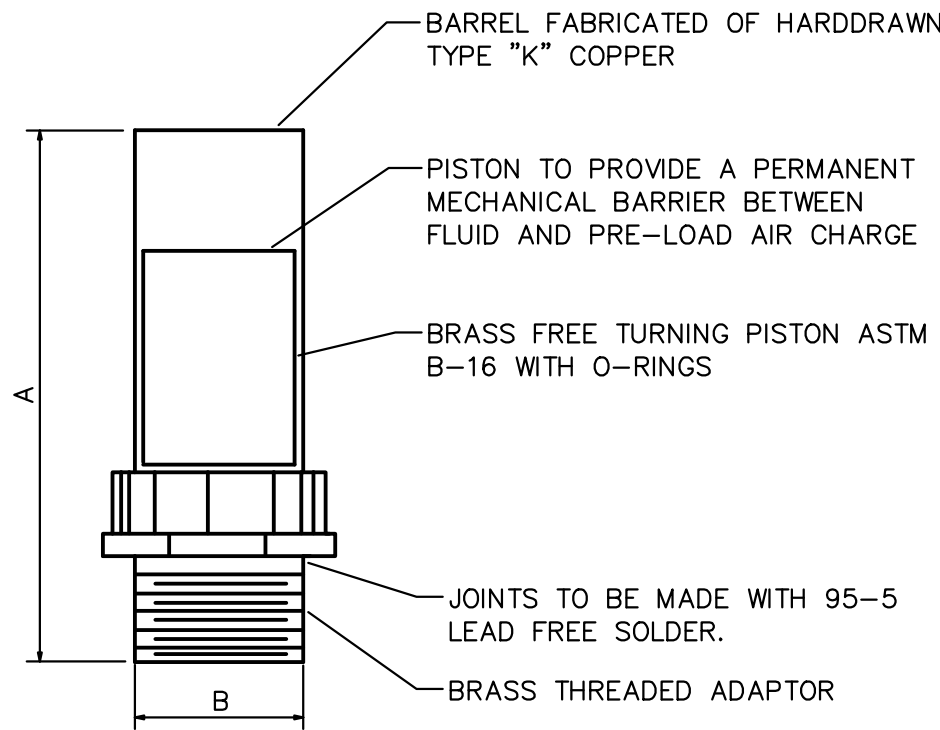


1 WATER SHOCK ARRESTOR DETAIL  
NOT TO SCALE

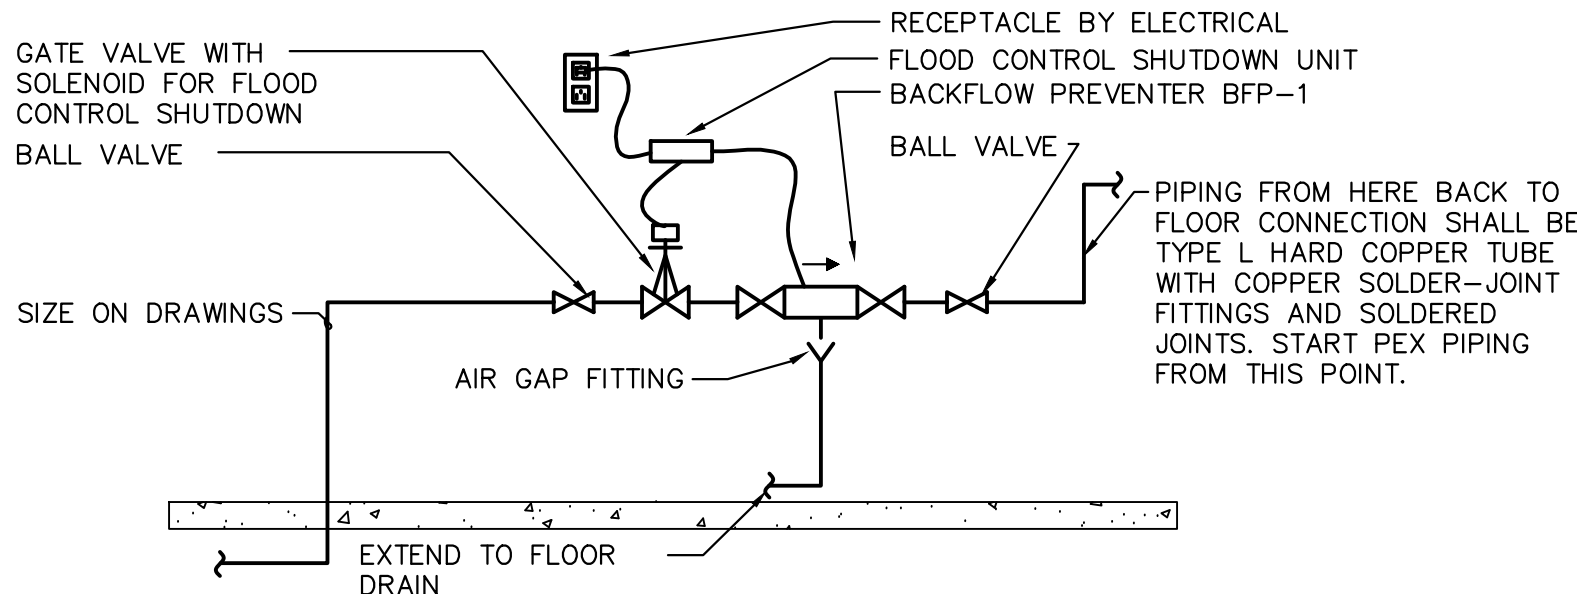


2 DOMESTIC WATER RISER DIAGRAM  
NOT TO SCALE

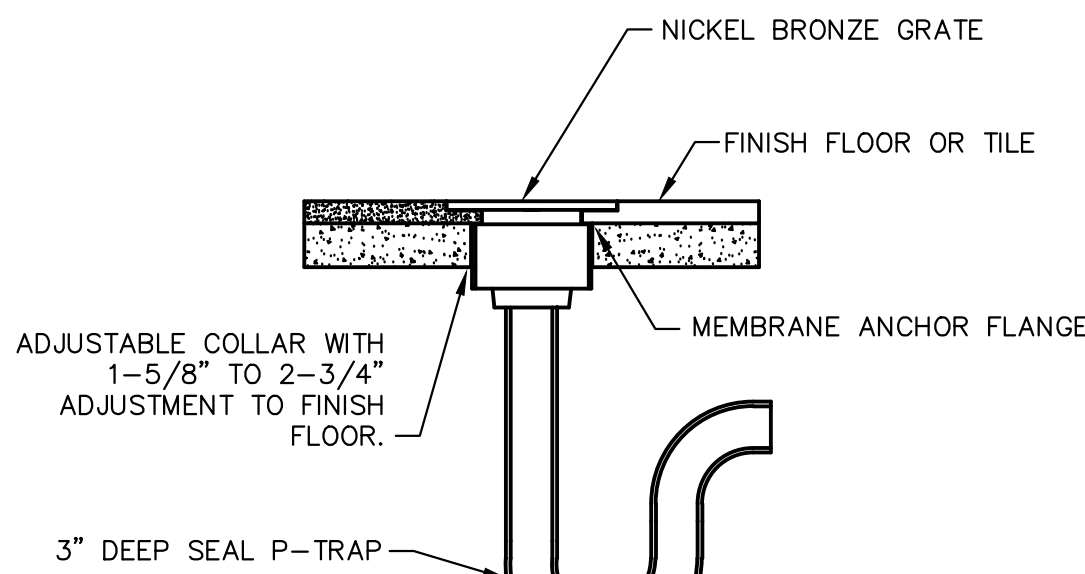

3 FLOOR DRAIN DETAIL  
NOT TO SCALE

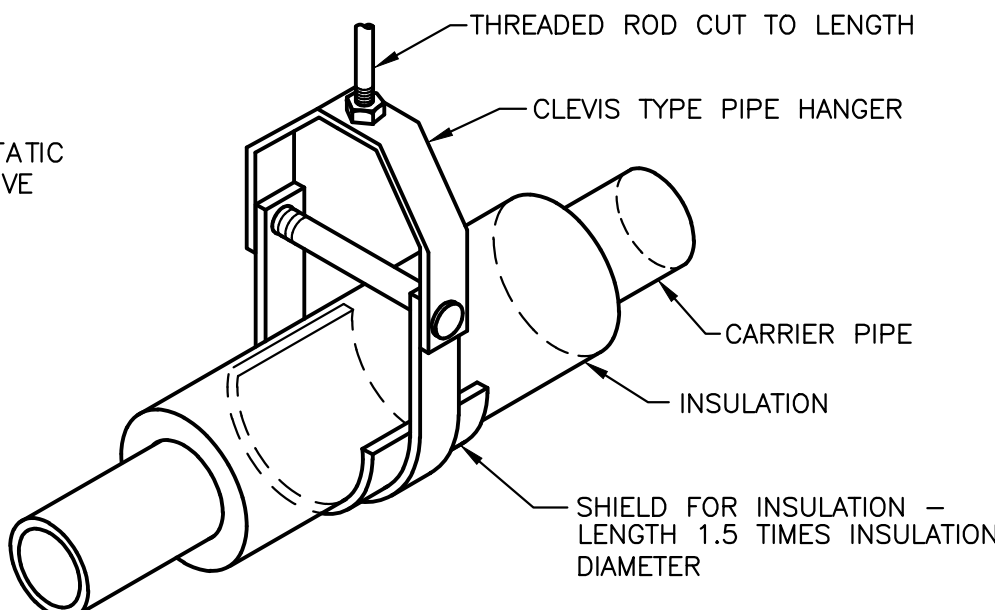

5 CLEVIS TYPE PIPE HANGER FOR INSULATED PIPE  
NOT TO SCALE

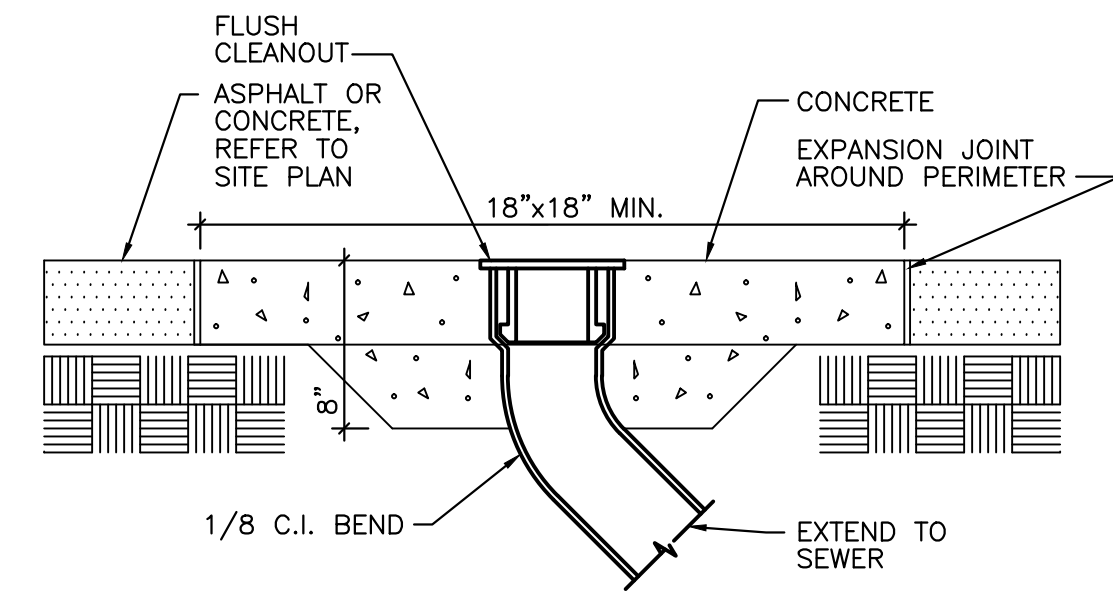

9 CLEANOUT AT GRADE  
NOT TO SCALE

IOWA DEPARTMENT OF  
NATURAL RESOURCES

ENGINEERING SERVICES - WALLACE BUILDING  
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F: 515.725.8202



PLUMBING SCHEDULES AND DETAILS

NEW OFFICE & STORAGE BUILDING FOR:  
**GREEN VALLEY STATE PARK**

UNION COUNTY, IOWA

1480 130TH STREET

NO. BY REVISION

DATE

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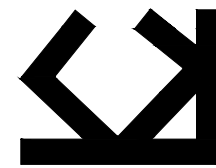
DATE

SHEET NO:

P2.0

KCL Engineering  
218 12th St.  
West Des Moines, Iowa 50265  
info@kclengineering.com  
515.724.7938


CONSULTANT










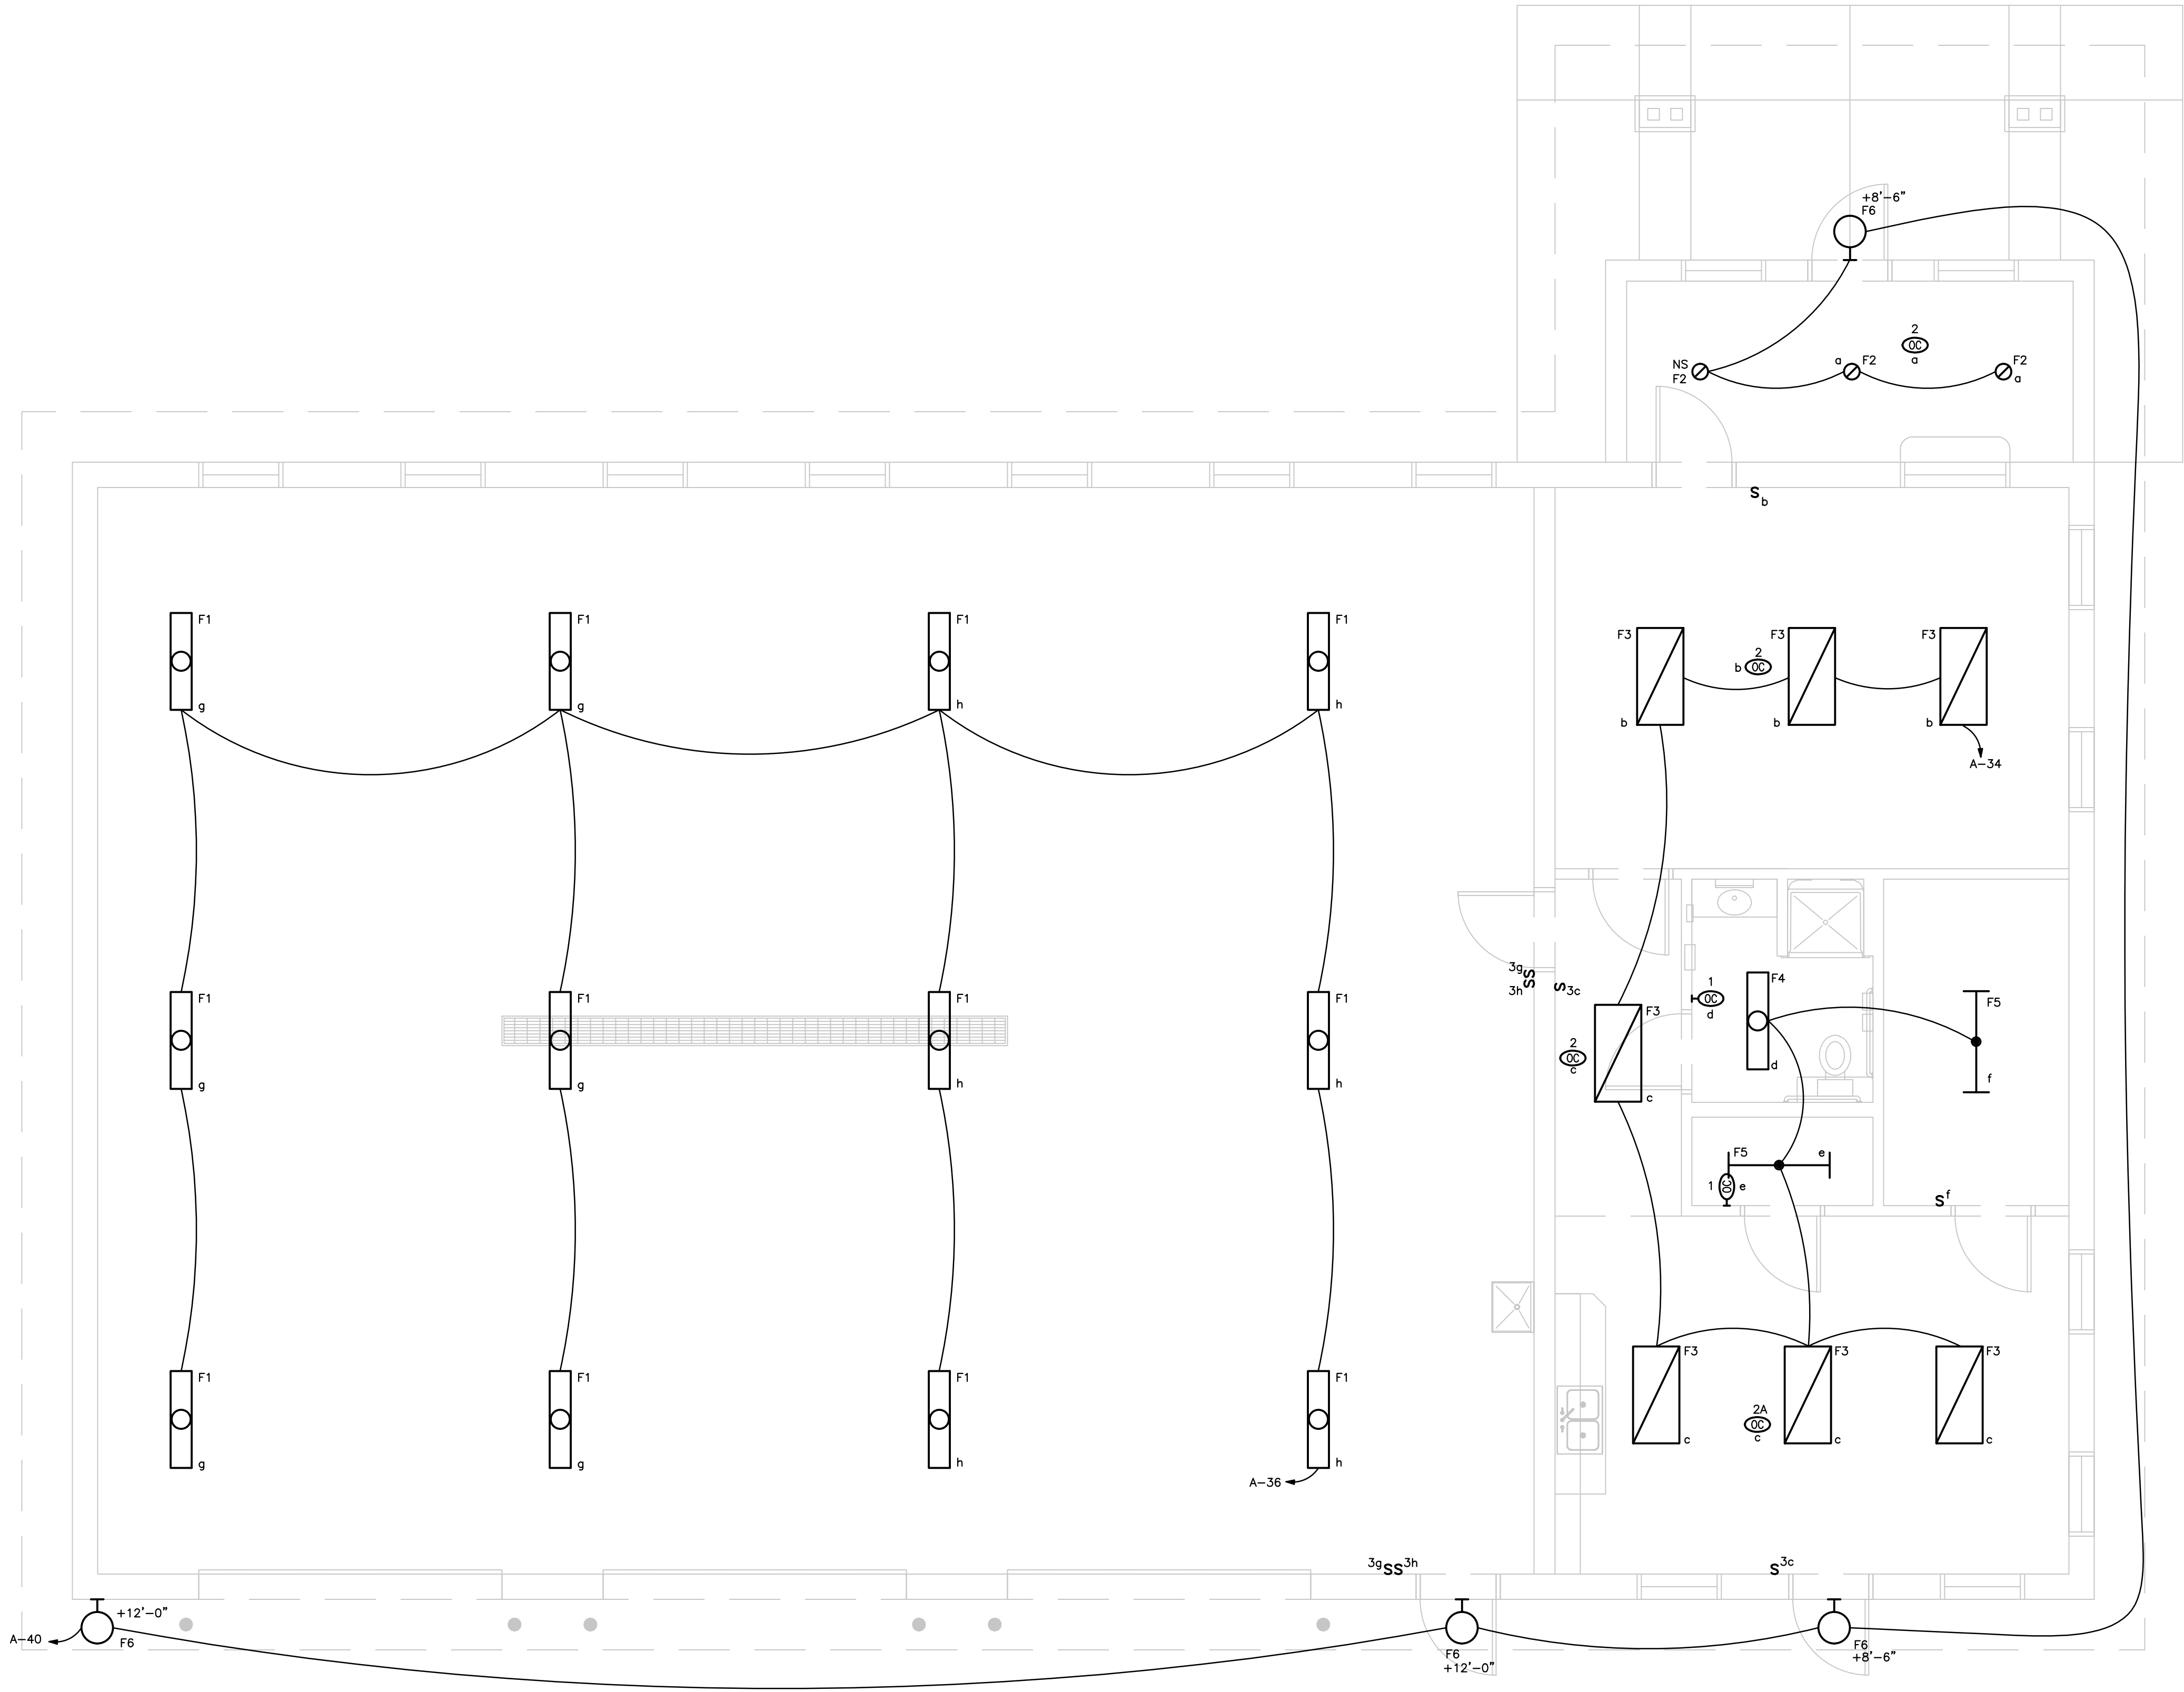

GENERAL NOTES  
1. COORDINATE LOCATION/INSTALLATION OF MECHANICAL AND ELECTRICAL WORK WITH ALL OTHER TRADES. NO ASPECT OF A SYSTEM INSTALLATION OR ITS ROUGH-IN SHALL COMMENCE UNTIL PROPER AND TIMELY COORDINATION WITH ALL TRADES ASSOCIATED WITH THE INSTALLATION HAS TRANSPIRED. ITEMS TO BE COORDINATED SHALL INCLUDE BUT NOT BE LIMITED TO: BUILDING STRUCTURE, SHEET METAL, ALL PIPING SYSTEMS, LIGHT FIXTURES, CONDUITS, CABLE TRAYS, ETC. REFER TO ALL GENERAL, MECHANICAL, AND ELECTRICAL DRAWINGS AND SPECIFICATIONS FOR THIS PROJECT.

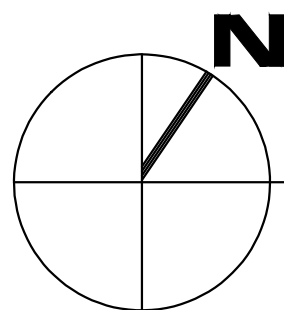

## OFFICE FLOOR PLAN - LIGHTING



SCALE: 1/4" = 1'-0"

OFFICE FLOOR PLAN - LIGHTING  
NEW OFFICE & STORAGE BUILDING FOR:  
**GREEN VALLEY STATE PARK**  
1480 130TH STREET  
UNION COUNTY, IOWA

NO.	BY	REVISION
1	JL	15-04-88-01
2	JV	07-29-2015


SHEET No: **E1.0**

IOWA DEPARTMENT OF  
**NATURAL RESOURCES**  
ENGINEERING SERVICES - WALLACE BUILDING  
502 E. 9TH ST., DES MOINES, IA 50319-0034  
P: 515.725.8200  
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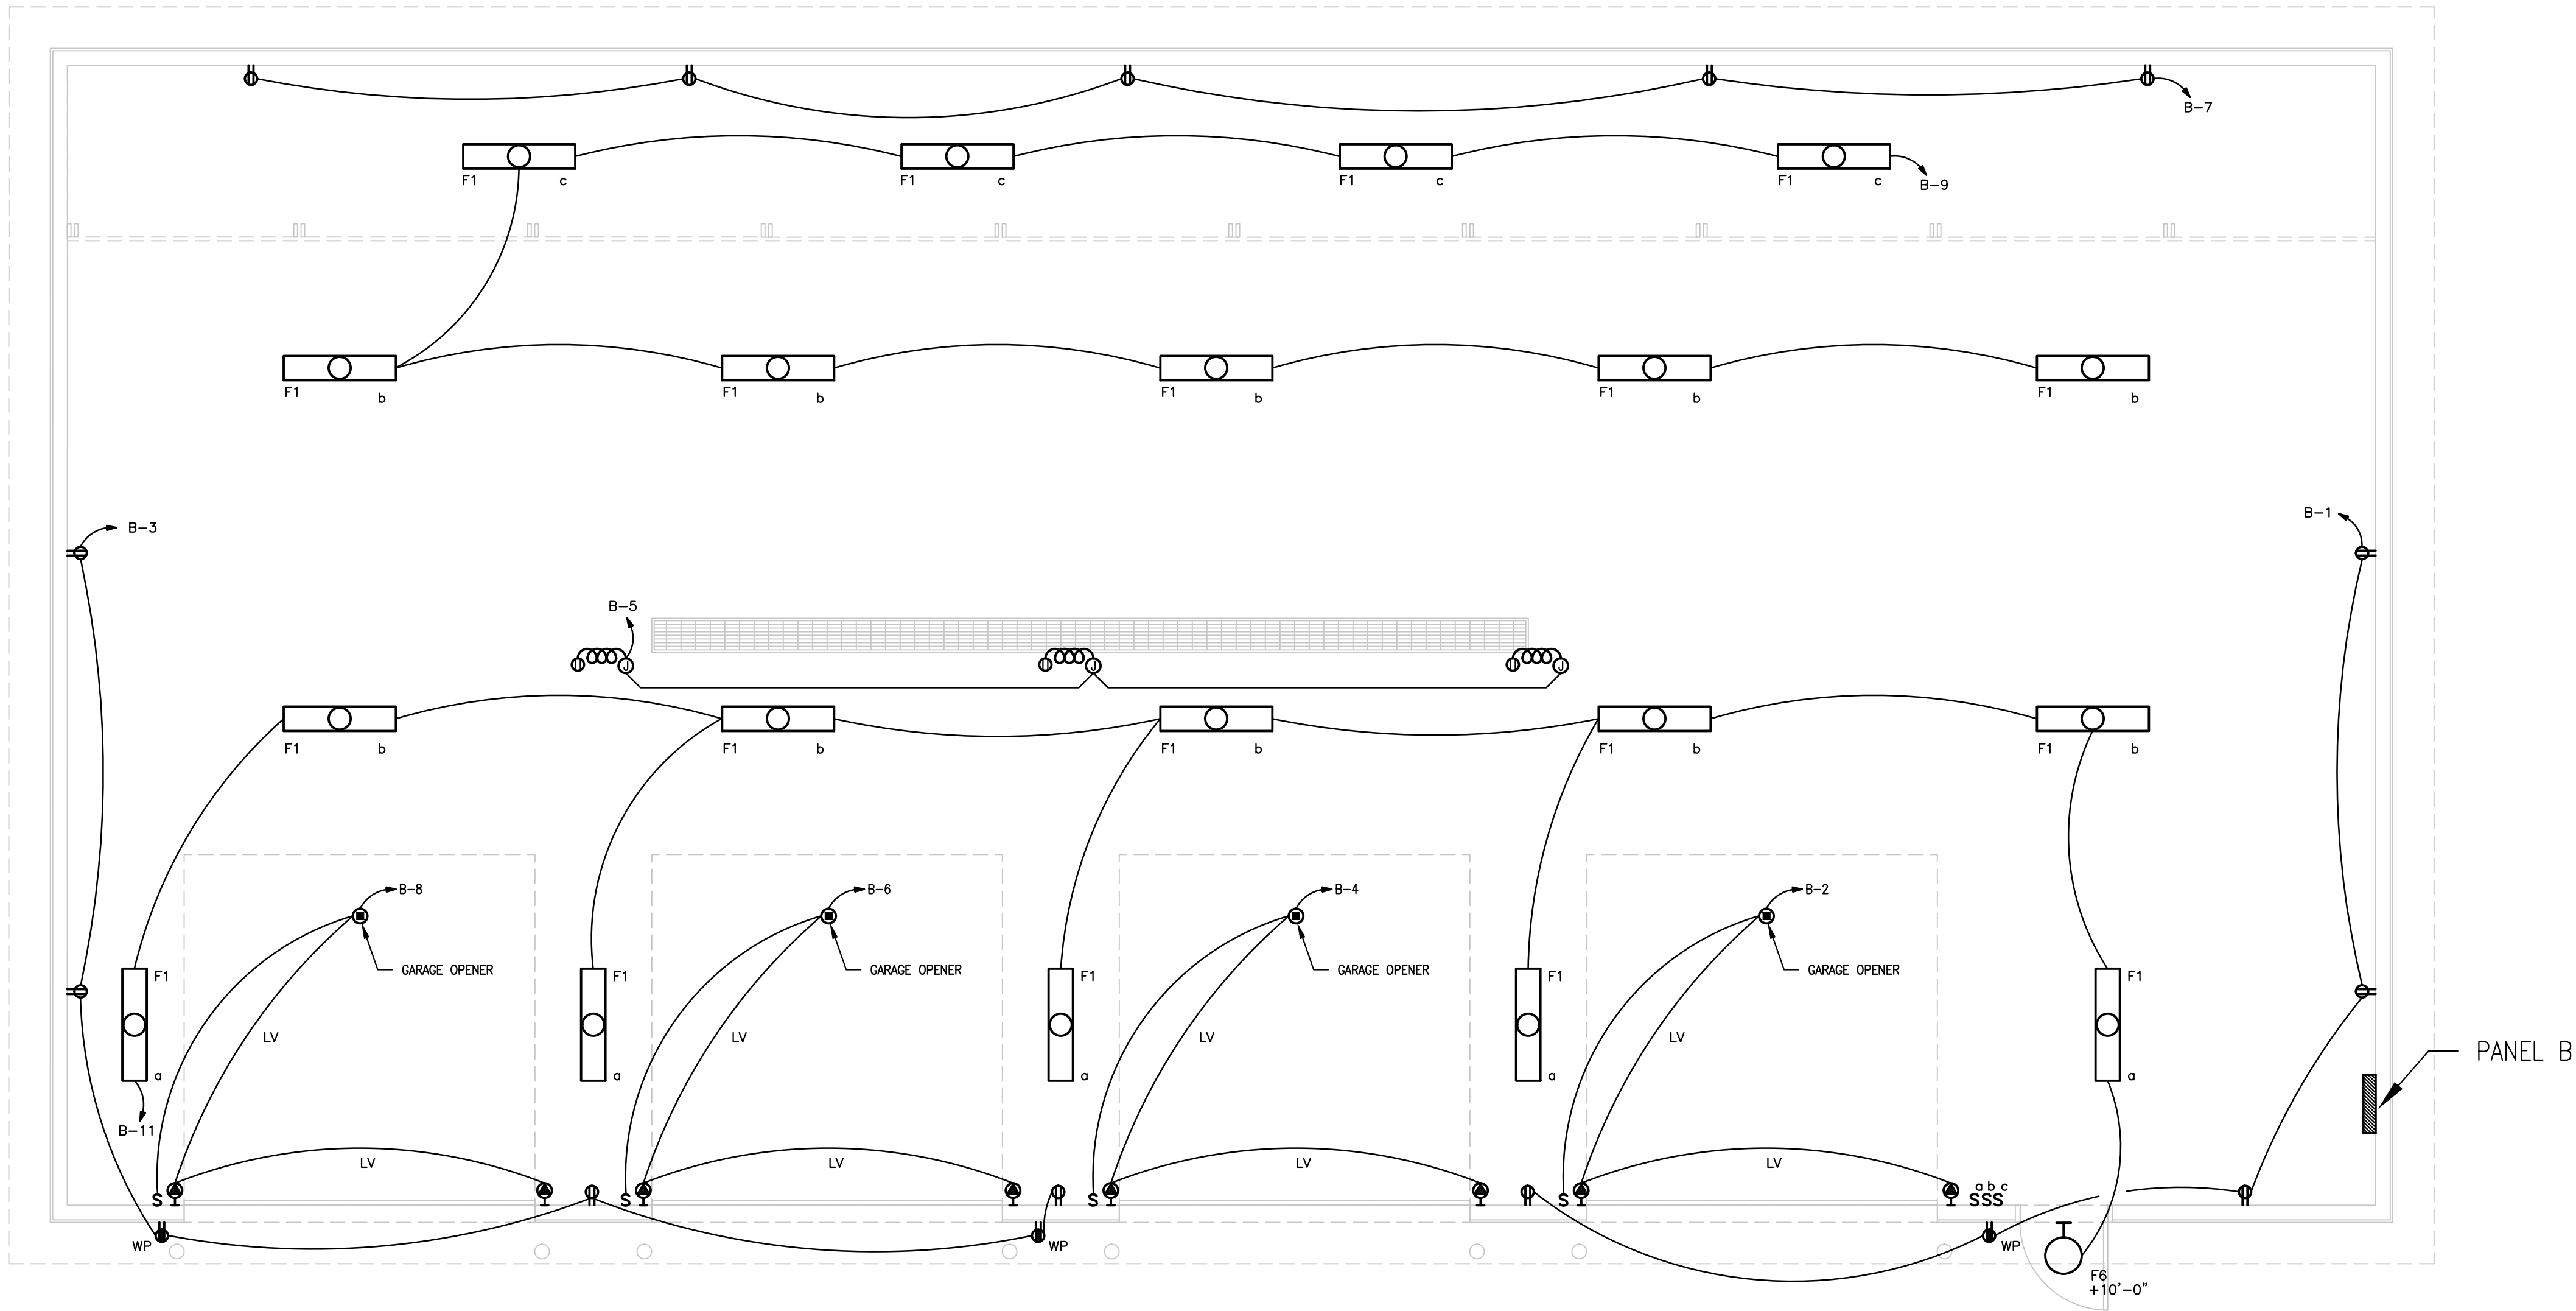


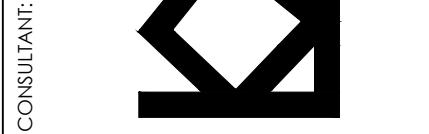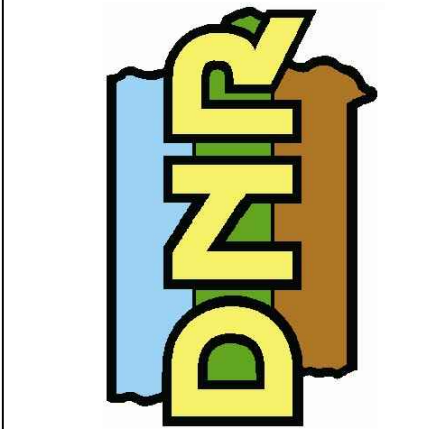


SCALE:  $1/4'' = 1'-0''$

NO.	BY DATE	REVISION
DRAWN BY:	JL	PROJECT NUMBER: 15-04-88-01
CHK'D BY:	JV	DATE: 07.29.2015
SHEET No: <b>E2.0</b>		

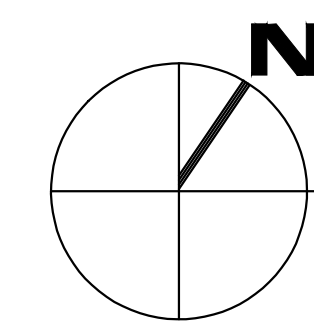



GENERAL NOTES  
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STORAGE FLOOR PLAN - ELECTRICAL

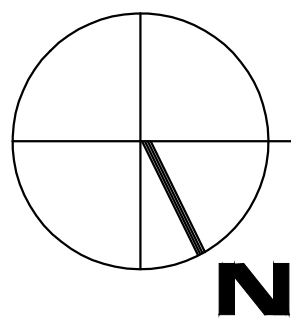
SCALE: 1/4" = 1'-0"

STORAGE FLOOR PLAN - ELECTRICAL	
NEW OFFICE & STORAGE BUILDING FOR: <b>GREEN VALLEY STATE PARK</b>	
1480 130TH STREET UNION COUNTY, IOWA	
NO.	REVISION
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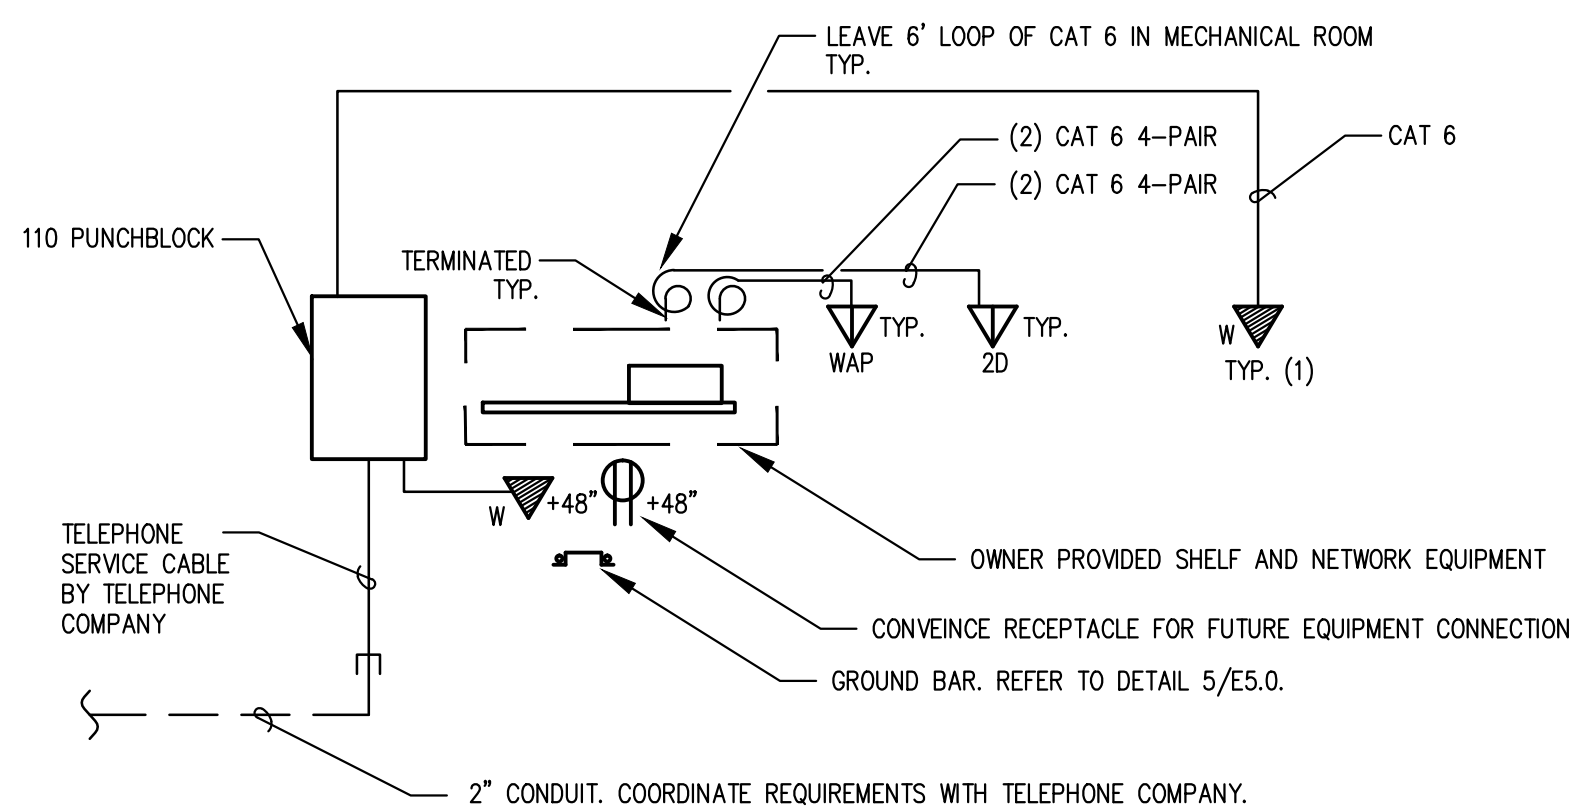


- A. ALLIANT ENERGY SHALL FURNISH AND INSTALL BOX-PAD. CUSTOMER SHALL PROVIDE AND INSTALL CONDUIT.
- B. AT ALLIANTS ENERGY'S DISCRETION CONDUIT ELBOWS MAY BE ELIMINATED AND THE CUSTOMER MAY EXTEND THE CONDUIT WITHOUT ELBOWS UNDER THE PAD TO THE OPENING AND INSTALL CONDUIT BUSHINGS.
- C. CONTACT ALLIANT ENERGY ENGINEERING FOR SIZE AND NUMBER OF CONDUIT.
- D. BOX-PADS COME WITH 3/8 INCH - UNC EMBEDDED NUTS FOR BOLTING TRANSFORMERS TO PAD.
- E. TRANSFORMERS SHOULD NOT EXTEND OVER EDGES OF BOX-PAD. LARGER TRANSFORMERS WITH COOLING FINS MAY REQUIRE THE LARGER BOX-PAD.
- F. TRANSFORMERS OR OTHER PAD MOUNTED EQUIPMENT SHALL NOT BE COVERED WITH DECORATIVE OBJECTS FOR THE PURPOSE OF HIDING THE ALLIANT ENERGY EQUIPMENT FROM PUBLIC VIEW.

1 UTILITY TRANSFORMER AND BOX-PAD  
NOT TO SCALE

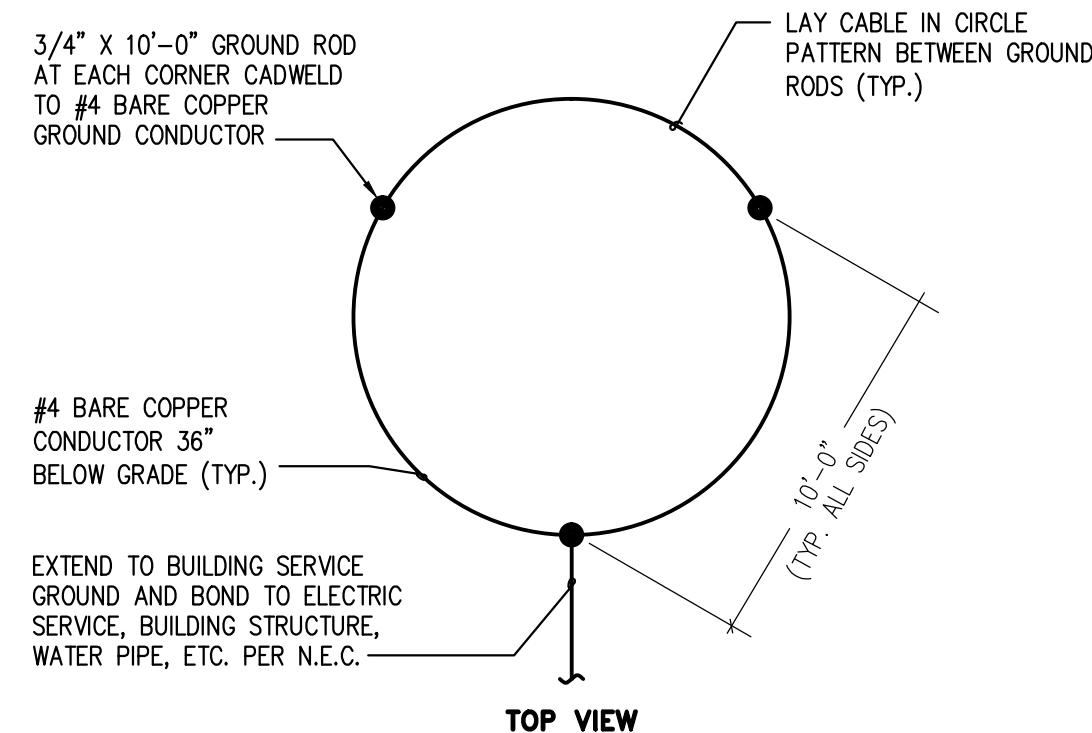

2 NEW BUILDING GROUND RING  
NOT TO SCALE




NOTES:

1. ALL CABLES SHALL ADHERE WITH TRANSMISSION STANDARDS IN TIA/EIA-568-B.1.
2. ALL CABLES SHALL BE 100-OHM, FOUR-PAIR UTP, FORMED INTO 25-PAIR, BINDER GROUPS COVERED WITH A BLUE THERMOPLASTIC JACKET.
3. OWNER SHALL PROVIDE AND INSTALL OWN TELECOMMUNICATION EQUIPMENT.


3 VOICE/DATA RISER  
NOT TO SCALE

TAG	PHASE/NEUTRAL	GROUND	CONDUIT
A	2 SETS OF (3) #300MCM THWN	—	(2) 3"
B	(3) #4/0 THWN	#4 THWN	2 1/2"
C	(3) #3 THWN	#8 THWN	1 1/4"
D	(3) #1/0 THWN	#8 THWN	2"
E	(3) #2 THWN	#4 THWN	1 1/4"


NOTE: UNLESS DESIGNATED OTHERWISE, CONDUCTORS SHALL BE THWN COPPER

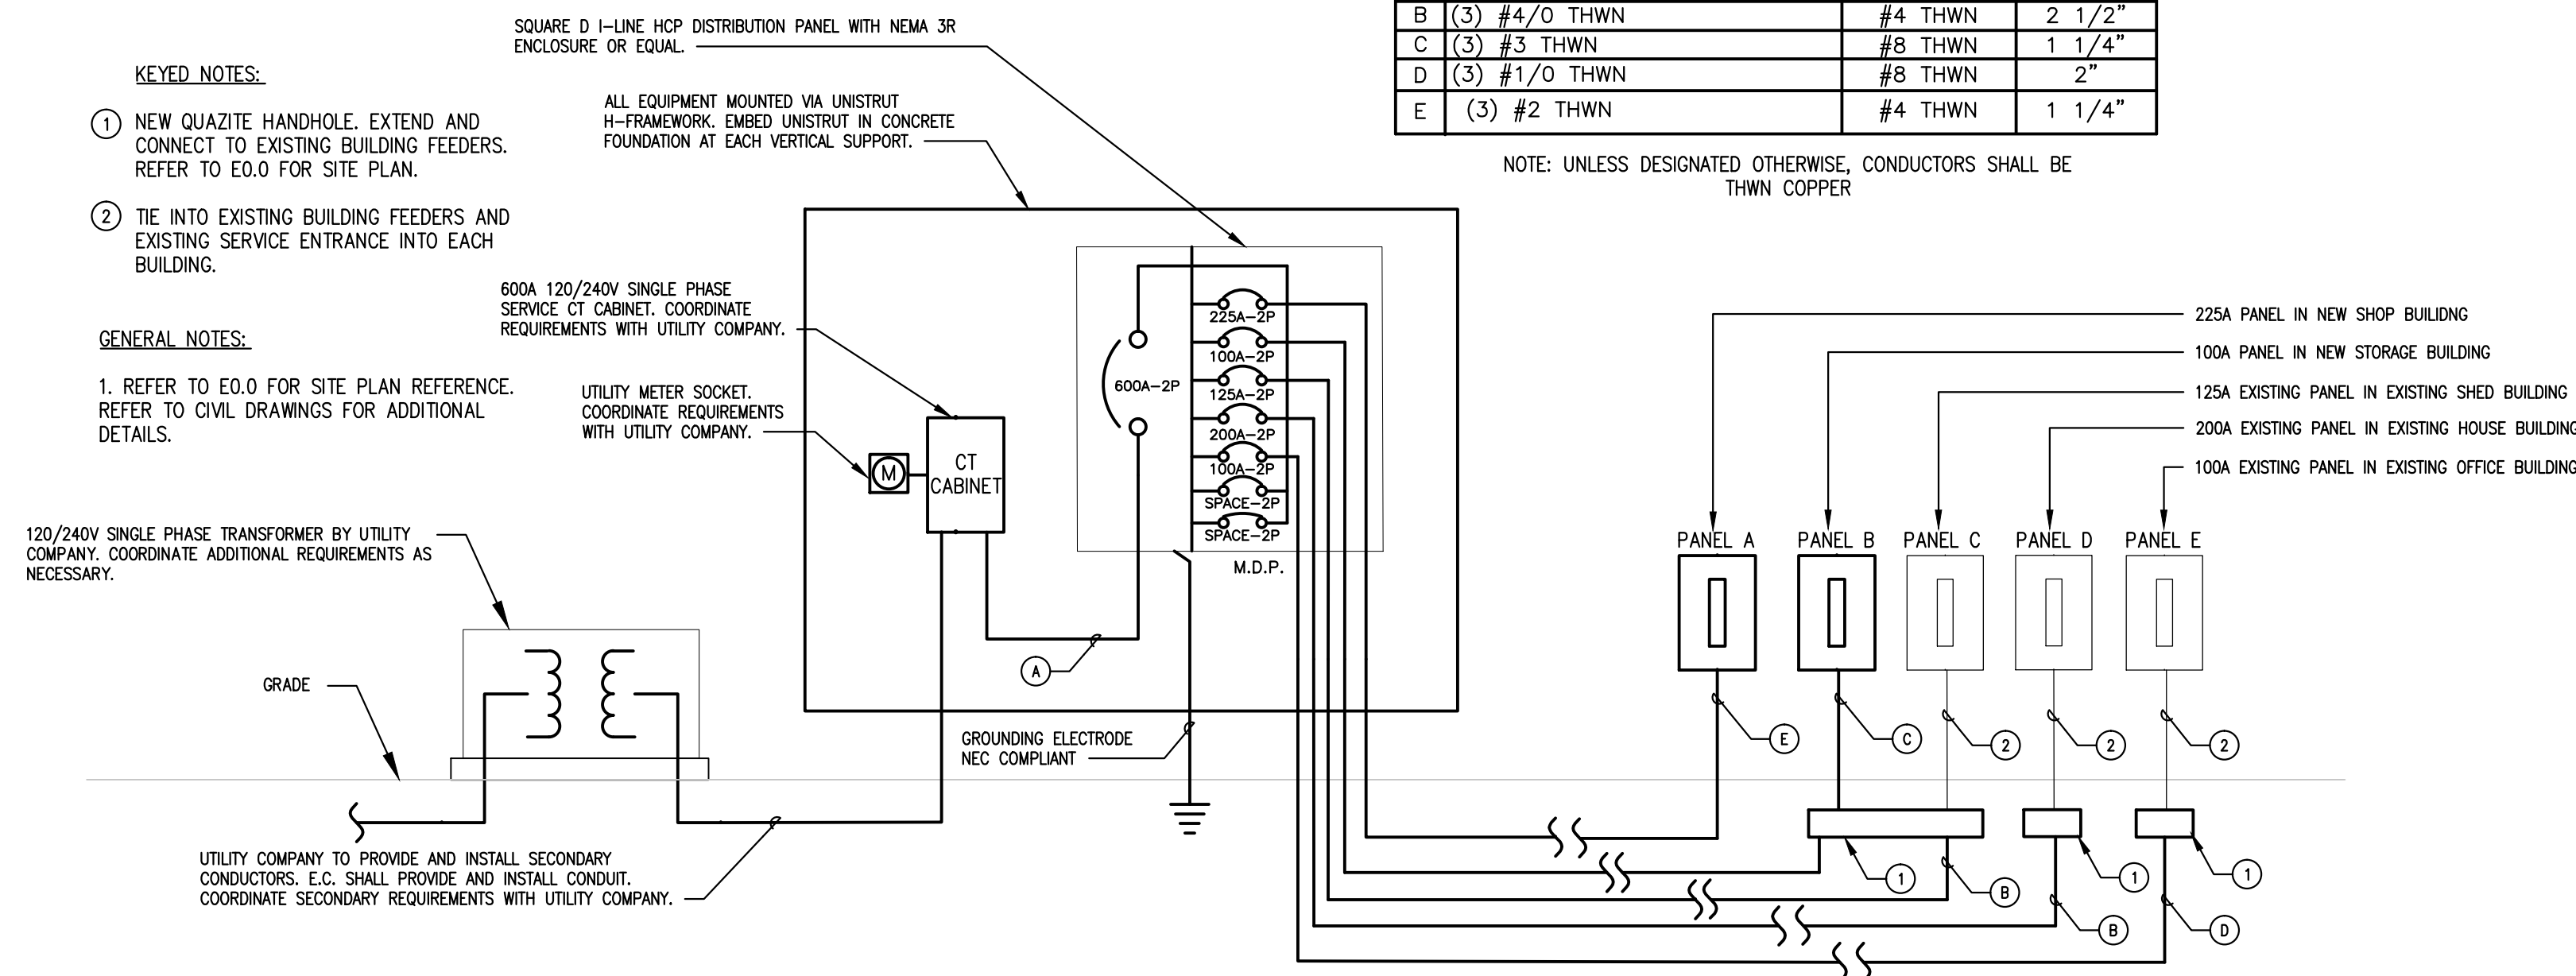

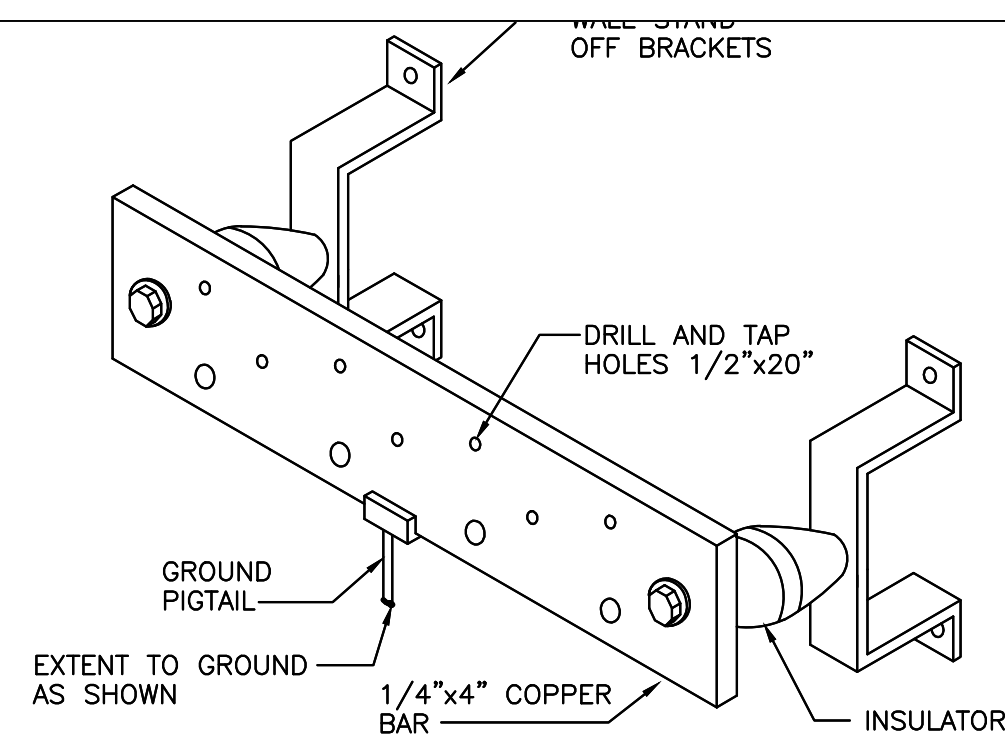


4 ONE-LINE DIAGRAM  
NOT TO SCALE

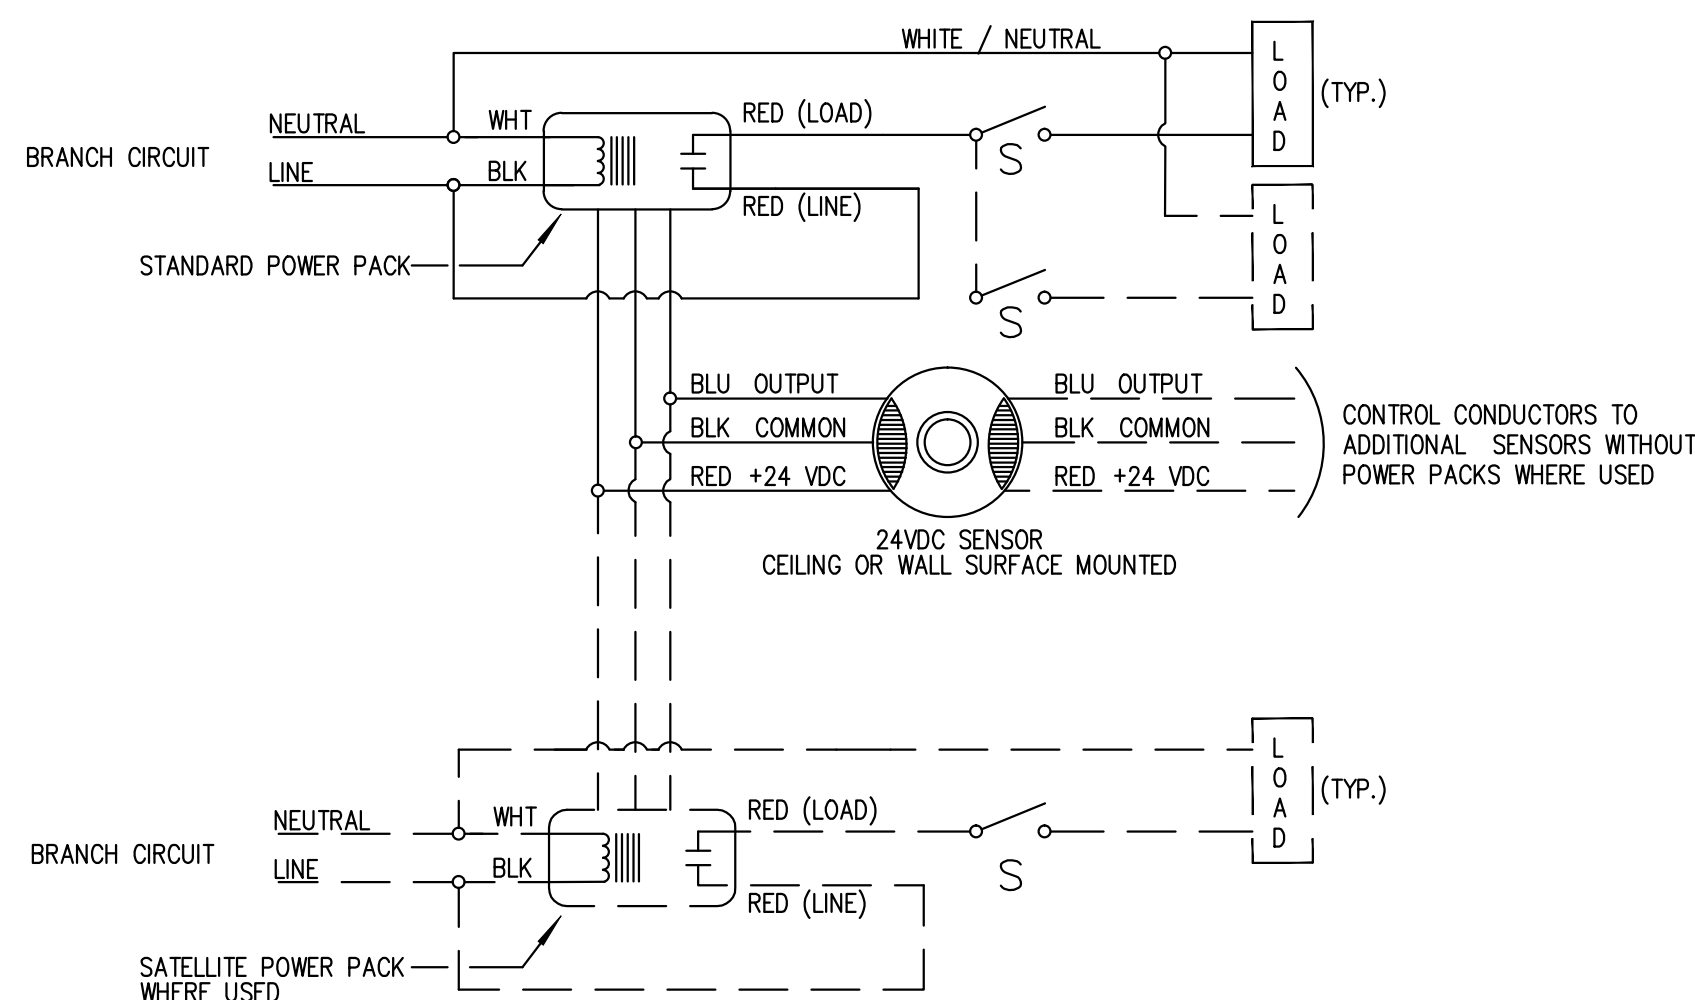

5 GROUND BAR  
NOT TO SCALE



6 MANUAL ON & OCCUPANCY SENSOR LIGHTING CONTROL WIRING – TYPICAL  
NOT TO SCALE

LIGHTING CONTROL DEVICE SCHEDULE					
TYPE	MANUFACTURER & MODEL NUMBER	MOUNTING	VOLTAGE	DETAILS	APPROVED EQUALS
 1	GREENGATE CONTROLS ONW-D-1001-DMV-N-W	WALL	120-277V	500 SQUARE FOOT COVERAGE ULTRASONIC PASSIVE INFRARED WALLBOX OCCUPANCY SENSOR WITH TWO MANUAL ON SWITCHES AND INTEGRAL DAYLIGHTING PHOTOCELL. IMPACT RESISTANT PIR LENS AND HOUSING WITH WHITE FINISH. 120/277 VOLT INPUT POWER. INTEGRAL SELF-ADJUSTING SENSITIVITY MICROPROCESSOR. FIELD CONFIGURE SENSOR FOR MANUAL ON, AUTOMATIC OFF OPERATION. FULL FIVE YEAR WARRANTY FURNISHED BY MANUFACTURER.	WATTSTOPPER LEVITON SCHNEIDER ELECTRIC SENSOR SWITCH HUBBLE AUTOMATION
 2	GREENGATE CONTROLS OAC-DT-2000/SP20-MV	CEILING	120-277 / 24VDC	2000 SQUARE FOOT COVERAGE ULTRASONIC AND PASSIVE INFRARED OCCUPANCY SENSOR WITH WHITE FINISH AND 120-277/24 VOLT POWER PACK. INTEGRAL SELF-ADJUSTING SENSITIVITY MICROPROCESSOR. 360° ULTRASONIC COVERAGE AND 360° PASSIVE INFRARED COVERAGE. FULL FIVE YEAR WARRANTY FURNISHED BY MANUFACTURER. WIRE OC-2A TO BE SLAVE TO OC-2 POWER PACK. WIRE UP TO 4 PER POWER PACK.	WATTSTOPPER LEVITON SCHNEIDER ELECTRIC SENSOR SWITCH HUBBLE AUTOMATION
 2A	GREENGATE CONTROLS OAC-DT-2000				

1. SENSOR EQUIPMENT MANUFACTURERS SHALL PROVIDE FACTORY AUTHORIZED REPRESENTATIVE TO DEMONSTRATE TYPICAL INSTALLATION AND COMMISSIONING OF EQUIPMENT TO INSTALLING CONTRACTOR DURING PROJECT CONSTRUCTION.
2. OCCUPANCY SENSOR TIME-OFF SETTINGS SHALL BE 20 MINUTES MINIMUM AND 30 MINUTES MAXIMUM.



PANEL A															GREEN VALLEY STATE PARK	
LOAD DESCRIPTION	LOAD	TY	BRKR	CKT	PHASE		CKT	BRKR	TY	LOAD	LOAD DESCRIPTION					
	(VA)		AMP	P	NO	A	B	NO	AMP	P	(VA)					
RECEPTACLE	900	R	20	1	1	1080		2	15	1	M	180	BOILER			
RECEPTACLE	720	R	20	1	3		1440	4	20	1	R	720	RECEPTACLES			
RECEPTACLE	540	R	20	1	5	2690		6	30	2	M	4300	CU			
RECEPTACLE	720	R	20	1	7		2870	8					-			
RECEPTACLE	720	R	20	1	9	2870		10	30	2	M	4300	CUH			
RECEPTACLE	1080	R	20	1	11		3230	12					-			
RECEPTACLE	1080	R	20	1	13	1580		14	20	1	M	500	GFS			
RECEPTACLE	1080	R	20	1	15		1800	16	20	1	R	720	RECEPTACLES			
CORD REELS	720	R	20	1	17	1220		18	20	1	M	500	RCP			
WELDER		A	50	2	19		1500	20	20	1	M	1500	FUEL PUMP			
-						21	1100	22	20	1	M	1100	EF-2			
WELDER		A	50	2	23		1500	24	20	1	A	1500	MICROWAVE			
-						25	1000	26	20	1	A	1000	DISPOSAL			
GARAGE DOOR	900	M	20	1	27		2100	28	20	1	A	1200	REFRIGERATOR			
GARAGE DOOR	900	M	20	1	29	1080		30	20	1	R	180	GF RECEPTACLE			
GARAGE DOOR	900	M	20	1	31		1080	32	20	1	R	180	GF RECEPTACLE			
WATER HEATER	4500	M	30	2	33	2750		34	20	1	L	500	LIGHTING			
-						35		35	36	20	1	L	800	LIGHTING		
AIR COMPRESSOR		M	30	2	37	500		38	20	1	M	500	DCP			
-						39		36	40	20	1	L	360	LIGHTING		
SPARE			20	1	41			42	20	1			SPARE			
VOLTS-PHASE-WIRE		120/240V-1PHASE-3W														
BUS RATING		225A														
MAIN BREAKER RATING		225A														
MOUNTED		SURFACE														
DEMAND LIGHTING		1.66		KVA @ 100%		1.66										
DEMAND RCPT. 10KVA @ 100%+		9.36		KVA @ 50%		9.36										
DEMAND MOTOR		20.08		KVA @ 100%		20.08										
DEMAND APPLIANCES		3.70		KVA @ 100%		3.70										
OTHER				KVA @ %												
SCCR RATING		25,000		A												
TOT. DEMAND (KVA)		34.80														
TOT. DEMAND (AMPS)		145.00														
TOT. CONNECTED LOAD (KVA)		34.80														
TOT. CONNECTED LOAD (AMPS)		145.00														
TOT. CONNECTED AMPS * 1.25		181.25		AMPS												

PANEL B															GREEN VALLEY STATE PARK	
LOAD DESCRIPTION	LOAD (VA)	TY	BRKR		CKT	PHASE		CKT	BRKR	TY	LOAD (VA)	LOAD DESCRIPTION				
			AMP	P		A	B					NO	AMP	P		
RECEPTACLES	900	R	20	1	1	1800				2	20	1	M	900	GARAGE DOOR	
RECEPTACLES	1080	R	20	1	3		1980			4	20	1	M	900	GARAGE DOOR	
CORD REELS	540	R	20	1	5	1440				6	20	1	M	900	GARAGE DOOR	
RECEPTACLES	900	R	20	1	7		1800			8	20	1	M	900	GARAGE DOOR	
LIGHTING	600	L	20	1	9	600				10	20	1			SPARE	
LIGHTING	700	L	20	1	11		700			12	20	1			SPARE	
VOLTS-PHASE-WIRE 120/240V-1PHASE-3W																
BUS RATING 100A																
MAIN BREAKER RATING 100A																
MOUNTED SURFACE																
DEMAND LIGHTING 1.30 KVA @ 100% 1.30																
DEMAND RCPT. 10KVA @ 100%+ 3.42 KVA @ 50% 3.42																
DEMAND MOTOR 3.60 KVA @ 100% 3.60																
DEMAND APPLIANCES KVA @ 100% _____																
OTHER KVA @ % _____																
SCCR RATING 25,000 A																
TOT. DEMAND (KVA) 8.32																
TOT. DEMAND (AMPS) 34.67																
TOT. CONNECTED LOAD (KVA) 8.32																
TOT. CONNECTED LOAD (AMPS) 34.67																
TOT. CONNECTED AMPS * 1.25 43.33 AMPS																
TOTAL LOAD BY PHASE (KVA)																
A PHASE CONNECTED 3.84																
B PHASE CONNECTED 4.48																
DEMAND LOAD SUMMARY TOTAL KVA																
LIGHTING 1.30																
RECEPT. 3.42																
MOTOR 3.60																
APPLIANCE																
OTHER																

EQUIPMENT SCHEDULE									
TAG	ELECTRICAL CHARACTERISTICS				DISCONNECT				REMARKS
	VOLT/PHASE	MOTOR HP	KW	MCA	TYPE	SIZE (AMPS)	NEMA RATING	FUSE (AMPS)	
EF-1	120 / 1	-	0.1	-	CP	20	1	-	Connect to lighting circuit
EF-2, EF-2 MOD, MOD-1	120 / 1	1/2	-	-	HOA	20	1	-	HOA switch provided by MC
B-1	120 / 1	-	-	15	CP	-	-	-	Cord provided with unit
WH-1	240 / 1	-	4.5	-	CB	-	-	-	-
DCP	120 / 1	1/8	-	-	CB	-	-	-	Time switch provided by MC installed by EC
RCP	120 / 1	1/8	-	-	CB	-	-	-	-
CUH-1	240 / 1	-	4	-	INT	-	-	-	-
SSI-1/2	240 / 1	-	-	1	-	-	-	-	Interconnected with CU-1
CU-1	240 / 1	-	-	18	DS	30	3R	-	-
ABBREVIATIONS:									
CB	CIRCUIT BREAKER IN PANELBOARD								
CP	CORD AND PLUG								
DS	NON-FUSED DISCONNECT SWITCH								
INT	INTEGRAL WITH EQUIPMENT FROM FACTORY								
HOA	HAND OFF AUTO SWITCH								

LUMINAIRE SCHEDULE										
TYPE	MANUFACTURER	MODEL NUMBER	DESCRIPTION	DIMENSIONS	LAMP		BALLAST	FIXTURE LOAD	FIXTURE VOLTS	APPROVED EQUALS
					TYPE	QUANTITY				
F1	GIGA TERA	NA-65-A-09-S-UL	INDUSTRIAL LINEAR LED SURFACE MOUNT FIXTURE. INDIRECT HIGH EFFICIENCY LIGHTING. MINIMUM 6,500 LUMENS AT 5,000K CCT AND >80 CRI. ALUMINUM HOUSING WITH CURVED POLYCARBONATE COVER AND WHITE REFLECTOR. DAMP LOCATION LISTED.	47"X7"X4"	NOMINAL 5,000K CCT LEDS AS PROVIDED BY MANUFACTURER	AS PROVIDED BY MANUFACTURER	AS PROVIDED BY MANUFACTURER	65	120	AS APPROVED BY ENGINEER
F2	JUNO INDY	L6-23-40-U-G2 L600HW-C-Q-WH	HYPERBOLIC SHAPE LED DOWNLIGHT. ALUMINUM HEAT SINK INCOOPERATED WITH HOUSING. DELIVERING MINIMUM 2,300 LUMENS AT MINIMUM OF 80 CRI AT 4,000K CCT. SUITABLE FOR INSTALLATION IN CEILINGS WITH THICKNESS OF UP TO 2"	4" X 6"	NOMINAL 4000°K 80 CRI LEDS AS PROVIDED BY MANUFACTURER	AS PROVIDED BY MANUFACTURER	AS PROVIDED BY MANUFACTURER	29	120	CREEK KR SERIES, OR AS APPROVED BY ENGINEER
F3	CREE	ZR24-40L-40K	RECESSED LED 2X4 TROFFER - 4,000 LUMENS WITH 90 CRI.	2'X4'	NOMINAL 4000°K 80 CRI LEDS AS PROVIDED BY MANUFACTURER	AS PROVIDED BY MANUFACTURER	AS PROVIDED BY MANUFACTURER	32	120	WILLIAMS LT. OR AS APPROVED BY ENGINEER
F4	HE WILLIAMS	LLMS-4-LED*UT41/840-S-RD-ED*UT-120/277	SINGLE UNIT LED WRAPAROUND WITH 22 GAUGE COLD ROLLED STEEL HOUSING WITH 92% REFLECTANCE WHITE POLYESTER POWDER COAT FINISH ELECTROSTATICALLY APPLIED AND BAKED AFTER FIXTURE FABRICATION. ROUNDED PROFILE EXTRUDED FROSTED ACRYLIC SNAP-IN DIFFUSER. FIXTURE SUITABLE FOR CEILING OR WALL MOUNTING. WITH TWO FIXTURE END PLATES TO FIRMLY SECURE DIFFUSER ENDS. NOMINAL 4100°K WHITE LEDS WITH GREATER THAN 80 CRI DELIVERING 4,100 INITIAL LUMENS.	4' X 1'	NOMINAL 4000°K 80 CRI LEDS AS PROVIDED BY MANUFACTURER	AS PROVIDED BY MANUFACTURER	AS PROVIDED BY MANUFACTURER	52	120	BARTCO BSS210 SERIES, CREE LS SERIES, LITHONIA WL4 SERIES
F5	HE WILLIAMS	75L-4-LED*PH20/840-A12125-VBY-2-EDD*PH-UNV	LED LENSED STRIP FIXTURE. 22-GAUGE DIE-FORMED C.R.S. HOUSING. ALL PARTS PAINTED AFTER FABRICATION. ACRYLIC #12 LENS. SUSPENDED MOUNT. PROVIDE WITH (2) Y HANGERS AND (2) Z CHAINS. COORDINATE MOUNTING LOCATION AND HEIGHT WITH OWNER. MINIMUM 2000 LUMENS AND AT LEAST 80 CRI AT 4,000K CCT.	4' X 1'	NOMINAL 4000°K 80 CRI LEDS AS PROVIDED BY MANUFACTURER	AS PROVIDED BY MANUFACTURER	AS PROVIDED BY MANUFACTURER	24	120	AS APPROVED BY ENGINEER
F6	PHILIPS GARDCO	121-MRM-WT-35LA-350-NW-UNV-BLP-PCB-MHS	EXTERIOR WALL MOUNT CUT-OFF LED LUMINAIRE. DIE-CAST ALUMINUM HOUSING WITH TEMPERED GLASS LENS ASSEMBLY AND STAINLESS STEEL FASTENERS. CLEAR SPECULAR ANODIZED ALUMINUM REFLECTOR. BRONZE POLYESTER POWDER COAT FINISH. UL LISTED FOR WET LOCATION. INTEGRAL PASSIVE INFRARED MOTION SENSOR CABABLE OF DETECTION MOTION WITHIN 24 FEET. MOTION SENSOR REDUCES SYSTEM WATTAGE TO 25% OF FULL OUTPUT WHEN NO MOTION IS DETECTED FOR 5 MINUTES. INTEGRAL PHOTOCCELL.	15.5" X 9.25" X 5.5"	NOMINAL 4000°K 75 CRI LEDS AS PROVIDED BY MANUFACTURER	AS PROVIDED BY MANUFACTURER	AS PROVIDED BY MANUFACTURER	35	120	LITHONIA WSQ SERIES, LSI XPWS3 SERIES, CREE XSP, OR AS APPROVED BY ENGINEER